

Ranking Criteria Responses (pg.15 of RFP)

1.b Purchase Plan. Oxford School offer

\$25,000.00

Full Name of Organization- Sherwood Building Co., Inc.650 Plymouth Ave. Fall River, MA 02721 Principle- Alex Stylos 2 Jordan Lane Freetown, MA 02717

- 2. Financial Institution- Mechanics Cooperative Bank letter of Financial support enclosed
- 3.a Economic Benefits- Our development plan has tax benefits to Town as we propose full property taxation within 3 years of ownership
- **3.b**. Indirect Benefits Community use of gymnasium through interested local non profits. Use of Cafeteria for Food Pantry. Re-use of classrooms for adult education and youth education.
- 4. Developer Experience Our experience in Historic restoration while bringing Former School building up to current State and Local Building Code is attached. As we currently own and have restored 3 schools within Fall River MA within the last 2 years. Our development experience includes (2) specific school building of the same time period as the Oxford (Connell School @ 650 Plymouth Ave. Fall River, MA circa 1893). Healy School @ 726 Hicks St. Fall River, MA (circa 1897)
- 5. Experience in Building Restoration:

Major Restoration projects by Sherwood Building Co., Inc.

1. Rob Roy hair academy South Main Street Fall River completed 2011.

- 2. Re-development of N. Underwood St. Fall River, (5) buildings including the re-use of former Portuguese sausage factory. Completed 7-1-15
- 3. Redevelopment of 146 Stewart Fall River MA (completed 3-1-15).
- 4. Re-development of 799 State Rd. Dartmouth, creating Minuteman Harley Davidson completed 2009- Amount \$2.85 million
- Historic Renovation and Restoration of 69 Rhode Island Ave. Newport RI, 1.3 million dollar project completed 5\ 2013.
- William Connell School Restoration, 650 Plymouth Ave., Fall River MA 12-1-14 to present circa 1893 Owned by Sherwood (plans included in submittal package).
- Susan B. Wixon School, 263 Hamlet St., Fall River, MA 02721. Historic Preservation of a 1914 Circa School Building and in short order received Occupancy for portion of facility for Argosy Charter School. 3-14 to 8-14. Owned by Sherwood (plans included in submittal package).
- Harriet T. Healy School Restoration 726 Hicks St., Fall River, MA, (plans included in submittal package). Owned By Sherwood Started 9-15, Restoring into Educational Facility.
- **6. Developer Financial Capacity to Design and Construct-** (3) Design examples are included in our design package.
- 7. Developer Financial Capacity to Manage Site: Sherwood Building co., Inc. President Alex Stylos Massachusetts Construction Supervisor License # o66954, Commonwealth of Massachusetts Department of Labor Standard Asbestos Supervisor License Number AS 901829
- 8. Preliminary Design Plans- our preliminary plan will be complete 12-15-15 Construction commencement approximately 2-15-2016
- **g. Priority for employment** will be given to Fairhaven residents for additional positions required for construction .
- 10. Short and Long Term vision. We will pursue the building to be completed in (2)stages, Addition open within 8 months of ownership and Historic section completed within 18 months. We will develop the Oxford school in Educational, recreational and Food Pantry service in conjunction of local non-profits with a strong background in delivering human services.
- **11.** Taxation method. Our development goal will have property fully taxed after 3 years of ownership.

References for Sherwood Building Co.,:

- 1. Glen Hathaway- Building Inspector City of Fall River, One Government Center Fall River, MA 02722 tel 508-324-2500
- 2. Dennis Raposa, Bentley Architects. 209 Bedford St., Fall River, MA tel 508-674-7600.
- 3. State Senator Michael Roderiques, One Government Center Fall River, MA 02722 tel 508-646-0650



Commonwealth of Massachusetts Department of Labor Standards

Heather E. Rowe, Director

Asbestos Supervisor

ALEXANDER A. STYLOS

Eff. Date 04/16/15 Exp. Date 04/16/16 AS901829 Member of C.O.N.E.S.

Vember of C.O.N.E.S.

NBN NB-NEW





Massachusetts - Department of Public Safety Board of Building Regulations and Standards


Construction Supervisor


License: CS-066954

ALEXANDER A STYLOS 2 Jordan Lane East Freetown MA 02717

The Help DITE IN

Expiration 04/28/2017

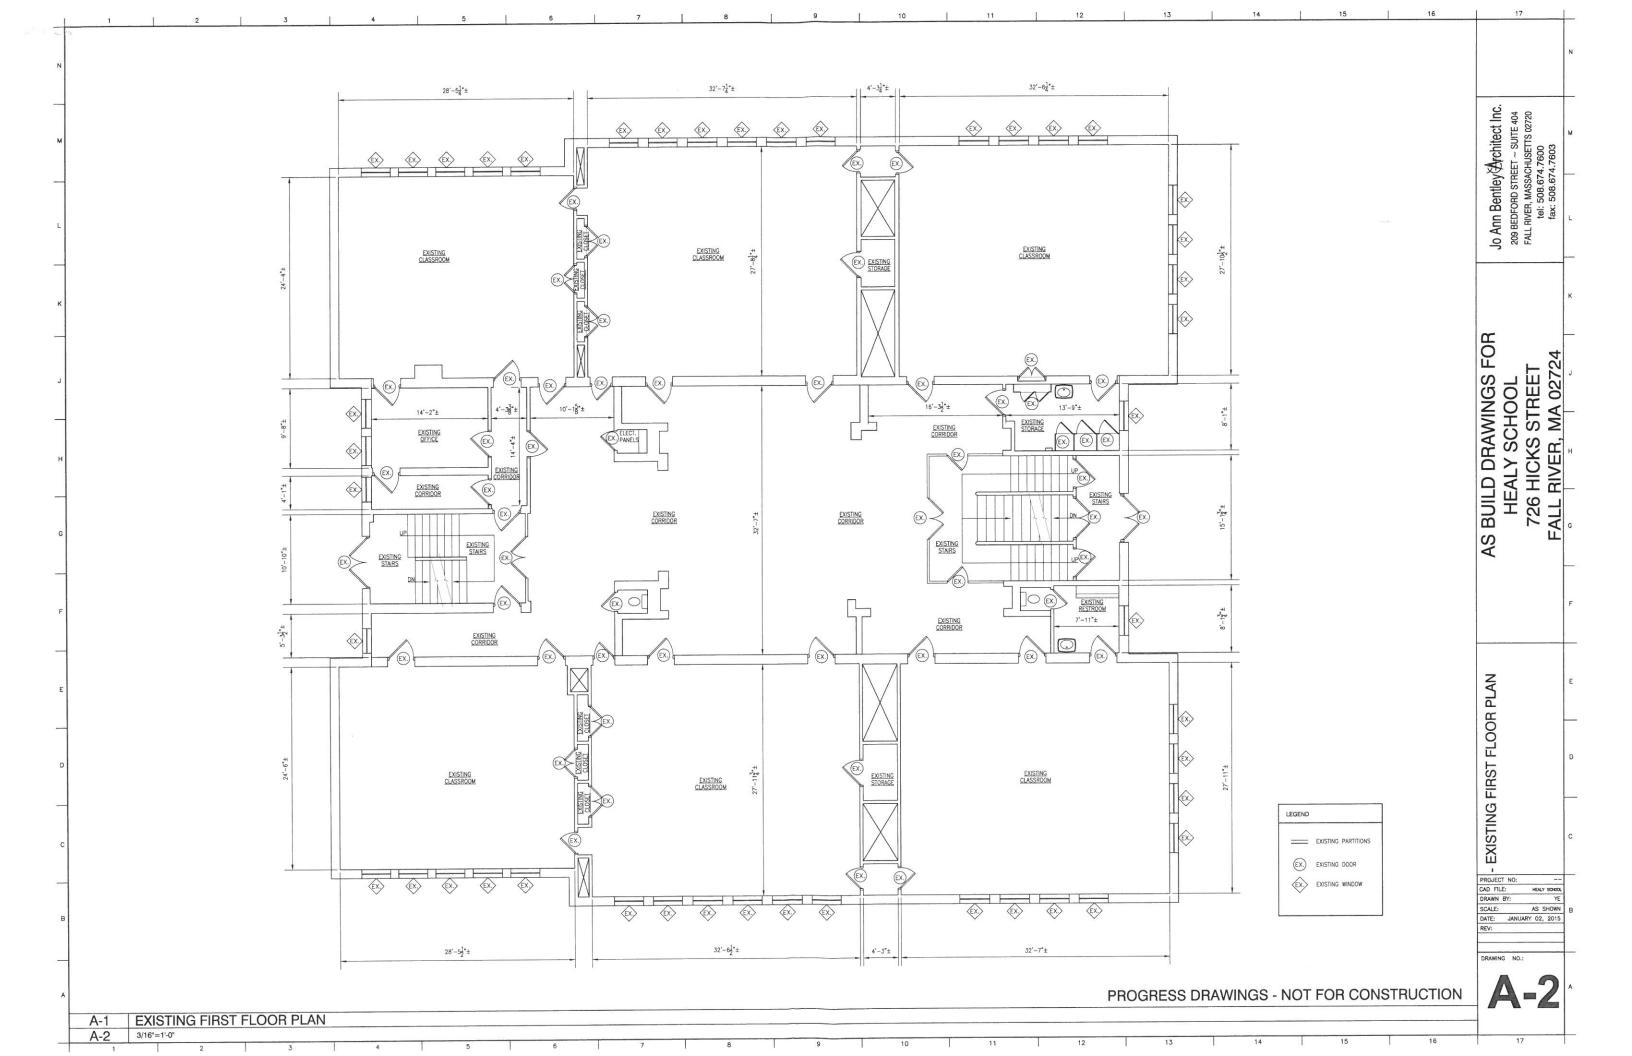

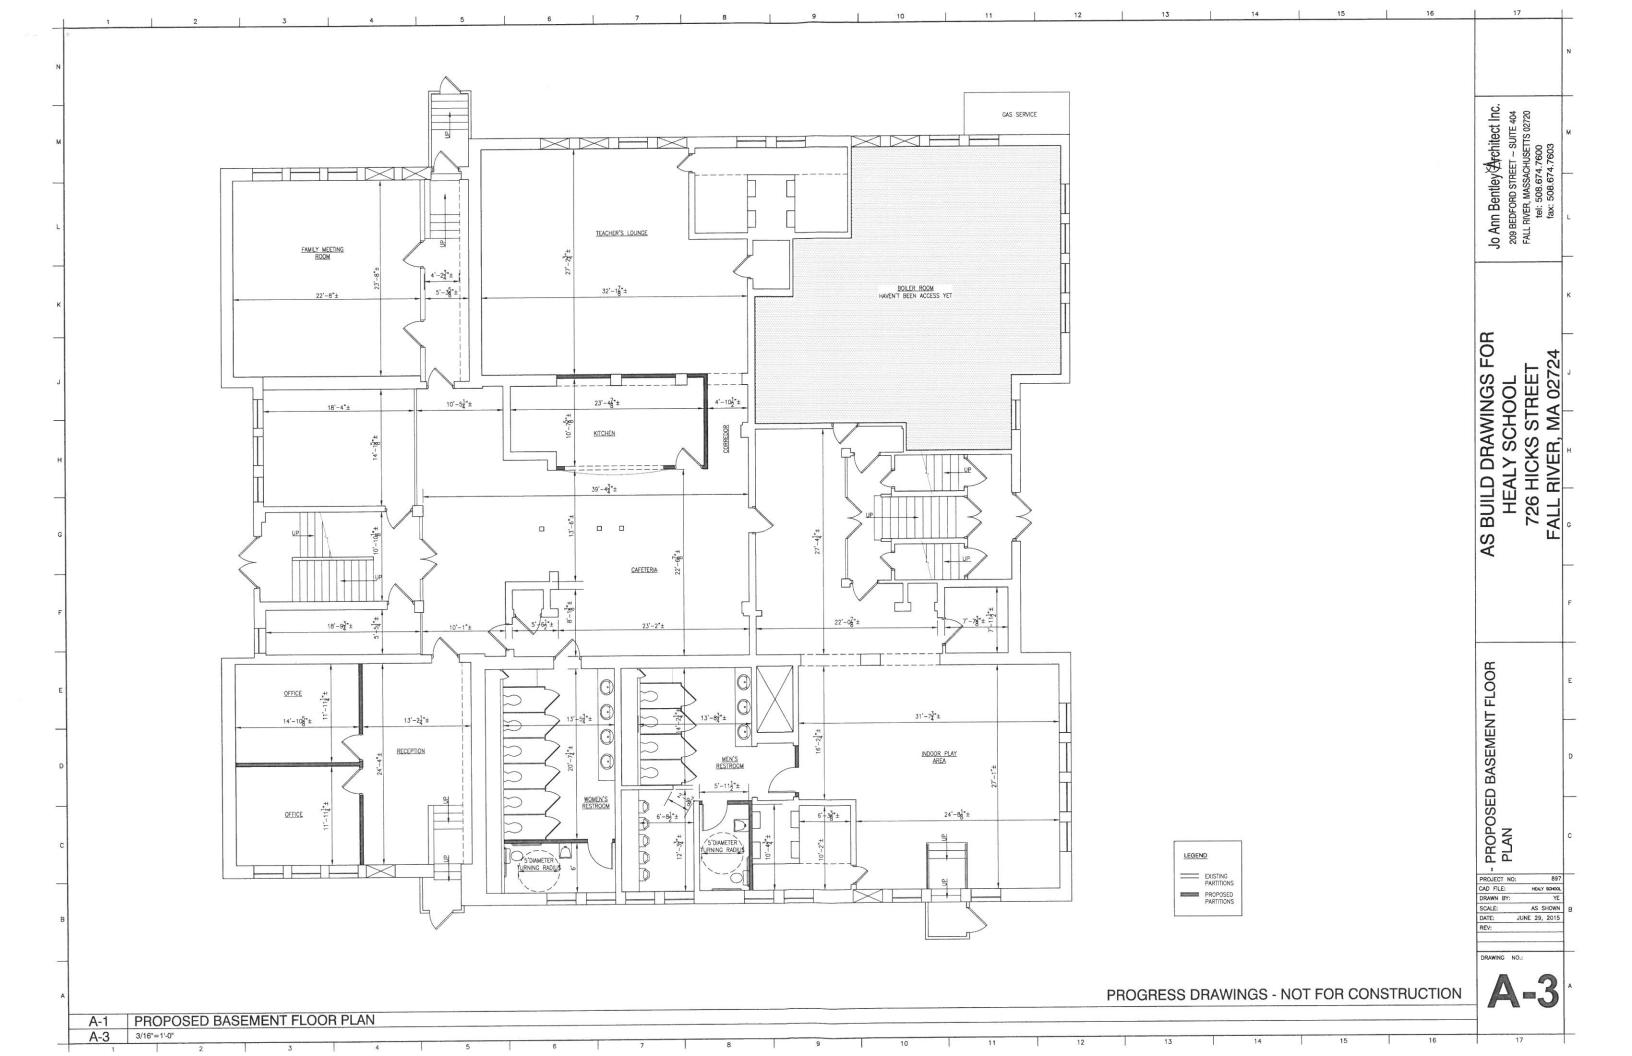

PROPOSED ELEVATOR & HOIST WAY GENERAL IV. FOUNDATIONS & FOOTINGS THE GENERAL CONTRACTOR SHALL BE RESPONSIBLE FOR CONTACTING "DIG SAFE" AS WELL AS ALL APPROPRIATE AGENCIES AND MUNICIPALITIES TO AVOID DAMAGE TO UNDERGROUND UTLITIES PRIOR TO THE STRAT FOR ANY SITE WORK.

2. BOTTOMS OF ALL FOOTINGS SHALL BE 4"—0" MINIMUM BELOW FINISH GRADE. AT WIXON SCHOOL 1, ALL WORK SHALL CONFORM TO THE 2009 IBC WITH MASSACHUSETTS AMENDMENTS. 2. IT IS THE RESPONSIBILITY OF THE GENERAL CONTRACTOR TO VERIFY ALL EXISTING CONDITIONS AND DIMENSIONS AS THEY RELATE TO NEW CONSTRUCTION. REPORT THE ARCHITECT/ENGINEER ALL OBSERVATIONS AND ANY DISCREPANCIES BEFORE 2. BOTTOMS OF ALL FOOTINGS SHALL BE 4'-0" MINIMUM BELOW FINISH GRADE.
3. FOOTINGS SHALL BE STEPPED AT A MAXIMUM SLOPE OF 2 HORIZONTAL TO 1 VERTICAL,
UNLESS NOTED OTHERWISE (SEE TYPICAL DETAILS)
4. ALL FOUND. WALLS SHALL BE BACKFILLED AFTER 28 DAYS OF CONCRETE PLACEMENT.
(THIS TIME MAY BE REDUCED IF A HIGH EARLY STERVOTH CONCRETE IS SUBSTITUTED
PER APPROVAL OF THE ARCHITECT/ENGINEER, OR IF THE WALL IS ADEQUATELY BRACED)
DURING BACKFILL OPERATIONS OF ALL FOUNDATION WALLS, THE FILL ON EITHER SIDE
OF THE WALL SHALL NOT EXCEED A 2'-0" DIFFERENTIAL, UNLESS THE WALL IS DESIGNED
FOR RETAINING ACTION. **263 HAMLET STREET** 3. SUBMIT SHOP DRAWINGS FOR APPROVAL (FOR ALL TRADES INDICATED HEREIN). DFORD STREET ~ SUITE 204 /ER, MASSAHCUSETTS 02720 tel: 508.674.7600 fax: 508.674.7603 DESIGN LOADS

1. ROOF LOAD (SNOW LOAD) _____ 45 PSF FALL RIVER, MA. 02720 Bentley Architect 2. FLOOR LIVE LOADS — LIGHT: 125 PSF HEAVY: 250 PSF PER INTERNATIONAL BUILDING CODE, 2012 EDITION: ZONE 3, V=110 MPH, EXPOSURE B. V. ELEVATOR

1. ALL ELEVATOR COMPONENTS MUST CONFORM TO 524 CMR INCLUDING BUT NOT LIMITED TO HYDRAULIC DRIVE, MAST, PLATFORM, CONTROLS & SWITCHES, DOOR ASSEMBLES, LOCKS & KEYS AND GRAB RAILS. ALL COMPONENTS ARE TO BE DESIGNED AND SUPPLIED BY THE ELEVATOR MANUFACTURER AND INSTALLED BY THE GENERAL CONTRACTOR.


2. THE ELEVATOR ASSEMBLY IS TO BE INSTALLED IN ACCORDANCE WITH ALL APPLICABLE CODES AND REGULATIONS AND ELEVATOR MANUFACTURER'S REQUIREMENTS. SHOP DRAWINGS ARE TO BE FOR REVIEW AND APPROVAL.


3. ELEVATOR COLORS, FINISHES, MATERIALS, ETC. TO SELECTED BY OWNER.


4. G.C. TO SUPPLY AND INSTALL ALL REQUIRED ELECTRICAL & MECHANICAL COMPONENTS. G.C. TO COORDINATE WITH THE ELEVATOR MANUFACTURER. 1. ALL CONCRETE WORK SHALL CONFORM TO ACI 318 AND 301 REQUIREMENTS.
THIS SHALL INCLUDE PROPORTIONING OF CONCRETE MIX, CONCRETE TESTING, PLACEMENT
OF CONCRETE, AND CURING PROCEDURES.
2. CONCRETE SHALL HAVE THE FOLLOWING 28 DAY COMPRESSIVE STRENGTH: a) FOOTINGS & FOUND. WALLS BELOW GRADE ____ 3000 PSI b) SLABS _____ 4000 PSI Ann c) ALL OTHER CONCRETE ____ 209 FALL 9 5. CONCRETE REINFORCING SHALL BE IN ACCORDANCE WITH ASTM A615 AND HAVE THE FOLLOWING MINIMUM YIELD STRENGTH: VI. MECHANICAL, ELECTRICAL, PLUMBING, FIRE ALARM, COMMUNICATIONS


1. ALL MECHANICAL, ELECTRICAL, PLUMBING AND FIRE ALARM WORK ARE TO BE DESIGN/BUILD BY THE OWNER AND INSTALLED BY PROFESSIONALS LICENSED IN THE STATE OF MASSACHUSETTS.

2. DEDICATED TELEPHONE LINE TO THE ELEVATOR ASSEMBLY TO BE DESIGN/BUILD BY THE OWNER. a) MAIN REINFORCING STEEL 60 KSI b) TIES & STIRRUPS 40 KSI 6. WELDED WIRE FABRIC SHALL BE IN ACCORDANCE WITH ASTM A185. WAY D ELEVATOR & HOIST W F WIXON SCHOOL B HAMLET STREET FALL RIVER, MA c) SLABS ON GRADE (WWF) (SEE TYPICAL DETAILS) 8. MAXIMUM CONCRETE WALL LENGTHS BETWEEN CONSTRUCTION JOINTS SHALL BE 60 FEET. 9. REINFORCING LAP SPLICES SHALL BE IN ACCORDANCE WITH ACL—318—55 FOR TENSION LAP SPLICES, CLASS B, UNLESS NOTED OTHERWISE. HORIZONTAL REINFORCING IN PERIMETER WALLS SHALL BE LAPPED 24" MINIMUM. 10. PROVIDE CORNER BARS AT ALL WALL CORNERS & INTERSECTIONS MATCHING HORIZONTAL REINFORCEMENT WITH 2'-6" MINIMUM LAPS. 11. INTERIOR FLOOR SLAB TO BE POURED IN ONE DAY. THE SLAB WILL HAVE A STANDARD 12. EXTERIOR CONCRETE DOOR PADS AND VEHICLE ACCESS PADS WILL HAVE A BRUSHED FINISH. PROPOSED F AT V 263 F **GENERAL NOTES** G-8 PROJECT TITLE T-1 NOT TO SCALE CODE COMPLIANCE DWG. TITLE REVISION T-1 Title Sheet, General Notes, Locus Map, Locus Plan & Code Compliance Data Base Code: 2009 International Building Code with Massachusetts Amendments Reference A-1 Existing Conditions/Demolition Plans, Section & Demolition Notes (E) Educational SECTION 305 Occupanc (E) Educationa Classification A-2 Proposed Plans, Key Notes & Section Construction Туре 3В SECTION 602.3 A-3 Roof Plan, Roof Framing Plan, Sections & Details Classification A-4 Proposed Exterior Elevations, Key Notes, Door Elevations & Schedules, Details Minimum Fire Resistance of E-10 LIST OF DRAWINGS Structural Frame T-1 NOT TO SCALE - TITLE SHEET - GENERAL NOTES, - LOCUS MAP & LOCUS PLAN - CODE COMPLIANCE DATA Nonbearing Walls and Partitions Floor Construction Roof Construction 14 500 s f TABLE 503 increase due to 58,000 s.f. Sprinkler Building Height 55 feet TABLE 503 PARKING Number of Stories TABLE 503 Maximum Occupant 20 Net TABLE 1004.1.1 Surgical, Inc. (Classroom Area) = 13, 893 s.f **EXISTING** BUILDING 50 Net Other Areas = 544 AD FILE: WIXON SCHOOL ELE (Shops & other vocational room Total = 1,239 areas) = 27,172 s.f. Occupants TABLE 1016.1 APRIL 8, 2015 Peckham St Distance 250 feet (with sprinklers) AREA OF SECTION 1005.1 WORK RAWING NO. Number of Exits WHIPPLE STREET LOCUS MAP A-6 CODE COMPLIANCE DATA A-10 LOCUS PLAN NOT TO SCALE T-1 T-1

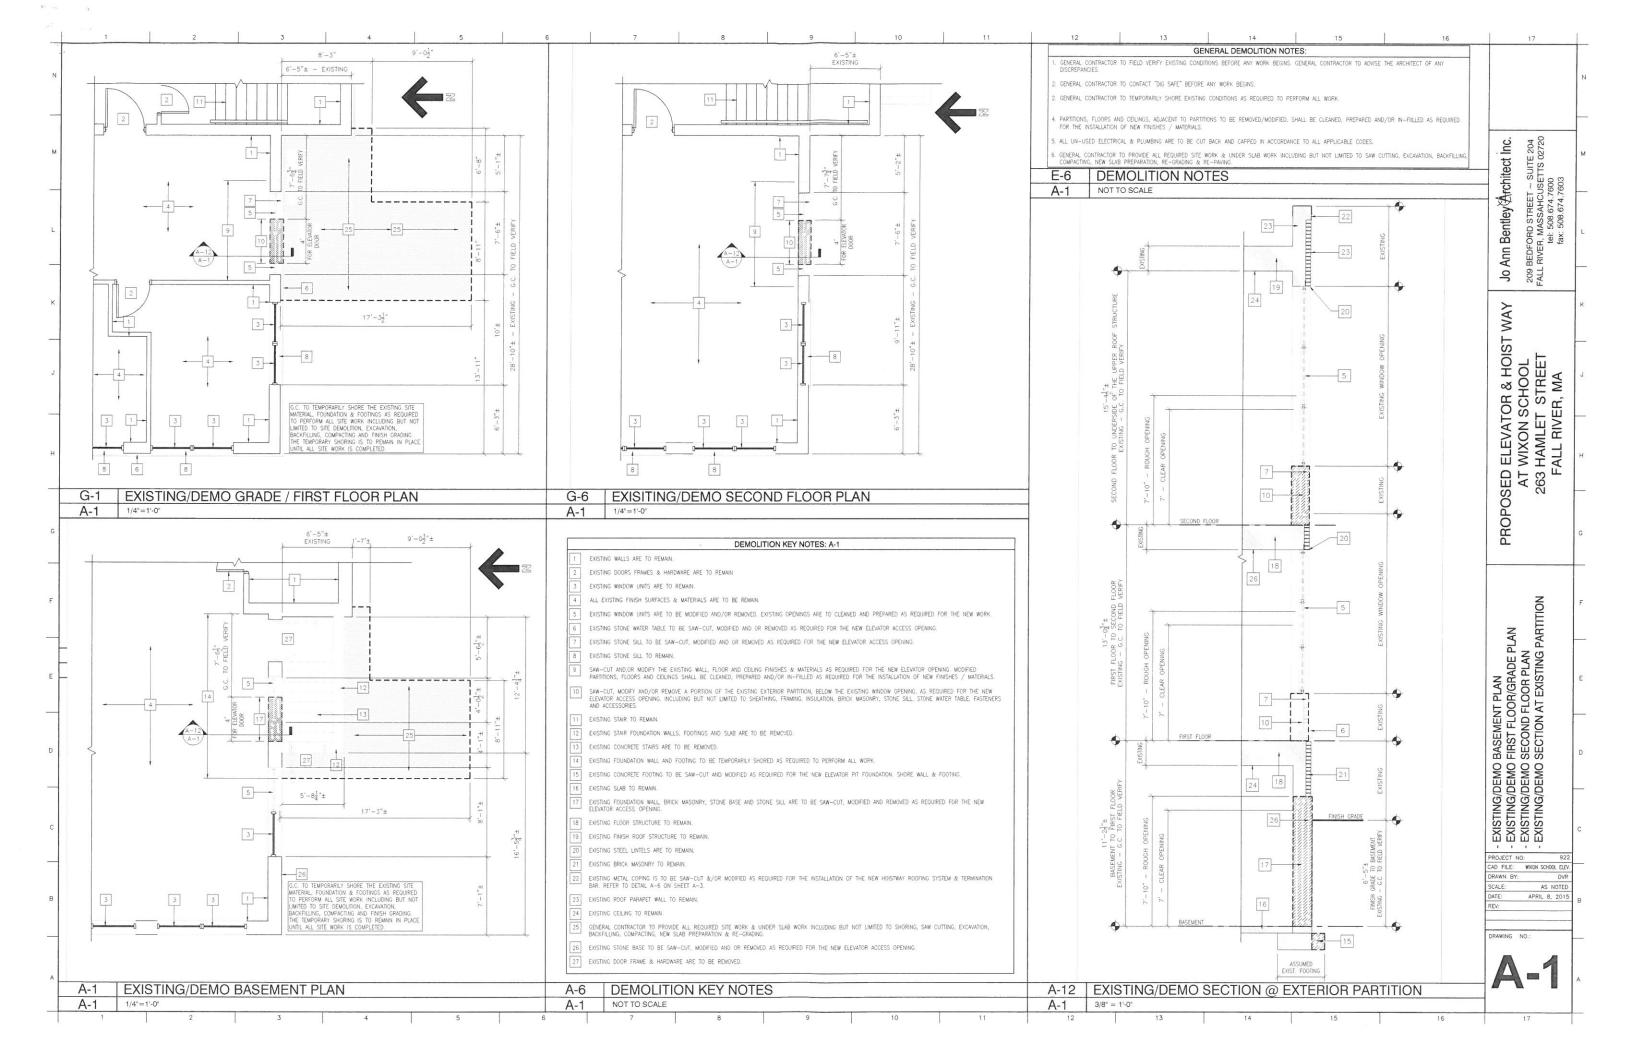

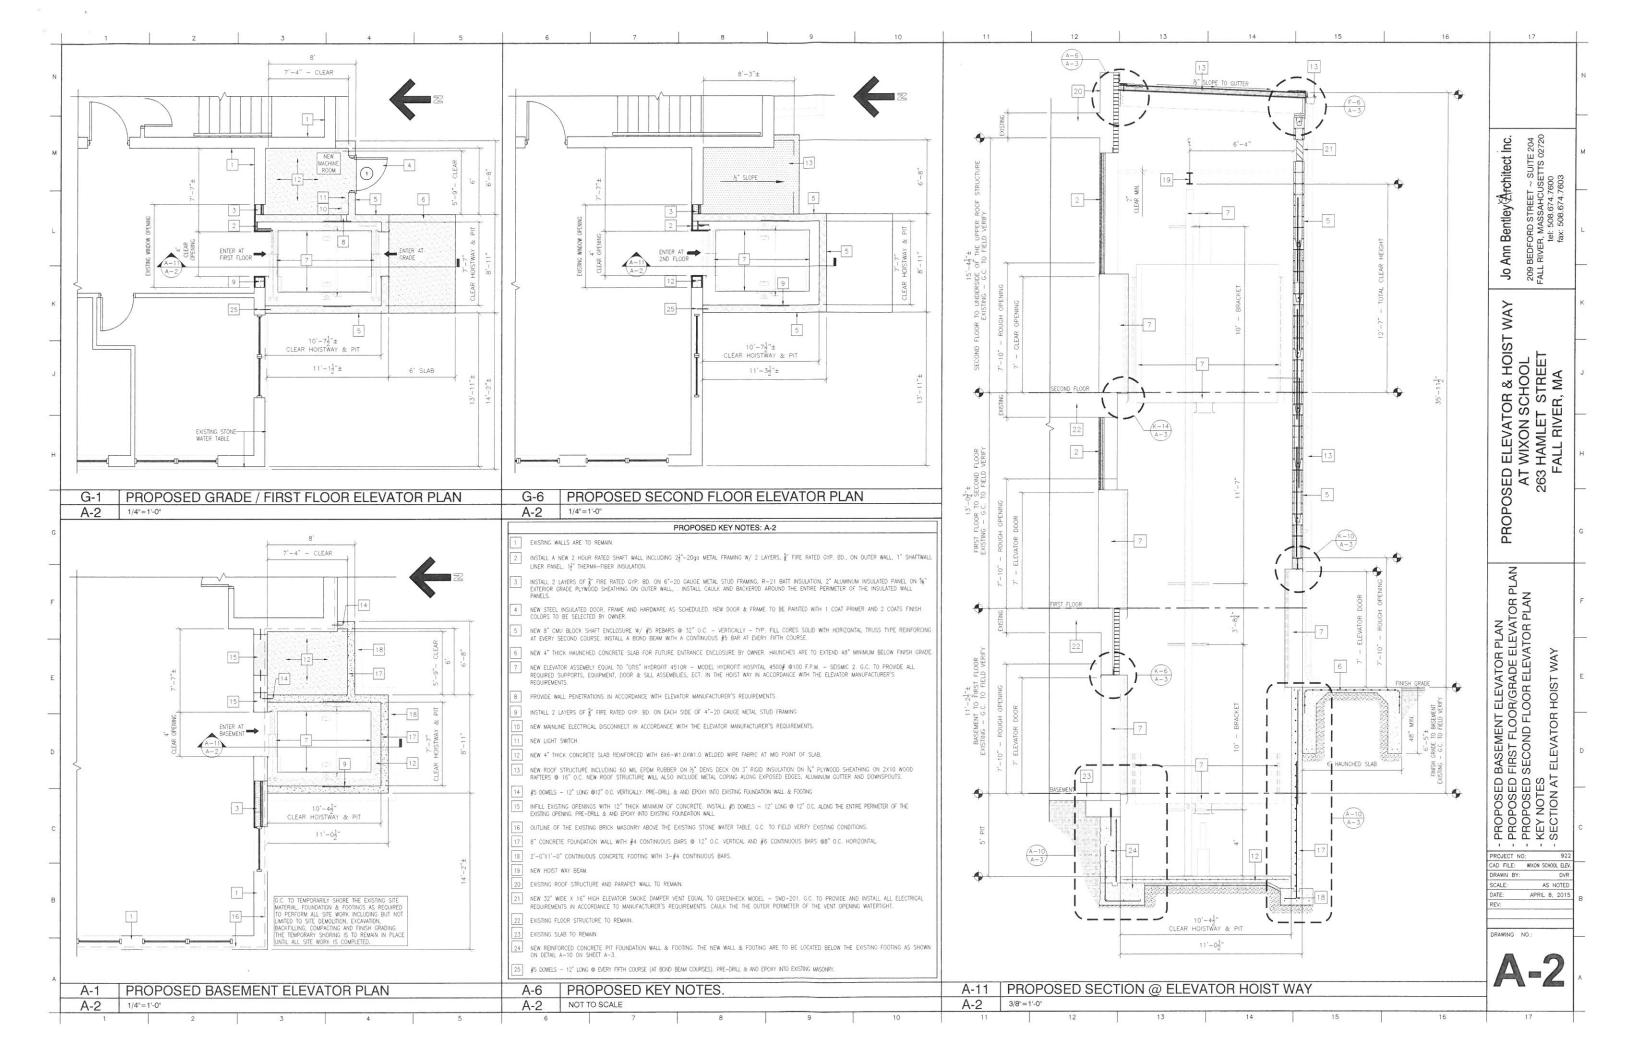


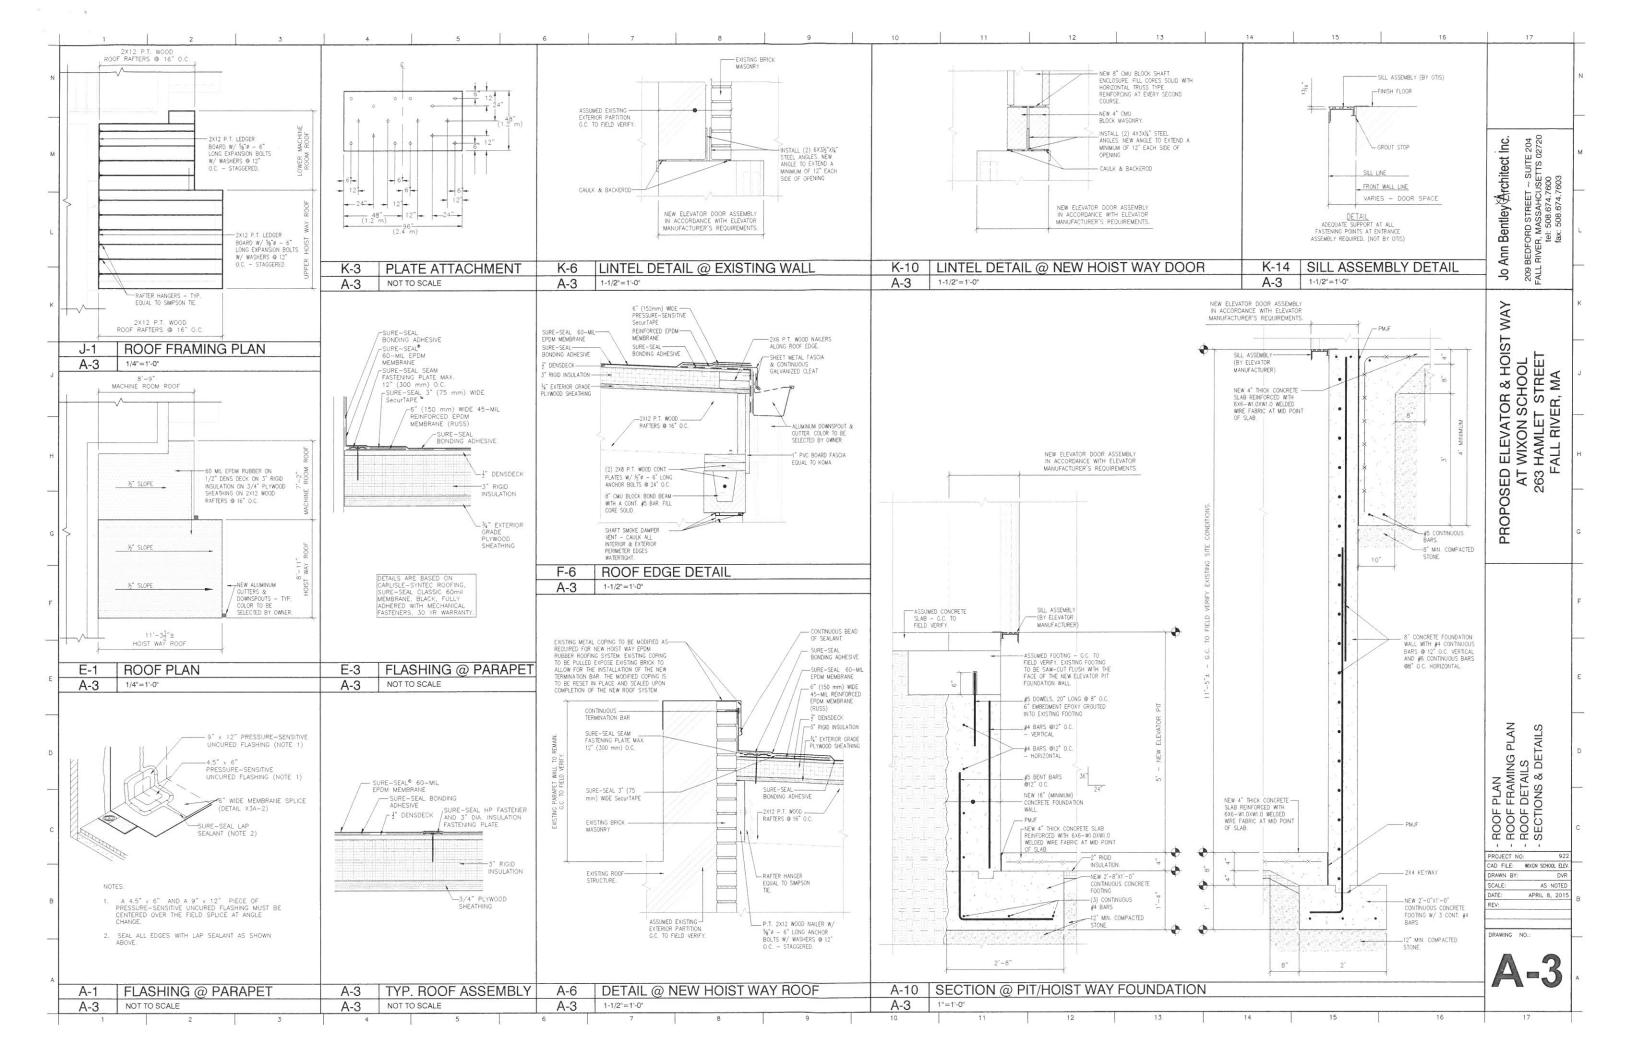


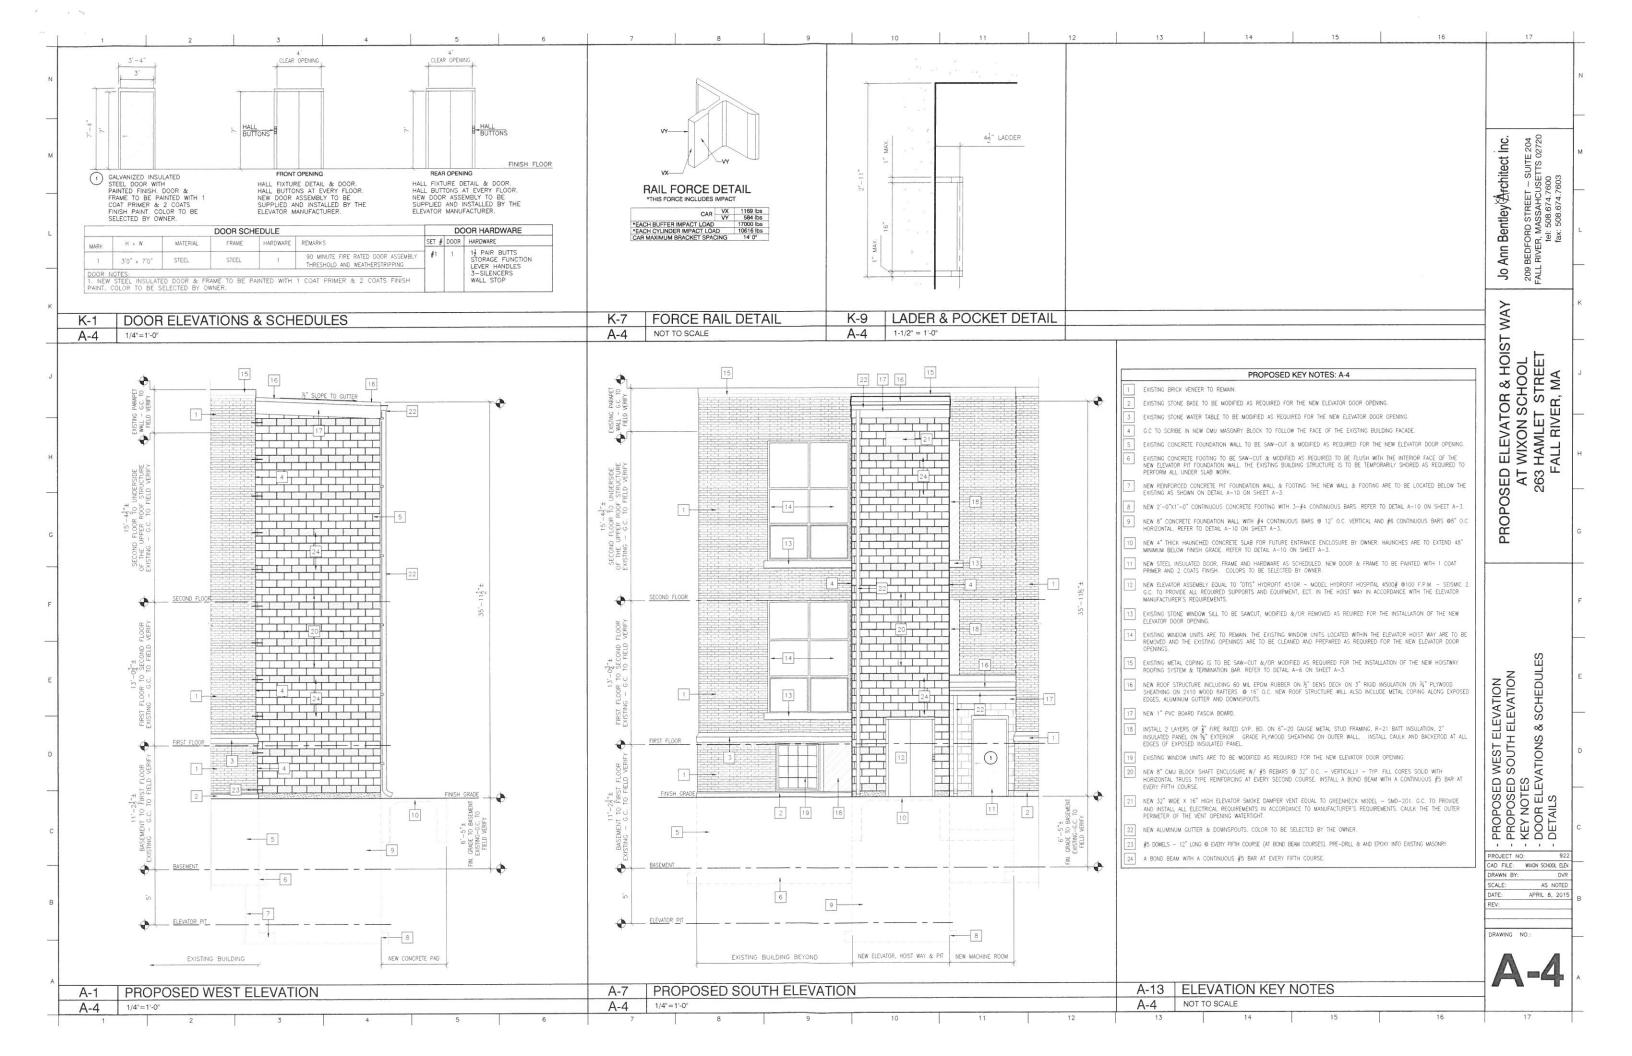



PROPOSED INTERIOR RENOVATIONS AT WIXON SCHOOL


263 HAMLET STREET FALL RIVER, MASSACHUSETTS Jo Ann Bentley Architect Inc.

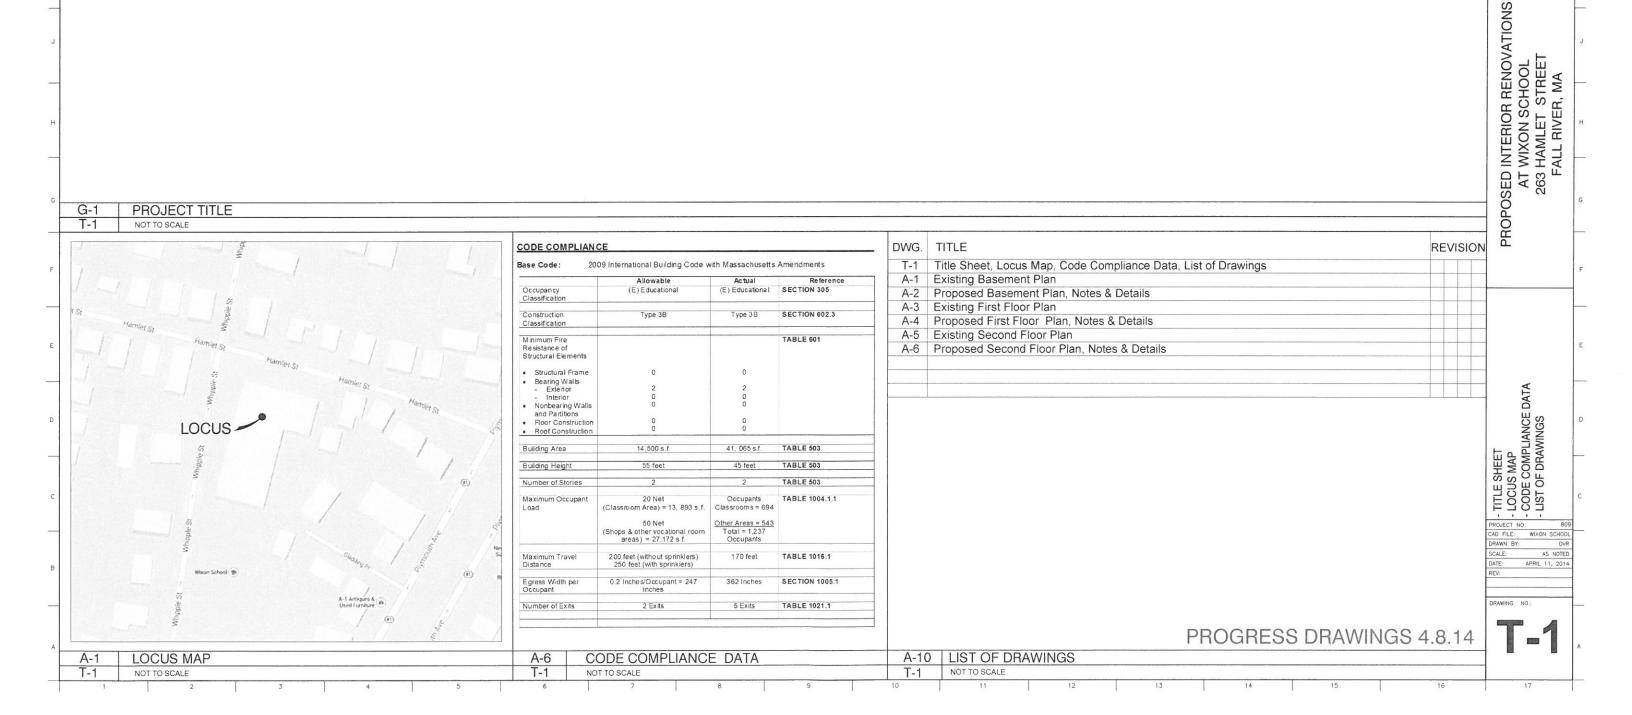


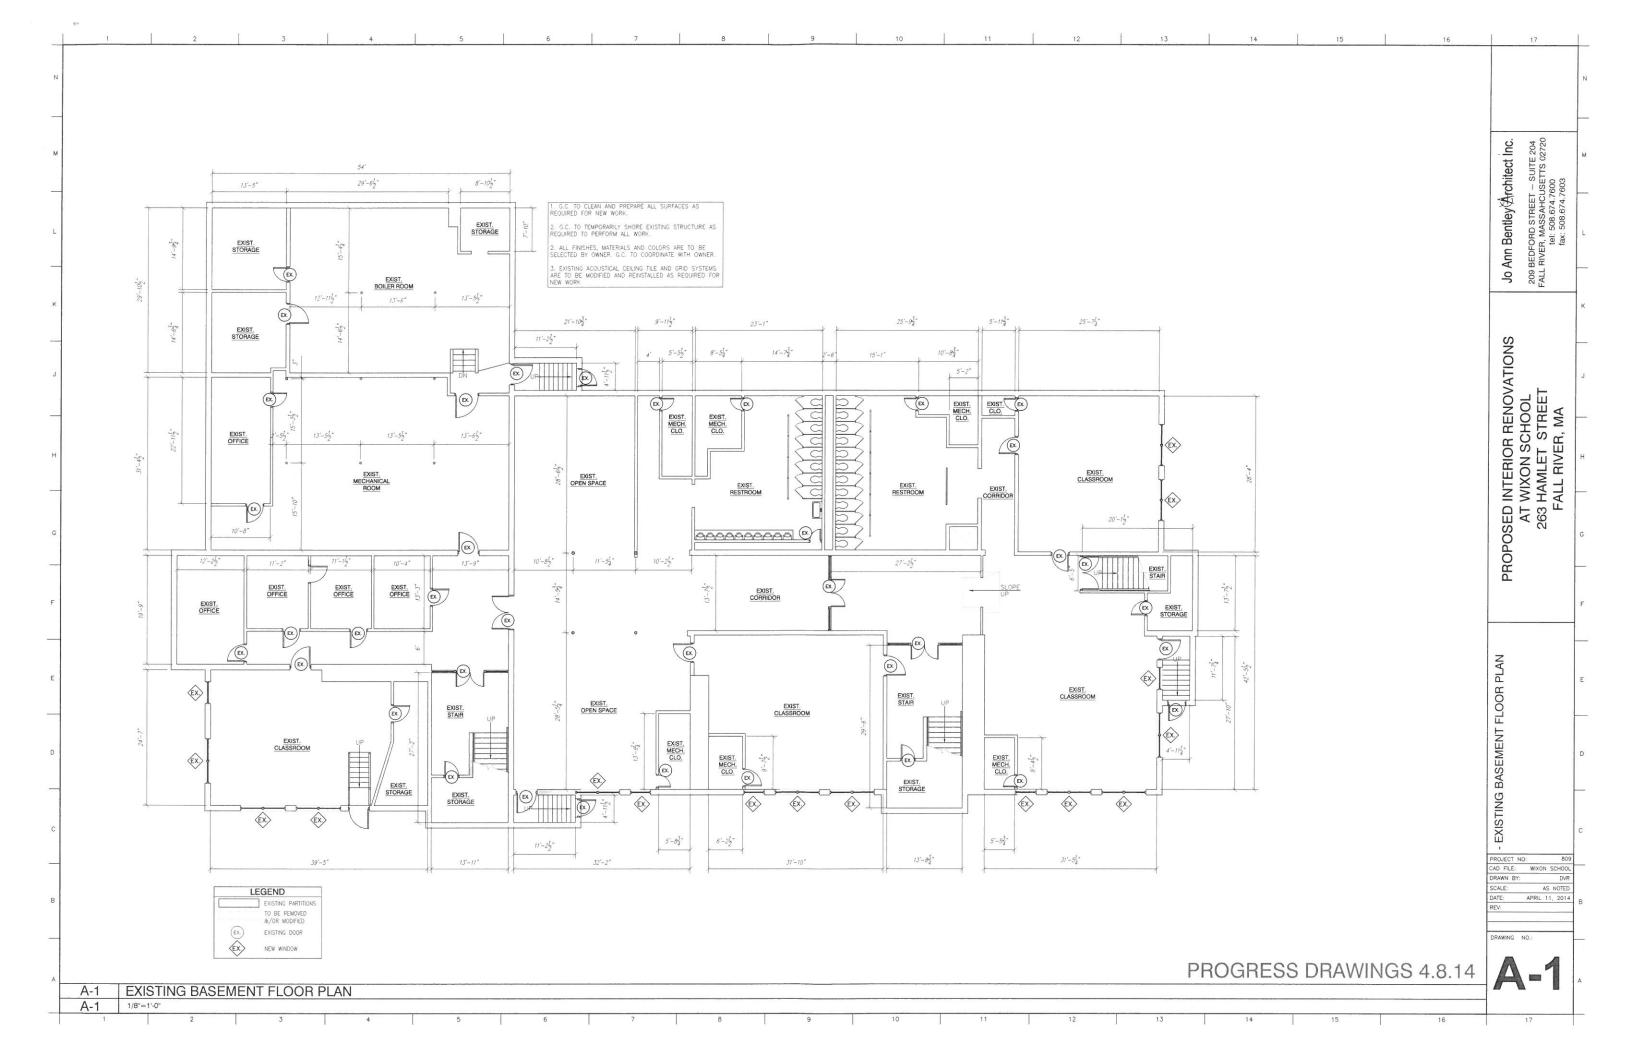


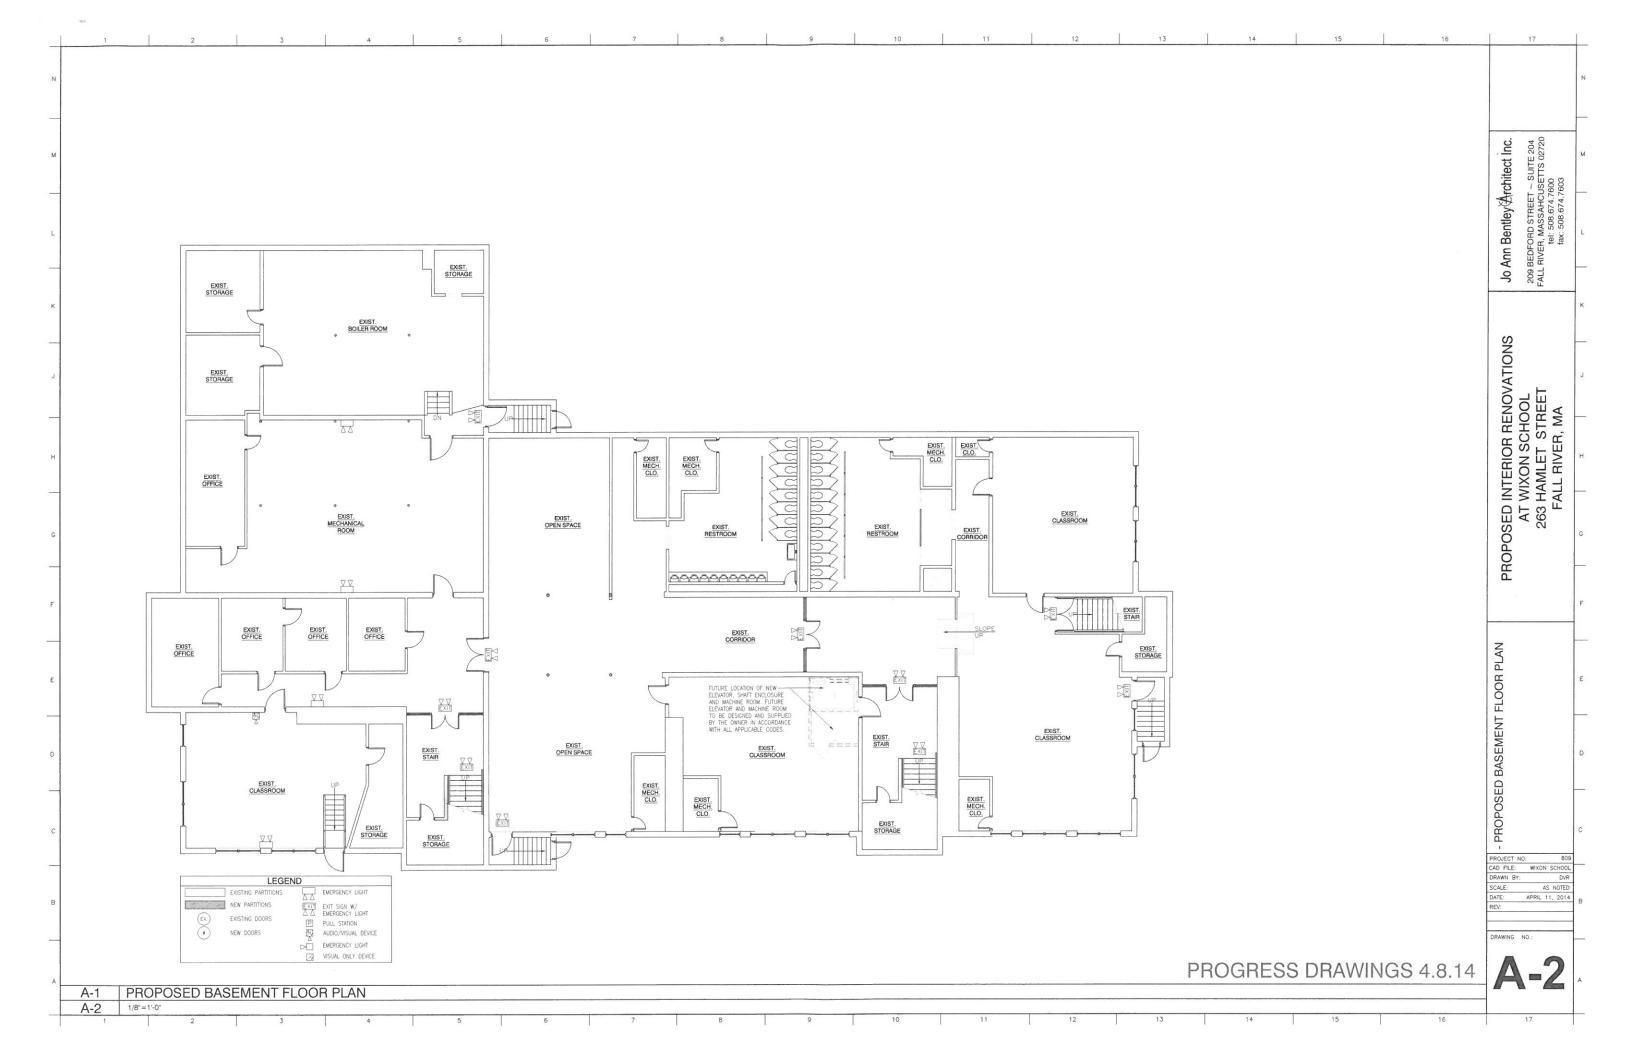

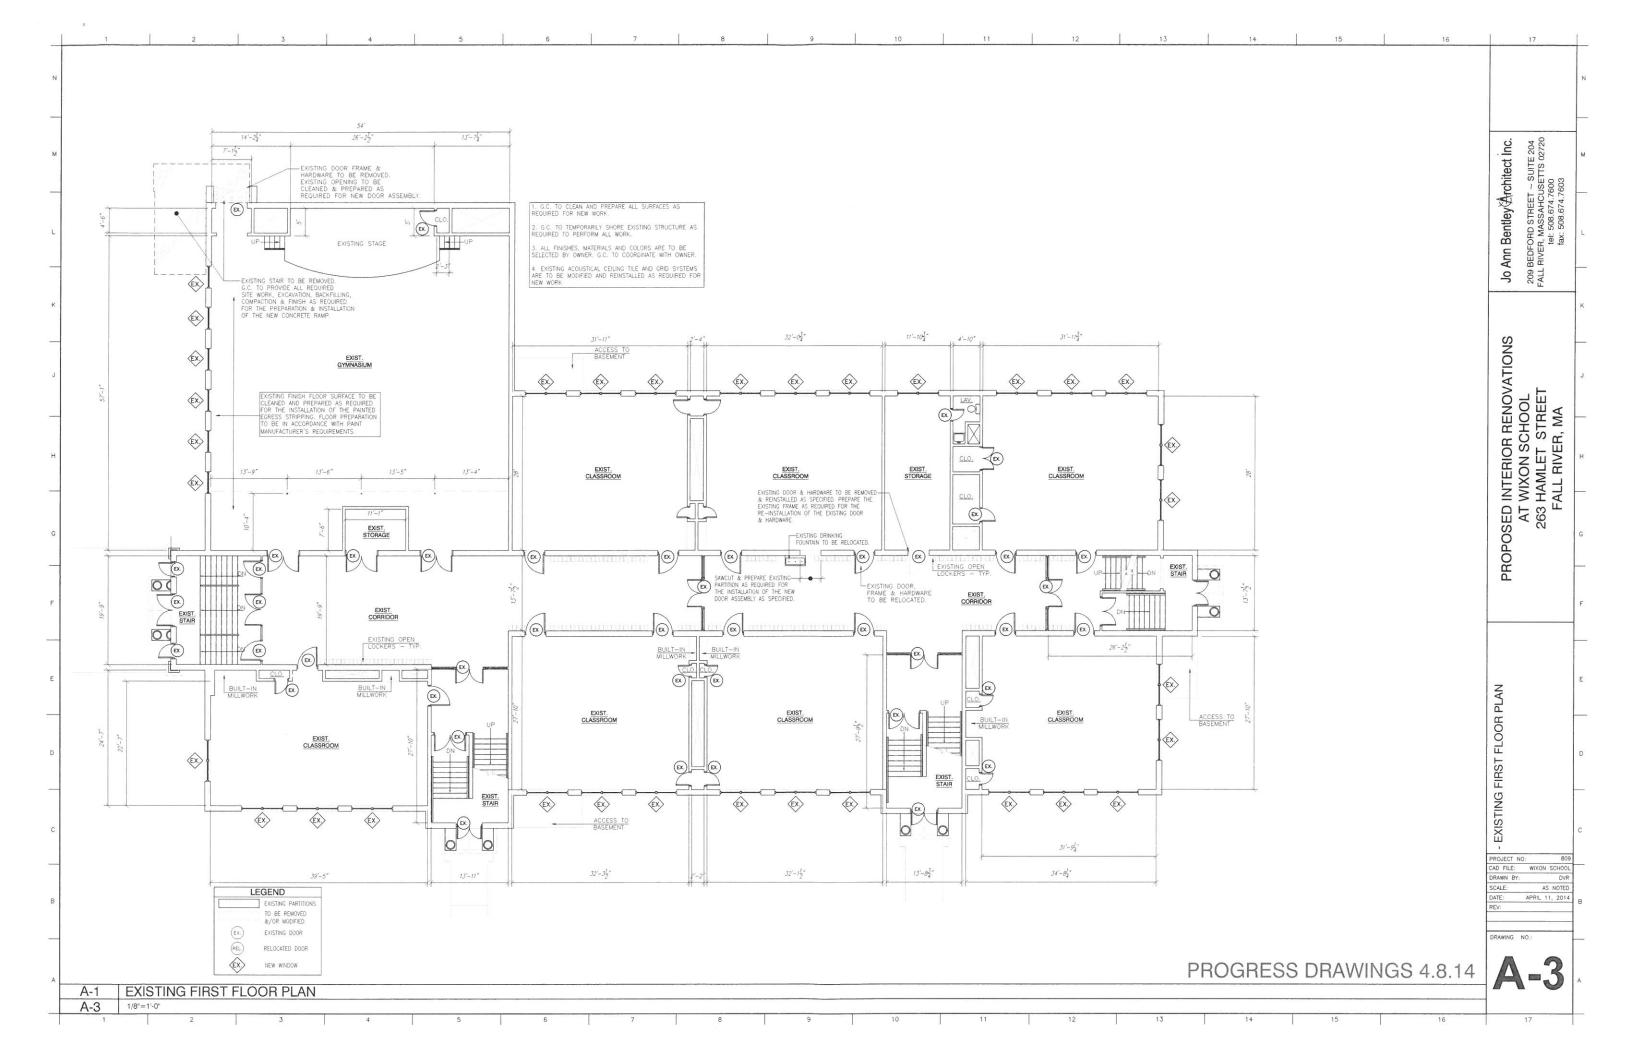

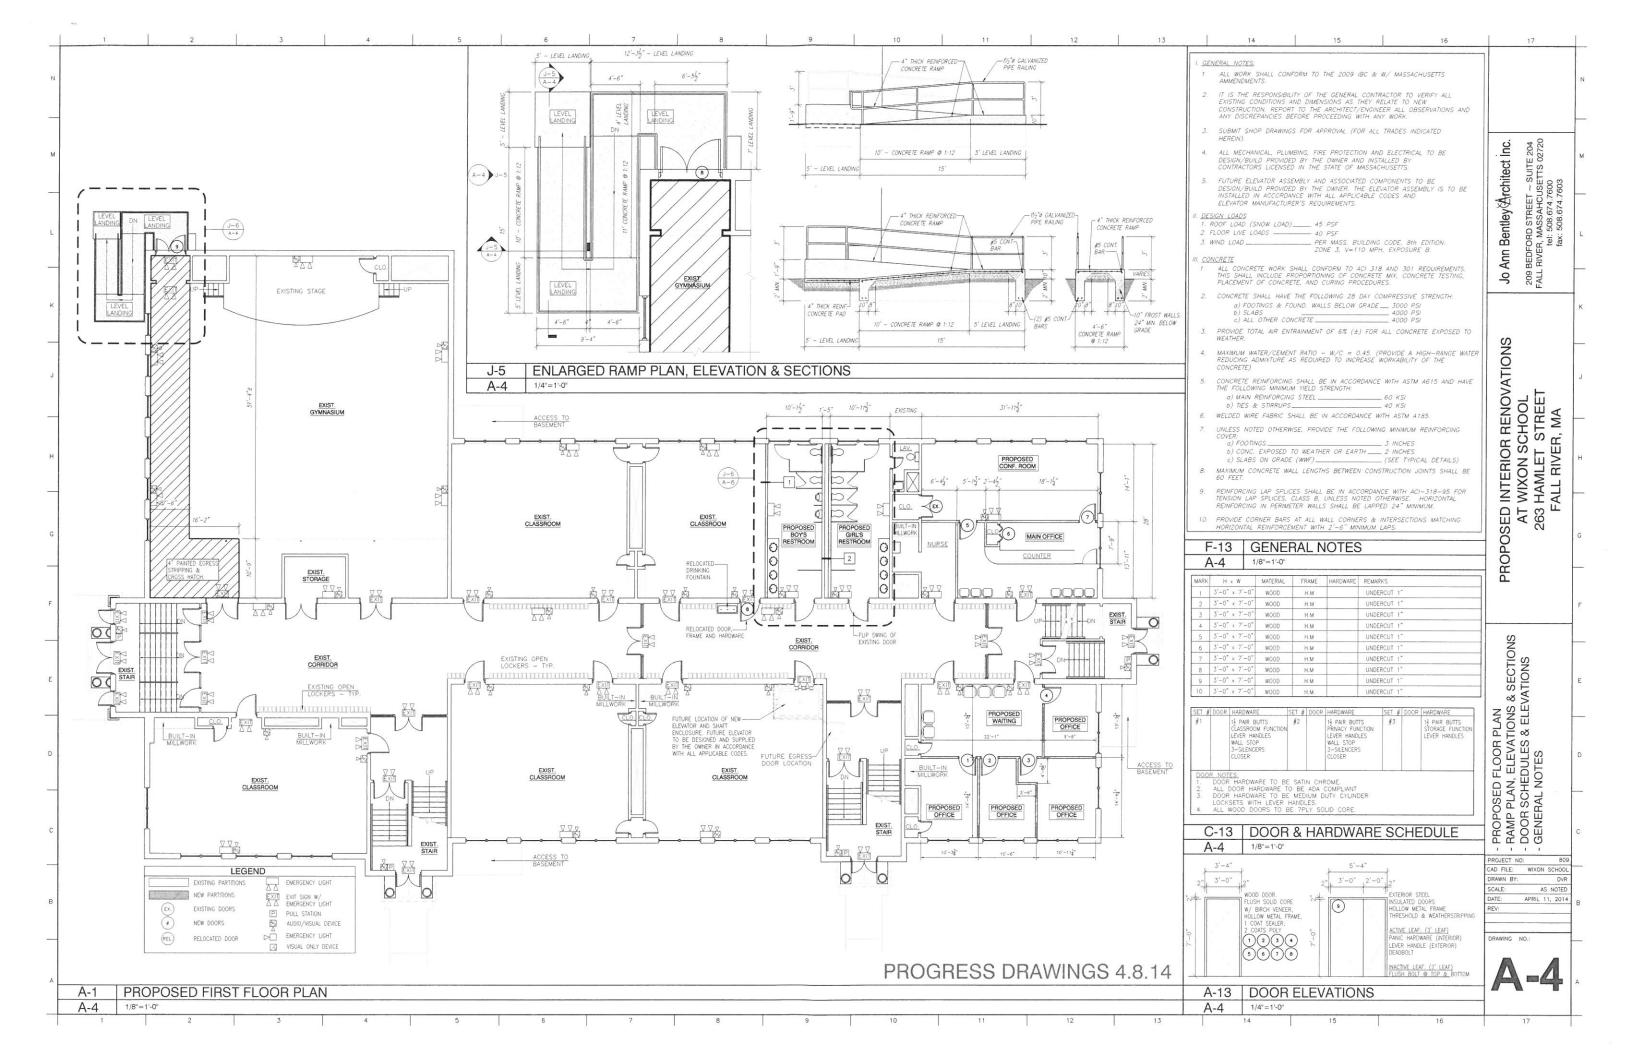

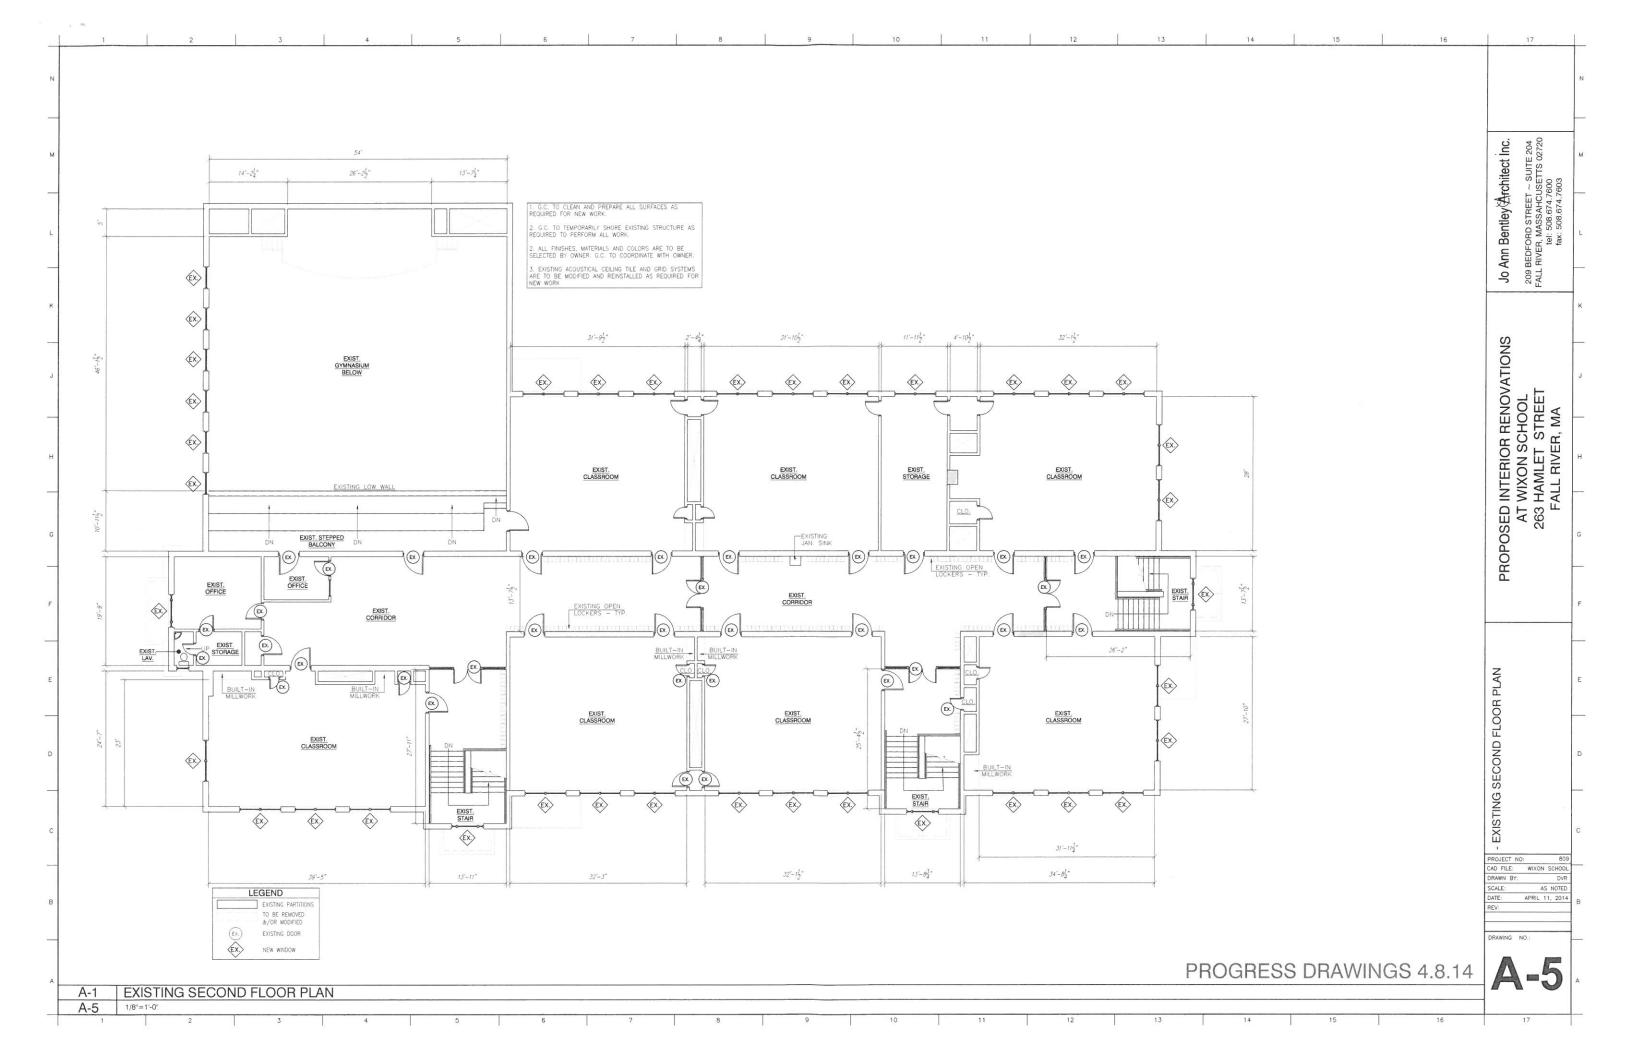

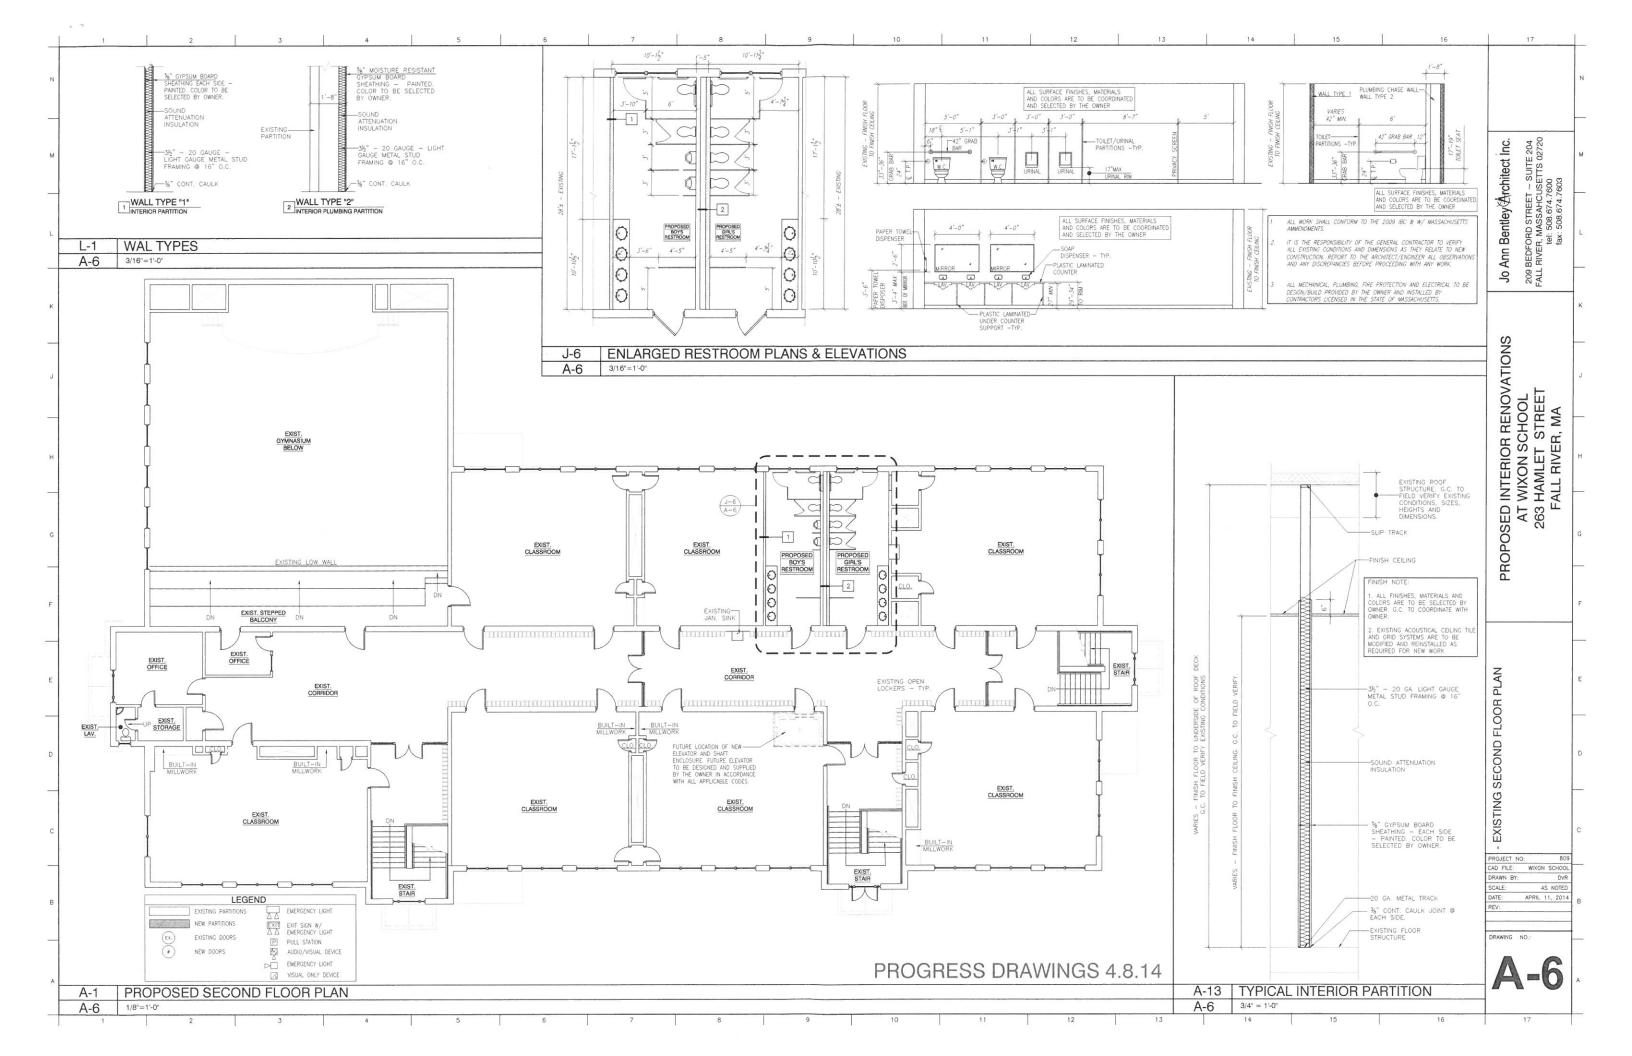

LOCUS MAP



LIST OF DRAWINGS

- 00 COVER SHEET
- 01 CODE SUMMARY
- 02 EXISTING/ DEMO BASEMENT AND FIRST FLOOR PLAN
- 03 EXISTING/ DEMO SECOND FLOOR PLAN
- 04 BASEMENT FLOOR PLAN AND DETAILS
- 05 FIRST FLOOR PLAN
- 06 SECOND FLOOR PLAN AND WALL TYPE
- S1.0- FIRST FLOOR FRAMING PLAN
- S2.0- PARTIAL 2ND FLOOR FRAMING PLAN AND SECTIONS

PROPOSED INTERIOR FIT-UP AT THE CONNELL SCHOOL

650 PLYMOUTH AVENUE FALL RIVER, MA 02721


-GENERAL CONDITIONS AND NOTES-

- THE OWNER WILL CONTRACT SEPARATELY FOR FIRE PROTECTION MORK WHICH WILL INCLIDE ENGINEERING, PERMITTING, INSTALLATION TESTING AND INSPECTIONS. THE GENERAL CONTRACTOR SHALL COORDINATE THE MORK OF THE OWNER'S SPRINKLER CONTRACTOR.
- THE OWNER WILL CONTRACT SEPARATELY FOR FIRE ALARM WORK WHICH WILL BE TIED INTO THE ENISTING SYSTEM. THE GENERAL CONTRACTOR SHALL COORDINATE THE MORK OF THE OWNER'S FIRE ALARM CONTRACTOR.
- THE OWNER WILL CONTRACT SEPARATELY FOR MECHANICAL, ELECTRICAL AND PLUMBING WHICH WILL INCLIDE ENGINEERING, PERMITTING, INSTALLATION, TESTING AND INSPECTIONS.
- 4. ALL REQUIRED LIFE SAFETY SIGNAGE TO BE SUPPLIED AND INSTALLED BY OWNER. SIGNAGE SHALL COMPLI WITH 2010 ADA STANDARDS AND IDE 2010 (III.01). SIGNS SHALL HAVE A NON-SLARE FINISH, CHARACTERS AND SYMBOLS SHALL CONTRAST WITH THEIR BACKGROUND.
- THE TESTING, REMOVAL AND DISPOSAL OF ALL HAZARDOUS MATERIAL IS TO BE COMPLETED BY THE OWNER IN ACCORDANCE WITH ALL APPLICABLE GENERAL LAWS AND REGULATIONS.

AUGUST 15, 2014





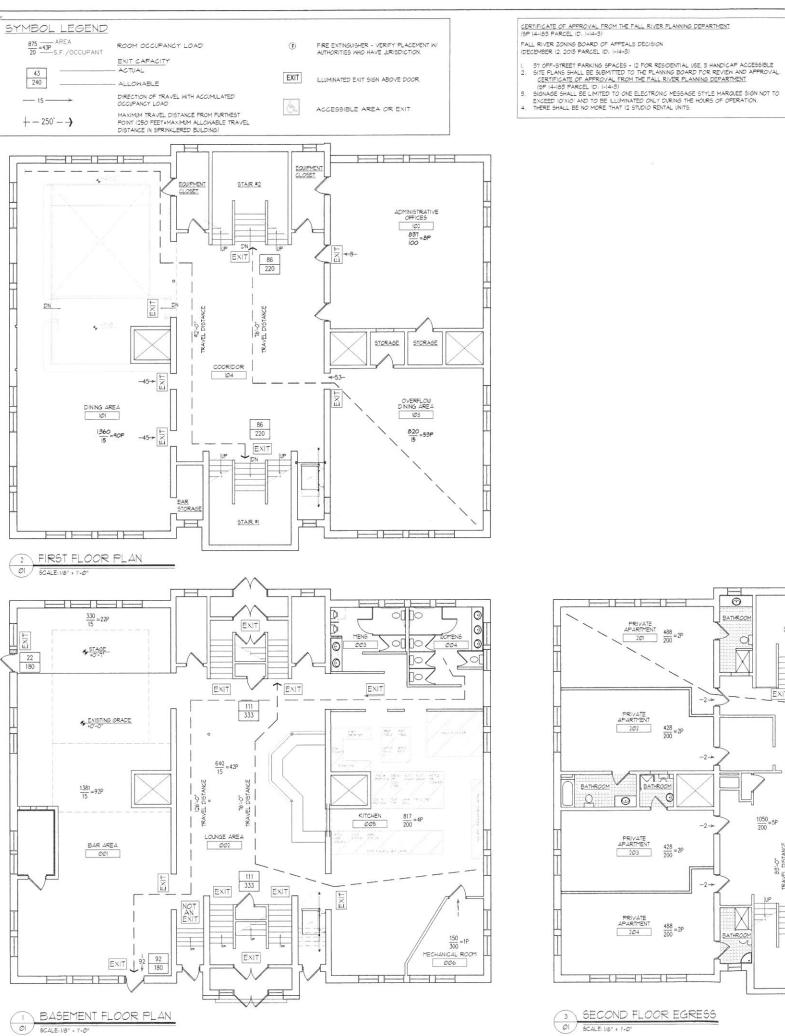

CHANGE OF OCCUPANCY SECTION 301.3	EXISTING STAIRWAYS IN AN EXISTING STRUCTURE SHALL NOT E REQUIRED TO COMPLY WITH THE REQUIREMENTS OF A NEW STAIRWAY AS OUTLINED IN SECTION LOOK OF THE INTERNATION BUILDING CODE WHERE THE EXISTING SPACE AND CONSTRUCT		
	WILL NOT ALLOW A REDUCTION IN PITCH OR SLOPE.		
CHAPTER 4, CLASSIFICATIO			
	FER SECTION 405, THE SCOPE OF WORK QUALIFIES AS AN <u>ALTERATION-LEVEL 3</u> AND SHALL COMPLY WITH CHAPTERS & T FOR LEVEL I AND 2 ALTERATIONS, AS WELL AS THE PROVIS OF CHAPTER &.		
	PER SECTION 401, <u>ALTERATIONS</u> SHALL COMPLY WITH THE PROVISIONS OF CHAPTER IO		
CHAPTER 8, ALTERATIONS	LEVEL 3		
BUILDING ELEMENTS AND MATERIALS SECTION 803	ALL NEW INTERIOR WALL, CEILING, FLOOR, AND TRIM MATERIAL AND METHODS SHALL COMPLY WITH CHAPTER & OF THE INTERNATIONAL BUILDING CODE.		
FIRE PROTECTION SECTION 804	AUTOMATIC SPRINLER SYSTEMS SHALL BE PROVIDED AS REGURED BY SECTION 1042, PER 10422 THE BUILDING REGURES AN AUTOMATIC SPRINLER SYSTEM APPROVED AUTOMATIC SPRINLER SYSTEM WILL BE INSTALLE		
MEANS OF EGRESS SECTION 805	REPAIRS SHALL MAINTAIN THE MIN. LEVEL OF PROTECTION REQUIRED.		
ACCESSIBILITY SECTION 806	PER 806.1, A BUILDING, FACILITY OR ELEMENT THAT IS ALTERE SHALL COMPLY WITH SECTION 605 AND 106.		
NEW STRUCTURAL ELEMENTS SECTION 801.2	NEW STRUCTURAL ELEMENTS ARE TO COMPLY WITH SECTION TO PER TOT 2, NEW ELEMENTS (INCLUDING CONNECTIONS AND ANCHORAGE) SHALL COMPLY WITH THE INTERNATIONAL BUILDIN CODE		
EXISTING STRUCTURAL ELEMENTS CARRYING GRAVITY LOADS SECTION 801.2	EXISTING STRUCTURAL ELEMENTS CARRYING GRAVITY LOADS SHALL COMPLY WITH SECTION TOTA, FER TOTA, ALTERATIONS SHALL NOT REDUCE THE CARACITY OF EXISTING LOAD CARRY ELEMENTS WLESS THE ELEMENTS HAVE THE CAPACITY TO CAST THE APPLICABLE DESIGN GRAVITY LOADS REQUIRED BY THE INTERNATIONAL BUILDING CODE		
STRUCTURAL ALTERATIONS SECTION 807.2	ALL STRUCTURAL ELEMENTS OF THE LATERAL FORCE RESISTIN SYSTEM IN BUILDINGS UNDERSOING LEVEL 3 STRUCTURAL ALTERATIONS OR LEVEL 2 ALTERATIONS AS TRIGGERED BY T SHALL COMPLY		
ENERGY CONSERVATION SECTION 808	LEVEL 3 ALTERATIONS ARE PERMITTED WITHOUT REQUIRING THE ENTIRE BUILDING OR STRUCTURE TO COMPLY WITH THE REQUIREMENTS OF THE INTERNATIONAL BURROY CONSERVATION OF THE ALTERATIONS SHALL CONFORM AS THEY RELATE TO THE NEW CONTRIVIOUS OF THE STRUCTURE OF THE STRUCTUR		
CHAPTER 6, ALTERATIONS -	LEVEL		
BUILDING ELEMENTS AND MATERIALS SECTION 602	ALL NEW INTERIOR WALL, CEILING, FLOOR, AND TRIM MATERIAL AND METHODS SHALL COMPLY WITH CHAPTER ϑ OF THE INTERNATIONAL BUILDING CODE.		
FIRE PROTECTION SECTION 603	ALTERATIONS SHALL MAINTAIN THE MIN. LEVEL OF PROTECTION REQUIRED.		
MEANS OF EGRESS SECTION 604	REPAIRS SHALL MAINTAIN THE MIN. LEVEL OF PROTECTION REQUIRED.		
ACCESSIBILITY SECTION 605.1	A BUILDING, FACILITY, OR ELEMENT THAT IS ALTERED SHALL COMPLY WITH THE PROVISIONS OF THIS SECTION AND 780 CMR MAAB		

	Lancia de la constanta de la c
PRIVATE APARTPENT 488 = 2P	FRIVATE 200 = 2P
PRIVATE APARTIENT 102 428 = 2P	## PRIVATE APARTENT 1206 428 = 2P
BATHROOM ■ 1050 = SP 1050 = SP APARTEENT 203	BATHROOM BATHROOM PATHROOM PAT
-2→ PRIVATE APARTONT 204 200 = 2P PRIVATE APARTON 204 200 = 2P	

AND STATE OF THE STING STATE OF THE STATE O	EDITION OF THE INTERNATI MASSACHUSETTS AMENDME PROJECT SUMMARY UJRISDICTION: CODE SECTION USE AND OCCUPANCY CLASSIFICATION SECTION SOS.	THE WORK GENERALLY INCLUDES IDOORS AND FLOOR FRAMING, A CONSTRUCTED HITH A NEW COMMENT OF HEAD CONTROLLED HITH A SEE A NEW FRIVATE A PARTHENTS ICTY OF FALL RIVER MASSACHUS CODE SUMMARY ALLOMABLE GUANTITY ASSEMBLY, A-2 RESTAURANT DING HEIGHTS AND AREAS I STORY, 40PT 6000 SF FOR TABLE 903.2 "OCCUPANCY AIR EQUIREMENTS" AN AUTOMATIC SP AND SHALL BE INSTALLED IN ACC. PROVIDE AS REQUIRED PER LOCA ACCORDINATE WITHE CITY OF FALL HICKOMEDITARY THE PER LARM SYSTEM REQUIREMENTS WITH CITY OF FALL HICKOMEDITARY THE GENERAL CONTRACTOR AND ELECTOROPHICATED IN SEPTICAL PLANCY CONTRACTOR AND ELECTOROPHICATED IN SEPTICAL PLANCY CONTRACTOR AND ELECTOROPHICATION OF FALL BIT KITCHENS, COMMENCIAL - 200 CCUP = 4. ADMINISTRATIVE STOR FOR COLUP = 1. FOR OCCUP STORY OF THE BUILDING, THEREFOR THE BUILDING, THEREF	DEMOLITION OF SELECT WALLS, NEW TWO STORY BAR WILL BE RECAL KITCHEN WITH DISPLAY LIT SECOND FLOOR ROOMS TO WITH NEW TOILET ROOMS. ETTS ACTUAL QUANTITY EXISTING CONSTRUCTION JOURNAL SPRINKLER RINKLER SYSTEM IS REQUIRED ORDANCE WITH NEPA IS. L. JURISDICTION AND IN JOURNAL SUBCONTRACTOR SHALL RIVER FIRE DEPARTMENT FOR MENTS PRIOR TO THE WORK. Y WOULFIXED SEATS 4, 4) 41 9 F / 15 9 F PR OCCUP = 8 SPLOCULP BIS FOLIOCOP STSFILOO AD = 276 OCCUPANTS	
T BE ICONAL ICTION S 6 AND VISIONS RIALS RIALS LAN LED RERED ITOT 2. ITOT 2. ITOT 3. ITOT 5. THE ITOT 5. ITON ITOT 5. ITON	PROJECT SUMMARY JURISDICTION: CODE SECTION SES AND OCCUPANCY CLASSIFICATION SECTION 305: CLASSIFICATION SECTION 305: CLASTER 5: GENERAL BUIL ALLOWABLE BUILDING FEIGHTS 1: AREA TABLE 503 CHAPTER 9: FIRE PROTECT AUTOMATIC SPRINKLER SYSTEMS SECTION 305.2.1 403.51. AND 403.2.1 FORTABLE FIRE EXTINOUSHERS SECTION 305.2.1 FIRE ALARM AND DETECTION SYSTEMS SECTION 407 CHAPTER 10: MEANS OF EC CESIGN OCCUPANT CAD. AREAS INCUIT SECTION 1004.3 PROSTING OF COCUPANT LOAD SECTION 1004.3 ENDITOR OF COCUPANT LOAD SECTION 1004.3 MINIMAM REQUIRED SECTION 1005.1.	THE WORK GENERALLY INCLUDES IDOORS AND FLOOR FRAMING, A CONSTRUCTED HITH A NEW COMMENT OF HEAD CONTROLLED HITH A SEE A NEW FRIVATE A PARTHENTS ICTY OF FALL RIVER MASSACHUS CODE SUMMARY ALLOMABLE GUANTITY ASSEMBLY, A-2 RESTAURANT DING HEIGHTS AND AREAS I STORY, 40PT 6000 SF FOR TABLE 903.2 "OCCUPANCY AIR EQUIREMENTS" AN AUTOMATIC SP AND SHALL BE INSTALLED IN ACC. PROVIDE AS REQUIRED PER LOCA ACCORDINATE WITHE CITY OF FALL HICKOMEDITARY THE PER LARM SYSTEM REQUIREMENTS WITH CITY OF FALL HICKOMEDITARY THE GENERAL CONTRACTOR AND ELECTOROPHICATED IN SEPTICAL PLANCY CONTRACTOR AND ELECTOROPHICATED IN SEPTICAL PLANCY CONTRACTOR AND ELECTOROPHICATION OF FALL BIT KITCHENS, COMMENCIAL - 200 CCUP = 4. ADMINISTRATIVE STOR FOR COLUP = 1. FOR OCCUP STORY OF THE BUILDING, THEREFOR THE BUILDING, THEREF	NEW TWO STORY BAR WILL BE RECALL KITCHEN WITH DISPLAY LIT SECOND FLOOR ROOMS TO WITH NEW TOILET ROOMS. ETTS ACTUAL QUANTITY EXISTING CONSTRUCTION JOMATIC SPRINKLER RINKLER SYSTEM IS REQUIRED ORDANCE WITH NIPPA IS. L. JURISDICTION AND IN LITKICAL SUBCONTRACTOR SHALL RIVER FIRE DEPARTMENT FOR WENTS FRICK TO THE WORK. Y. WIOUS FIXED SEATS 4, 4) 41 9 F / 15 SF PER OCCUP = 18 FOCCUP B 15 FOCCUP OF STOCKUP STO	
SEAND VISIONS RIALS 1. AN LEED 1. TOT 2. COMMITTED STANDS 1. TOT 3. COMMITTED STANDS 1. TOT 5. THE 1. THE	CODE SECTION USE AND OCCUPANCY CLASSIFICATION SOCION SOCION SOCION SOCION SECTION SOCION SOCIONI SI SOCIONI SI SOCIONI SI SOCIONI SI SOCIONI SILIANI SI	CODE SUMMARY ALLOWABLE QUANTITY ASSEMBLY, A-2 RESTAURANT DING HEIGHTS AND AREAS I STORY, 40PT 6,000 SF TION SYSTEMS FER TABLE 903.2 "OCCUPANCY AL REQUIREMENTS" AN AUTOMATIC SP AND SHALL BE INSTALLED IN ACC FROVIDE AS REQUIRED PER LOCA ACCORDINATE WITH FIPA GENERAL CONTRACTOR AND ELEC COORDINATE WITH CITY OF PALI ALL FIRE ALARM SYSTEM REQUIRE PRESS DINING/LOINGE AREAS - ASSEMBLI (INCONCENTRATED) - IS SF/OCCUP SIN KITCHENS, COMMERCIAL - 200 OCCUP = 4, ADMINISTRATIVE STOR FER OCCUP = 5 TOTAL OCCUPANT LO PROVIDE AS REQUIRED ENTERIOR PATIOS AND DECKS ME THROUGH THE BUILDING, THEREFOR IS TO BE CALCULATED USING ONLY STAIRWAYS = OCCUPANT LOAD	ACTUAL QUANTITY EXISTING CONSTRUCTION JOMATIC SPRINKLER RINKLER SYSTEM IS REQUIRED ORDANCE HITM HOPA IS. L JURISDICTION AND IN LITRICAL SUBCONTRACTOR SHALL RIVER FIRE DEPARTMENT FOR MENTS PRIOR TO THE WORK. Y WIGHT FIXED SEATS 4,4141 SF / 15 SF PER OCCUP = SYFOCCUP, BIT SF / 200 SF PER LASE - 100 SF/OCCUP, 6575F/100 AD = 276 OCCUPANTS	
RIALS I. AN LED I. TOT 2. I. TOT 2. I. TOT 3. I. TOT 5. I. THE II. TICN II. TICN II. TICN II. TICN III. TICN	USE AND OCCUPANCY CLASSFICATION SECTION 3051 CHAPTER 5: GENERAL BUIL ALLOWARLE BUILDING HEIGHTS 1: AREA TABLE 503 CHAPTER 9: FIRE PROTECT AUTOMATIC SPRINLER SYSTEMS SECTION 3051 ADD 402311 PORTABLE FIRE EXTINGUISHERS SECTION 3051 FIRE ALAM AND DETECTION 951 FIRE ALAM AND DETECTION 951 CHAPTER 10: MEANS OF EC DETECTION 9051 FIRE ALAM AND DETECTION 9051 FIRE ALAM AND DETECTION 10043 SECTION 10051, SECTION 10051,	ALLOWABLE QUANTITY ASSEMBLY, A-2 RESTAURANT DING HEIGHTS AND AREAS I STORY, 40PT 6,000 5F FICH YSTEMS FER TABLE 903.2 "OCCUPANCY AL REQUIREMENTS" AN AUTOMATIC 5P AND SHALL BE INSTALLED IN ACC PROVIDE AS REQUIRED PER LOCA ACCORDANCE WITH NFDA GENERAL CONTRACTOR AND ELEC COORDINATE WITH ECITY OF FALL ALL FIRE ALLARM SYSTEM REQUIRE DINING/LOUNGE AREAS - ASSEMBL (INCONCENTRATED) - IS SF/OCCUP 3/IN KITCHENS, COMMERCIAL - 200 CCUP = 1, ADMINISTRATIVE STOR PER OCCUP = 26 TOTAL OCCUPANT LO PROVIDE AS REQUIRED EXTERIOR PATIOS AND DECKS ME THROUGH THE BUILDING, THEREFOR 5 TO BE CALCULATED USING ONLY STAIRMAYS = OCCUPANT LOAD	EXISTING CONSTRUCTION JTOMATIC SPRINKLER RINKLER SYSTEM IS REQUIRED ORDANCE WITH NPPA IS. LURISDICTION AND IN JTRICAL SUCCONTRACTOR SHALL RIVER FIRE DEPARTMENT FOR MENTS PRIOR TO THE WORK. JY WOUL FIXED SEATS , 4 July 19F / 19 SP PER OCCUP 2: SPROCCUP BY 19F / 200 SP PER LASE - 100 SP/OCCUP 6575F/100 AD = 276 OCCUPANTS	
ILAN LED ITOT 2. ITOT 2. ITOT 3. ITOT 3. ITOT 5. IT	USE AND OCCUPANCY CLASSFICATION SECTION 3051 CHAPTER 5: GENERAL BUIL ALLOWARLE BUILDING HEIGHTS 1: AREA TABLE 503 CHAPTER 9: FIRE PROTECT AUTOMATIC SPRINLER SYSTEMS SECTION 3051 ADD 402311 PORTABLE FIRE EXTINGUISHERS SECTION 3051 FIRE ALAM AND DETECTION 951 FIRE ALAM AND DETECTION 951 CHAPTER 10: MEANS OF EC DETECTION 9051 FIRE ALAM AND DETECTION 9051 FIRE ALAM AND DETECTION 10043 SECTION 10051, SECTION 10051,	DING HEIGHTS AND AREAS I STORY, 40PT 6,000 SF TION SYSTEMS PER TABLE 409.2 "OCCUPANCY AL REQUIREMENTS" AN AUTOMATIC SP AND SHALL BE INSTALLED IN ACC PROVIDE AS REQUIRED FER LOCA ACCORDANCE WITH NFPA GENERAL CONTRACTOR AND ELEC COORDINATE AV THE CITY OF FALL ALL FIRE ALARM SYSTEM REQUIRE DINING/LOUNGE AREAS - ASSEMBL LINCONCENTRATED) - IS SF/COCUP SIN KITCHENS, COMMERCIAL - 200 OCCUP = 1, ADMINISTRATIVE STOR FOR OCCUP = 20 TOTAL OCCUPANT LO PROVIDE AS REQUIRED ENTERIOR PATIOS AND DECKS ME THROUGH THE BUILDING, THEREFOR IS TO BE CALCULATED USING ONLY STAIRMAYS = OCCUPANT LOAD	JITOMATIC SPRINKLER RINKLER SYSTEM IS REQUIRED ORDANCE HITH NFPA IS. L. JURISDICTION AND IN JURISDICTION AND IN STATEMENT FOR JURISDICTION AND IN STATEMENT FOR JURISDICTION AND IS PERS OCCUP SEPOCOLY SEPOCOLY AND IS PERS JURISDICTION IN STATEMENT AND IN STAT	
AN LER LAN LER LAN LER LAN LER LAN LER LAN LER LAN LAN LER LAN	ALLOWABLE BUILDING FEIGHTS & AREA TABLE 503 CHAPTER 9, PIRE PROTECT ANTOMATIC SPRINGLER 5YSTEMS FEIGHTON 903 21, 100351, AND 903211 FORTABLE FIRE EXTRIGUISHERS SECTION 905 21, FIRE ALARM AND DETECTION 5YSTEMS SECTION 907 CHAPTER 10, MEANS OF EG DESIGN OCCUPANT LOAD, AREAS A (VOIT FINED SEATING SECTION 1004.1 POSTING OF COCUPANT LOAD DESIGN OCCUPANT DOTTOR AREAS SECTION 1004.8 MINIMAM REQUIRED SERTESS HIDTH SECTION 1005.1	I STORY, 40FT 6000 SF FOR TABLE 908.2 "OCCUPANCY AI FER TABLE 908.2 "OCCUPANCY AI FER TABLE 908.2 "OCCUPANCY AI FERDIREMENTS" AN AUTOMATIC SP AND SHALL BE INSTALLED IN ACC PROVICE AS REQUIRED PER LOCA ACCORDINATE WITH NFPA GENERAL CONTRACTOR AND ELEC COORDINATE WITHE CITY OF FALI ALL FIRE ALARM SYSTEM REQUIRE DINING/LOUNGE AREAS - ASSEMBL LINCONCENTRATED) - IS SPICOCLY SIT NITCHENS, COMMERCIAL - 200 CCLYP = 1, ADMINISTRATIVE STOR PER OCCUP = 2 TOTAL OCCUPANT LO PROVIDE AS REQUIRED ENTERIOR PATIOS AND DECKS ME THROUGH THE BUILDING, THEREFOR STO BE CALCULATED USING ONLY STAIRMAYS = OCCUPANT LOAD	JITOMATIC SPRINKLER RINKLER SYSTEM IS REQUIRED ORDANCE MITH NFPA IS. L. JURISDICTION AND IN JURISDICTION AND IN STATE JURISDICTION STATE JURISDICTION AND IS JURISDICTION AD = 276 OCCUPANTS	
LAN LED LAN LE	HEIGHTS & AREA TABLE 503 CHAPTER 9. FIRE PROTECT AUTOMATIC SPRINKLER SYSTEMS SECTION 903.2.1 903.3.1 AND 903.1.1 PORTABLE FIRE ANTHOUSHERS SECTION 906.1 FIRE ALARM AND DETECTION SYSTEMS SECTION 907.1 CHAPTER 10. MEANS OF EC PESIGN OCCUPANT CAD. AREAS NOUT FINED SEATING. POSTING OF COCCUPANT 10AD DECTION 1004.3 ECTION 1004.3 MINIMAL REQUIRED SERTES HIDTH SECTION 1004.8 MINIMAL REQUIRED SECTION 1004.8 MINIMAL REQUIRED SECTION 1005.1.	FION SYSTEMS FER TABLE 903.2 "OCCUPANCY AL FER TABLE 903.2 "OCCUPANCY AL FER TABLE 903.2 "OCCUPANCY AL FEOVICE AS REQUIRED FER LOCA ACCORDINACE MITH NIFPA SENERAL CONTRACTOR AND ELEC COORDINATE WI THE CITY OF FALI ALL FIRE ALARM SYSTEM REQUIRE DINING/LCINGE AREAS - ASSEMBL INCONCENTRATED) - IS SY/OCCUP SIT KITCHENS, COMMERCIAL - 200 OCCUP = 4. ADMINISTRATIVE STOR FER OCCUP = 5 TOTAL OCCUPANT LO PROVIDE AS REQUIRED ENTERIOR PATIOS AND DECKS ME THROUGH THE BUILDING, THEREFOR IS TO BE CALCULATED USING ONLY STAIRWAYS = OCCUPANT LOAD	JITOMATIC SPRINKLER RINKLER SYSTEM IS REQUIRED ORDANCE HITH NFPA IS. L. JURISDICTION AND IN JURISDICTION AND IN STATEMENT FOR JURISDICTION AND IN STATEMENT FOR JURISDICTION AND IS PERS OCCUP SEPOCOLY SEPOCOLY AND IS PERS JURISDICTION IN STATEMENT AND IN STAT	
LAN LED TOT 2. TOT 2. TOT 3. TOT 3. TOT 3. THE TING THE TING THE TING THE TOT 5. THE TOT	AUTOMATIC SPRINKLER SYSTEMS SECTION 905.2.1 905.2.1 AND 905.2.1 905.2.1 AND 905.2.1 PORTABLE FIRE EXTINOUSHERS SECTION 906.1 SECTION 906.1 SECTION 906.1 SECTION 906.1 CHAPTER 10. MEANS OF EC SECTION 906.1 SECTION 906.1 PINED SEATING SECTION 1004.1 POSTING OF SECTION 1004.3 SECTION 1005.1	PER TABLE 908.2 "OCCUPANCY AI REQUIREMENTS" AN AUTOMATIC 95 AND SHALL BE INSTALLED IN ACC PROVIDE AS REQUIRED PER LOCA ACCORDANCE WITH HIPPA GENERAL CONTRACTOR AND ELEC COORDINATE W THE CITY OF PALL ALL FIRE ALARM SYSTEM REQUIRE DINING/LOUNGE AREAS - ASSEMBL (INCONCENTRATED) - IS SF/OCCUP 3'IN KITCHENS, COMMERCIAL - 200 OCCUP = 4, ADMINISTRATIVE STOR PER OCCUP = 20 TOTAL OCCUPANT LO PROVIDE AS REQUIRED ENTERIOR PATIOS AND DECKS ME THROUGH THE BUILDING, THEREFOR 5 TO BE CALCULATED USING ONLY STAIRMAYS = OCCUPANT LOAD	RINLER SYSTEM IS REQUIRED ORDANCE WITH NIPPA IS. LURISDICTION AND IN TRICAL SUCCONTRACTOR SHALL. RIVER FIRE DEPARTMENT FOR MEMORY FOR TO THE WORK. Y WOULFIXED SEATS .4 July 19 F / 19 GP F PER ACCUP : 5 F/OCCUP : 5 F OCCUP : 5 F OCC	
AN LED TOT.2. (C) STARTY START	SPRINKLER SYSTEMS SECTION 903 2.1 903 2.1 AND 903 2.1 903 2.1 AND 903 2.1 903 2.1 AND 903 2.1 PORTABLE FIRE ENTINGUISHERS SECTION 906.1 PIRE ALARM AND DETECTION SYSTEMS SECTION 907.1 CHAPTER 10. MEANS OF EC DESIGN OCCUPANT	REQUIREMENTS' AN AUTOMATIC 59 AND SHALL BE INSTALLED IN ACC PROVIDE AS REQUIRED PER LOCA ACCORDANCE WITH NEPA GENERAL CONTRACTOR AND ELEC COORDINATE WITHE CITY OF FALL ALL FIRE ALARM SYSTEM REQUIRE DINING/LOUNGE AREAS - ASSEMBL (INCONCENTRATED) - IS SF/OCCUP SIT KITCHENS, COMMERCIAL - 200 CCUP = 1, ADMINISTRATIVE STOR PER OCCUP = 26 TOTAL OCCUPANT LO PROVIDE AS REQUIRED EXTERIOR PATIOS AND DECKS ME THROUGH THE BUILDING, THEREFOR IS TO BE CALCULATED USING ONLY STAIRMAYS = OCCUPANT LOAD	RINLER SYSTEM IS REQUIRED ORDANCE WITH NIPPA IS. LURISDICTION AND IN TRICAL SUCCONTRACTOR SHALL. RIVER FIRE DEPARTMENT FOR MEMORY FOR TO THE WORK. Y WOULFIXED SEATS .4 July 19 F / 19 GP F PER ACCUP : 5 F/OCCUP : 5 F OCCUP : 5 F OCC	
RED TOT.2. TOT.2. TOT.2. TOT.5. THE TOTO	ENTINGUISHERS BECTION 906 II FIRE ALARM AND DETECTION 907 CHAPTER IO, MEANS OF EC CHAPTER IO, MEANS CHAPTER IO,	ACCORDANCE WITH NFPA SENERAL CONTRACTOR AND ELEC COORDINATE W/ THE CITY OF FALL ALL FIRE ALARM SYSTEM REQUIRE SRESS DINING/LOINGE AREAS - ASSEMBL ILINCONCENTRATED) - IS SF/OCCUP SIT KITCHENS, COMMERCIAL - 200 CCUP = 1, ADMINISTRATIVE STOR FER OCCUP = 8 TOTAL OCCUPANT LO PROVIDE AS REQUIRED EXTERIOR PATIOS AND DECKS ME THROUGH THE BUILDING, THEREFOR IS TO BE CALCULATED USING CALL STAIRMAYS = OCCUPANT LOAD	CTRICAL SUBCONTRACTOR SHALL RIVER FIRE DEPARTMENT FOR MENTS PRIOR TO THE WORK. Y W/OUT FIXED SEATS 4,4141 SF / 15 SF PER OCCUP = \$500CUP, 817 SF / 100 SF PER LASE - 100 SF/OCCUP 857SF/100 AD = 276 OCCUPANTS	
RED TOT.2. (C) TOT.2. (C) TOT.2. (C) TOT.3. (C) TOT.5. (C) TIME TOT.5. (C) THE TOT.5. (C) THE TOT.5. (C) TOT.5. (C) THE TOT.5. (C) THE TOT.5. (C) TOT.5. (C) THE TOT.5. (C) THE TOT.5. (C) T	DETECTION SYSTEMS SECTION 901 CHAPTER 10: MEANS OF EC DESIGN OCCUPANT LOAD, AREAS LIGHT LOAD, AREAS LIGHT POSTING OF DOCUPANT LOAD SECTION 1004.3 DUTDOOR AREAS SECTION 1004.8 MINIMAM REQUIRED SECTION 1005.1.	COORDINATE W THE CITY OF FALL ALL FIRE ALARM SYSTEM REQUIRE DINING/LOUNGE AREAS - ASSEMBL (INCONCENTRATED) - IS SF/OCCUP SIT KITCHENS, COMMERCIAL - 200 OCCUP = 1, ADMINISTRATIVE STOR PER OCCUP = 26 TOTAL OCCUPANT LO PROVIDE AS REQUIRED EXTERIOR PATIOS AND DECKS ME THROUGH THE BUILDING, THEREFOR IS TO BE CALCULATED USING CALLY STAIRMAYS = OCCUPANT LOAD	RIVER FIRE DEPARTMENT FOR MEMORY PRIOR TO THE WORK. Y WOULD FIXED SEATS , 4 July 197 / 15 SF PER OCCUP = 5510CCUP, 8 10 FO CCUP, 9 5510CCUP, 8 10 FO CCUP, 9 5510CCUP, 9 551	
DING DING NS NS NS RYING ARRY ARRY TOTIS THE CO TON MR 521:	DESIGN OCCUPANT (DAD. AREAS M/QUT PINED SEATING SECTION (DO4.).I POSTING OF DOCCUPANT LOAD SECTION (DO4.) QUIDOOR AREAS SECTION (DO4.) MINIMAM REQUIRED SECTION (DO5.)	DINING/LOUNGE AREAS - ASSEMBL LINCONCENTRATED) - IS SFICOCUP STIR KITCHENS COMMERCIAL - 200 CCCUP = 4. ADMINISTRATIVE STOR PER OCCUP = 5 TOTAL OCCUPANT LO PROVIDE AS REQUIRED ENTERIOR PATIOS AND DECKS ME THROUGH THE BUILDING, THEREFOR IS TO BE CALCULATED USING CMLY STAIRMAYS = OCCUPANT LOAD	. 4,41 5F / IS SF PER OCCIP = 95/OCCUP. 3H 5F / 200 5F PER RAGE - 100 SF/OCCUP. 3575F/100 AD = 276 OCCUPANTS	
DING PS SS SS SS SS TOTS THE SS SS SS SS SS SS SS SS SS	DESIGN OCCUPANT (DAD. AREAS M/QUT PINED SEATING SECTION (DO4.).I POSTING OF DOCCUPANT LOAD SECTION (DO4.) QUIDOOR AREAS SECTION (DO4.) MINIMAM REQUIRED SECTION (DO5.)	DINING/LOUNGE AREAS - ASSEMBL LINCONCENTRATED) - IS SFICOCUP STIR KITCHENS COMMERCIAL - 200 CCCUP = 4. ADMINISTRATIVE STOR PER OCCUP = 5 TOTAL OCCUPANT LO PROVIDE AS REQUIRED ENTERIOR PATIOS AND DECKS ME THROUGH THE BUILDING, THEREFOR IS TO BE CALCULATED USING CMLY STAIRMAYS = OCCUPANT LOAD	.4)41 5 F / 15 SF PER OCCUP : 15F/OCCUP, 317 5F / 200 5F PER AAGE - 100 5F/OCCUP, 3375F/100 AD = 276 OCCUPANTS	
ARRY E TING (1015 THE IIION IIIION IIIION IIIIIIII	DECLEAST LOAD SECTION 1004.3 DUTDOOR AREAS SECTION 1004.8 MINIMA REQUIRED LORESS MIDTH SECTION 1005.1,	PROVIDE AS REQUIRED ENTERIOR PATIOS AND DECKS ME THROUGH THE BUILDING, THEREFOR IS TO BE CALCULATED USING ONLY STAIRMAYS = OCCUPANT LOAD		
THE TION ETO TON TON THE TON T	OUTDOOR AREAS SECTION 1004.8 MINIMUM REQUIRED SERESS WIDTH SECTION 1005.1,	THROUGH THE BUILDING, THEREFOR IS TO BE CALCULATED USING ONLY STAIRWAYS = OCCUPANT LOAD	ANS OF EGRESS DO NOT PASS	
THE STORM ST	EGRESS WIDTH SECTION 1005.1,	STAIRWAYS = OCCUPANT LOAD	EXTERIOR PATIOS AND DECKS MEANS OF EGRESS DO NOT PASS THROUGH THE BUILDING, THEREFORE THE BUILDING OCCUPANT LOAD IS TO BE CALCULATED USING ONLY THE AREA OF THE BUILDING.	
ION		3 INCHES PER OCCUP. OTHER EGRESS COMPONENTS = OCCUPANT LOAD × 0.2 INCHES/OCCUP.		
E E E E E E E E E E E E E E E E E E E	ACCESSIBLE MEANS OF EGRESS REQUIRED FABLE 1007.1	ACCESSIBLE MEANS OF EGRESS SI ACCESSIBLE SPACES SHALL BE PI ONE ACCESSIBLE MEANS OF EGRE MEANS OF EGRESS ARE REQUIRED. FROM ANY ACCESSIBLE SPACE, EX- THE SPACE SHALL BE SERVED BY ACCESSIBLE MEANS OF EGRESS. EXCEPTION 1. ACCESSIBLE MEANS IN ALTERATIONS TO EXISTING BUILT	ROVIDED WITH NOT LESS THAN SIXE SEVENCE MORE THAN ONE SEVENCE TO THE SECTION 1015 FOR 1021 FACH ACCESSIBLE FORTION OF NOT LESS THAN THO OF EGRESS ARE NOT REQUIRED	
9	EXIT OR EXIT ACCESS DOORWAY ARRANGEMENT DECTION 1015 2.2	2 OF THE 3 REQUIRED EXITS SHALL BE ARRANGED PER SECTION 1015.2.1, EXCEPTION 2. IN A BUILDING EQUIPMEN WITH AN AUTOMATIC SPRINKLER SYSTEM, THE SEPARATION DISTANCE SHALL NOT BE LESS THAN 1/3 OF THE MINIMUM DIAGONAL DIMENSION OF THE SPACE SERVED.		
9	EXIT ACCESS TRAVEL DISTANCE SECTION 1016.1	250 FT w/ SPRINKLER SYSTEM	DOES NOT EXCEED 250 FT	
	CORRIDOR FIRE-RESISTANCE RATING FABLE (018.)	SPRINKLERED A (ASSEMBLY) USE (SROUP = 0 HRS	
9	NUMBER OF EXITS AND CONTINUITY PABLE 1021.1	OCCUPANT LOAD OF 1-500 MINIMUM	TOTAL OF 4 EXITS PROVIDED	
	ASSEMBLY MAIN EXIT DECTION 1028:2	A MAIN EXIT SHALL BE PROVIDED AND SHALL SIZED TO ACCOMMODATE I/2 OCCUPANT LOAD OR MIN. REQUIRED EGRESS WIDTH, WHICHEVER IS GREATER. (COMPLIES)		
1.5	ASSEMBLY OTHER EXITS SECTION 1028.3	ADDITIONAL MEANS OF EGRESS SHALL BE PROVIDED AND SHALL ACCOMMODATE AT LEAST 1/2 OCCUPANT LOAD.		
N	ASSEMBLY AISLES - MINIMAN AISLE WIDTH PECTION 1028.2	ITEM 1. 48° FOR AISLES HAVING SEATING ON BOTH SIDES, PER EXCEPTION 1, 56° FOR AISLES SERVING LESS THAN 50 FERSONS. ITEM 2. 36° FOR AISLES HAVING SEATING ON ONE SIDE. ITEM 4. 42° FOR LEVEL OR RAMPED AISLES HAVING SEATING ON BOTH SIDES, FER EXCEPTION 1, 36° FOR AISLES SERVING LESS THAN 50 PERSONS, FER EXCEPTION 2, 30° FOR AISLES SERVING LESS THAN 14 PERSONS. ITEM 5. 36° FOR AISLES HAVING SEATING ON ONE SIDE, PER EXCEPTION 1, 30° FOR AISLES SERVING LESS THAN 14 PERSONS.		
9	CHAPTER II: ACCESSIBILITY SERVICES	IF A SERVICE OR FACILITY IS PRO		
_	SECTION 1008.2.1	ACCESSIBLE, THE SAME SERVICE OF PROVIDED ON AN ACCESSIBLE LEV	OR FACILITY SHALL BE	
	DINING AREAS SECTION 1008-2.4	TO A MEZZANINE SEATING ARE THAT THE MEZZANINE CONTAIN	CCESSIBLE. OT REQUIRED TO PROVIDE AN LEVELS, AN ACCESSIBLE ROUTE EA IS NOT REQUIRED, PROVIDED	

CHAPTER 24: PLUMBING (284CMR)

CHAPTER 34: EXISTING BUILDING AND STRUCTURES

TOILET/URINALS (MALE)- I PER 50 ACTUAL # URINALS = 2 OCCUP, MAINTAIN I:I RATIO MIX ACTUAL # TOILETS = 2

REFER TO 2009 INTERNATIONAL EXISTING BUILDING CODE SUMMARY

ACTUAL = TOILETS = 5

ACTUAL = LAVATORIES = 2

TOILETS (FEMALE)- | PER 30 OCCUPANTS

LAVATORIES (MALE)- I PER 15 OCCUPANTS.

LAVATORIES (FEMALE)- | PER 15 OCCUPANTS. DRINKING FOUNTAIN- NOT REO. SERVICE SINKS- NOT REQ.




INTERIOR RENOVATIONS CONNELL SCHOOL SHERWOOD BUILDING COMPANY 650 PLYMOUTH AVENUE FALL RIVER, MA 02721


REVISIONS:

SCALE: AS NOTED DATE: 08.15.14 DRAWN BY NJV JOB NUMBER: 140-13 DRAWING NAME:

CODE SUMMARY

DRAWING NUMBER:

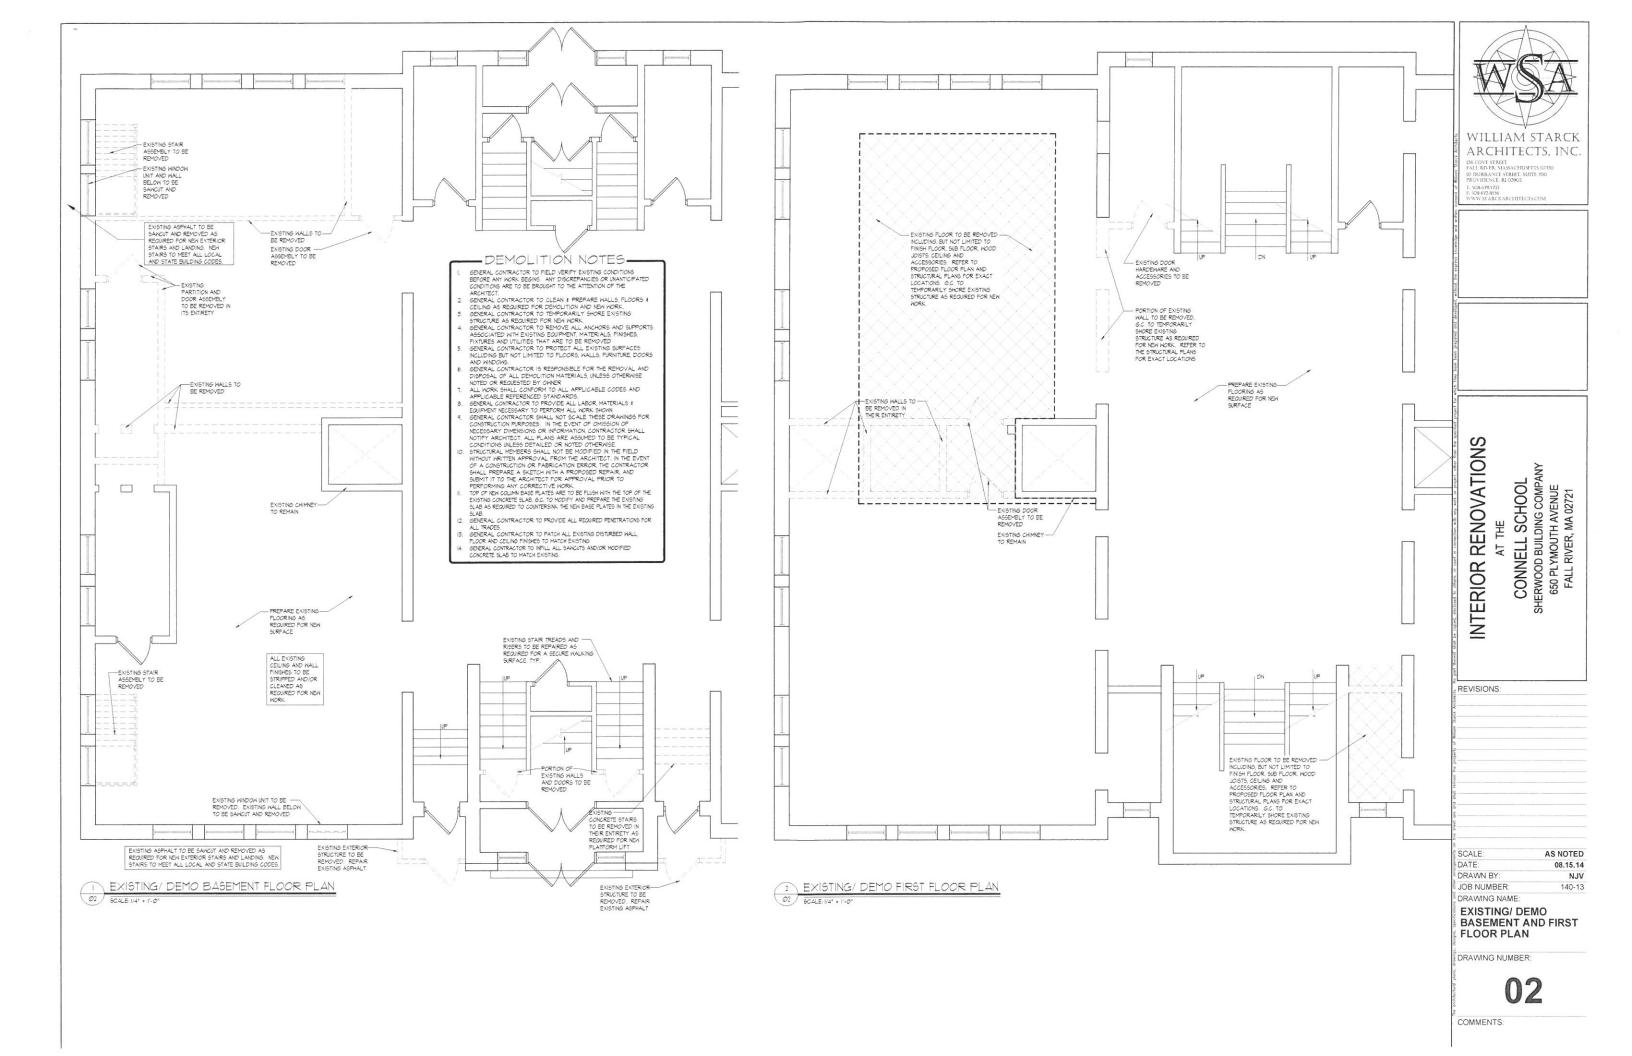

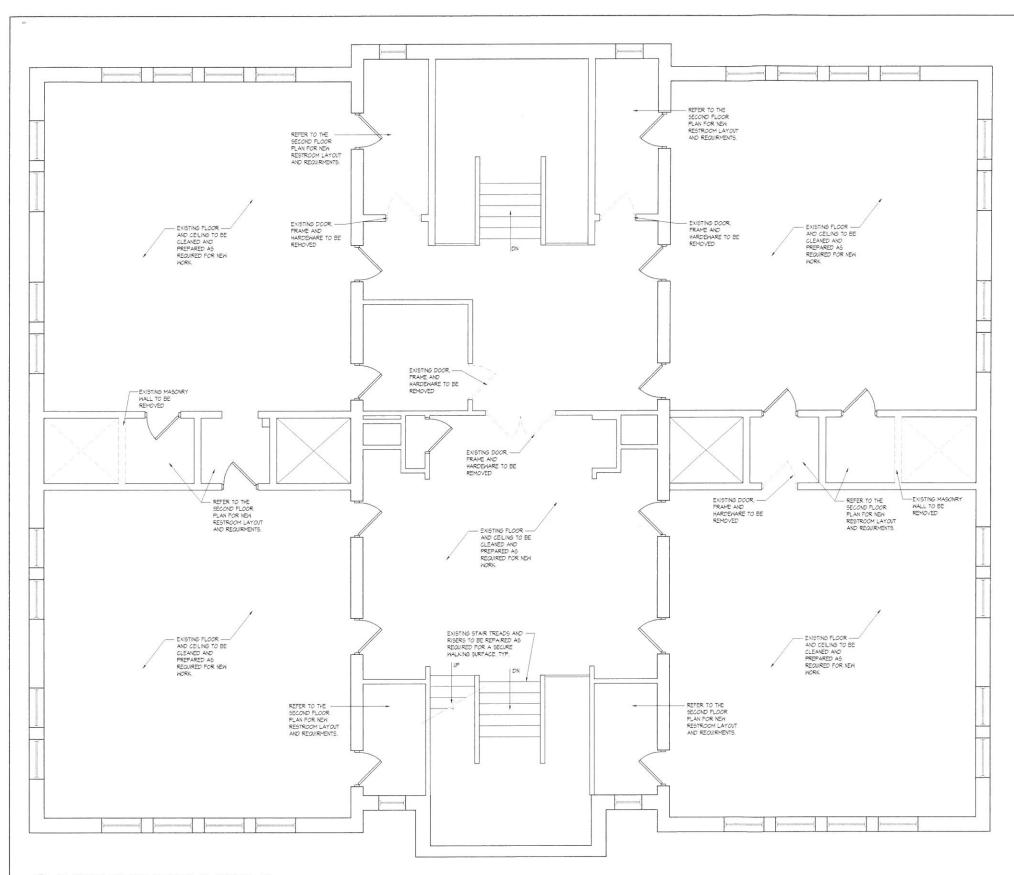

EXISTING/ DEMO SECOND FLOOR PLAN 63 GALE: 1/4" : 1'-0"

WILLIAM STARCK ARCHITECTS, INC.

INTERIOR RENOVATIONS AT THE CONNELL SCHOOL SHERWOOD BUILDING COMPANY 650 PLYMOUTH AVENUE FALL RIVER, MA 02721

REVISIONS:

SCALE: DATE:


08.15.14 DRAWN BY: NJV JOB NUMBER: 140-13 DRAWING NAME:

AS NOTED

EXISTING/ DEMO SECOND FLOOR PLAN

DRAWING NUMBER:

03

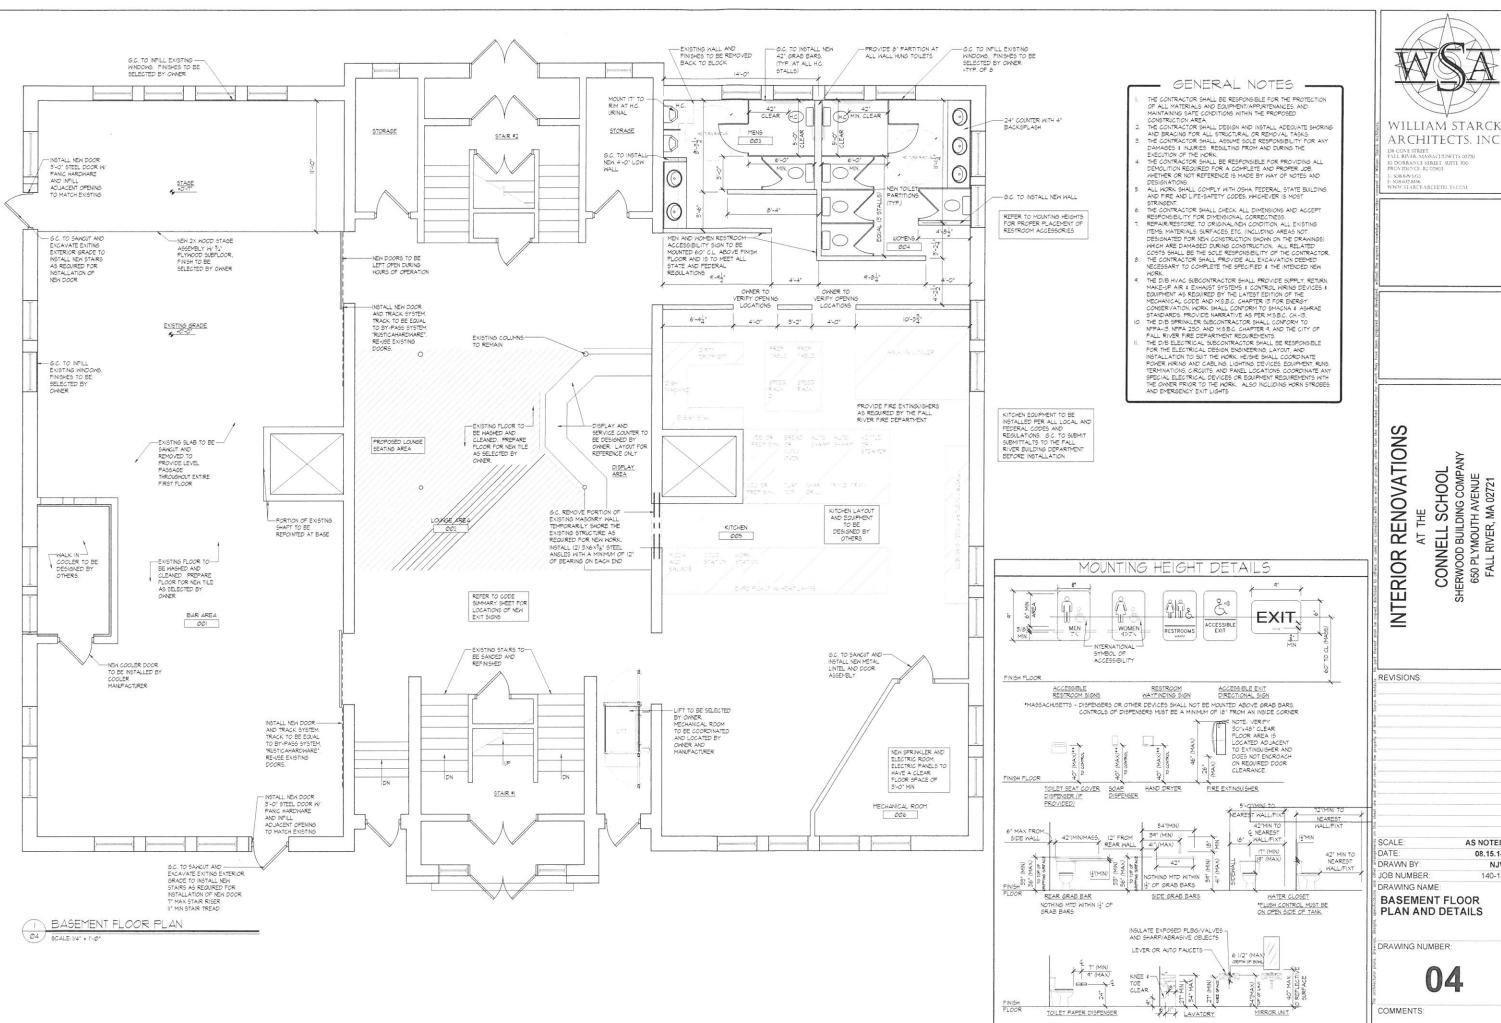

WILLIAM STARCK

ARCHITECTS, INC.


AS NOTED

08.15.14 NJV 140-13

BASEMENT FLOOR PLAN AND DETAILS

DRAWING NUMBER:

04

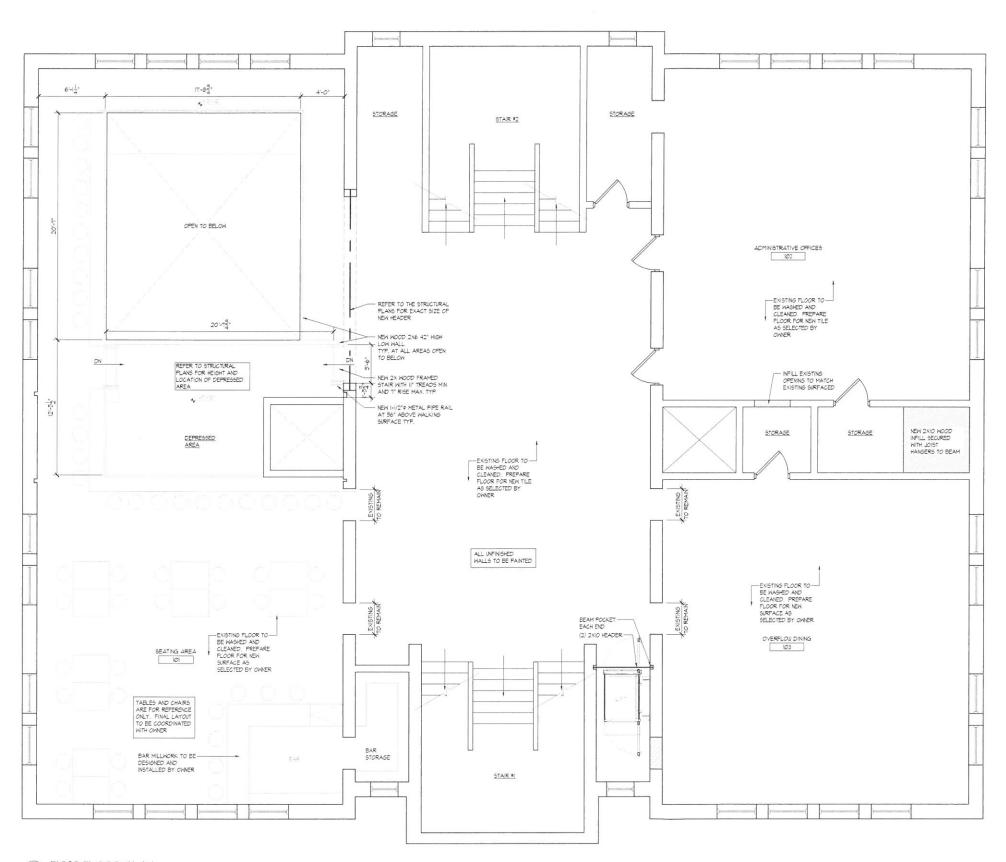

FIRST FLOOR PLAN

SCALE: 1/4" + 1"-0"



INTERIOR RENOVATIONS

CONNELL SCHOOL SHERWOOD BUILDING COMPANY 650 PLYMOUTH AVENUE FALL RIVER, MA 02721

REVISIONS:


SCALE: DATE: AS NOTED 08.15.14 DRAWN BY: NJV JOB NUMBER: 140-13

DRAWING NAME:

FIRST FLOOR PLAN

DRAWING NUMBER:

05

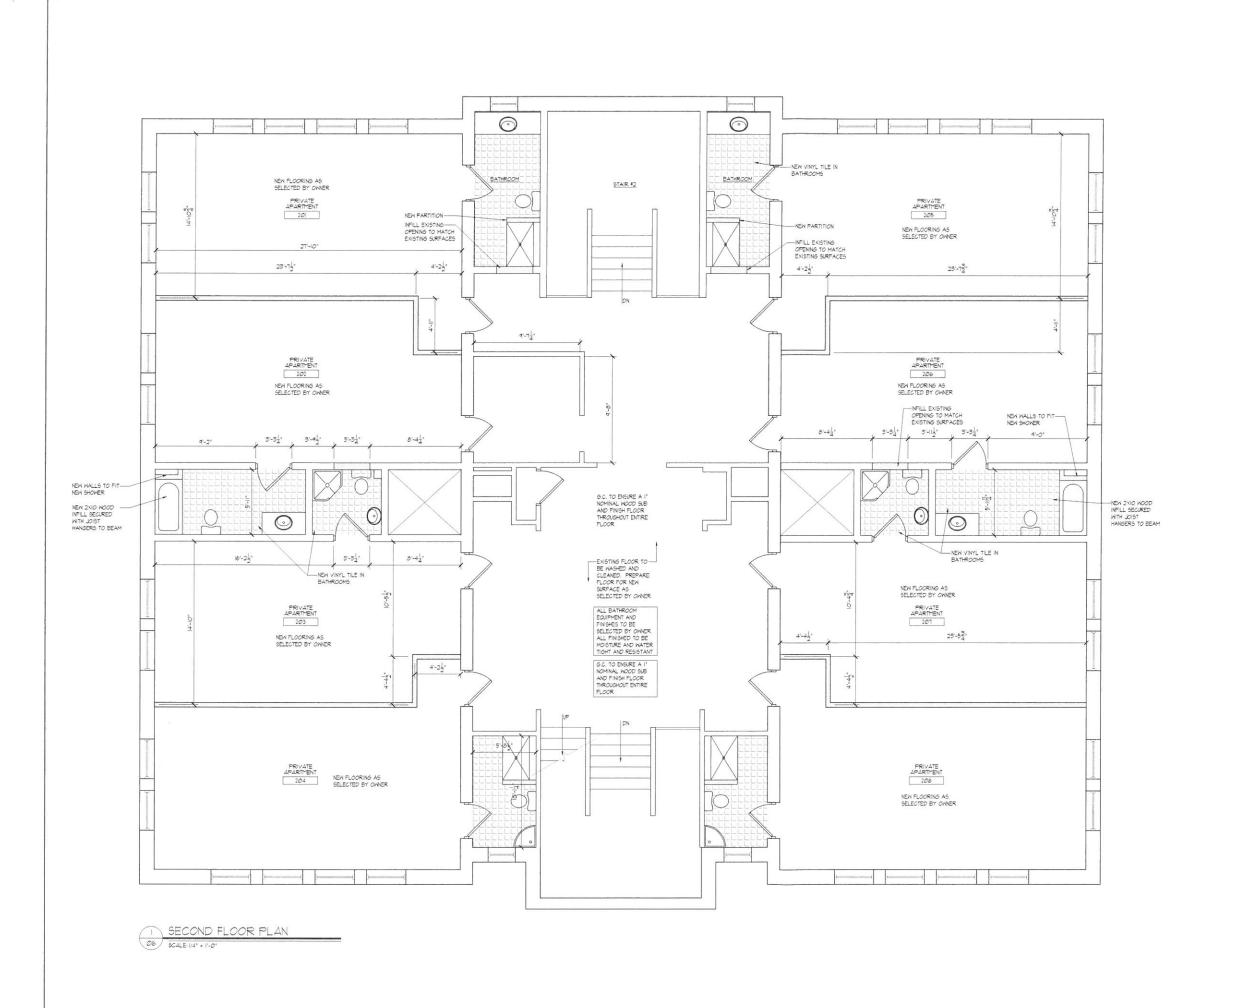

INTERIOR RENOVATIONS CONNELL SCHOOL SHERWOOD BUILDING COMPANY 650 PLYMOUTH AVENUE FALL RIVER, MA 02721 REVISIONS: METAL SLIP TRACK EXTEND FRAMING TO
ROOF DECK WHERE
NECESSARY. SCALE: DATE: 2 LAYERS - 5/8" GMB.
UP TO DECK, BOTH
SIDES - PAINTED.
COLOR TO BE
SELECTED BY OWNER. AS NOTED 08.15.14 DRAWN BY: JOB NUMBER: 140-13 — 3-5/8" -20GA, LIGHT METAL STUD FRAMING © I6" O.C. DRAWING NAME: SECOND FLOOR PLAN AND WALL TYPE 3-5/8" METAL TRACK ATTACHED TO EXISTING FLOOR FIRE RESISTANT SEALANT - BOTH SIDES EXISTING FLOORING TO REMAIN

DRAWING NUMBER:

COMMENTS:

06

NJV

- EXISTING DECK FIRE RESISTANT SEALANT

6.C. TO FIELD VERIFY FLOOR TO BOTTOM OF


UL DESIGN: U419

TYPICAL

WALL TYPE

O6 5CALE: 3/4" * 1'-0"

WILLIAM STARCK ARCHITECTS, INC.

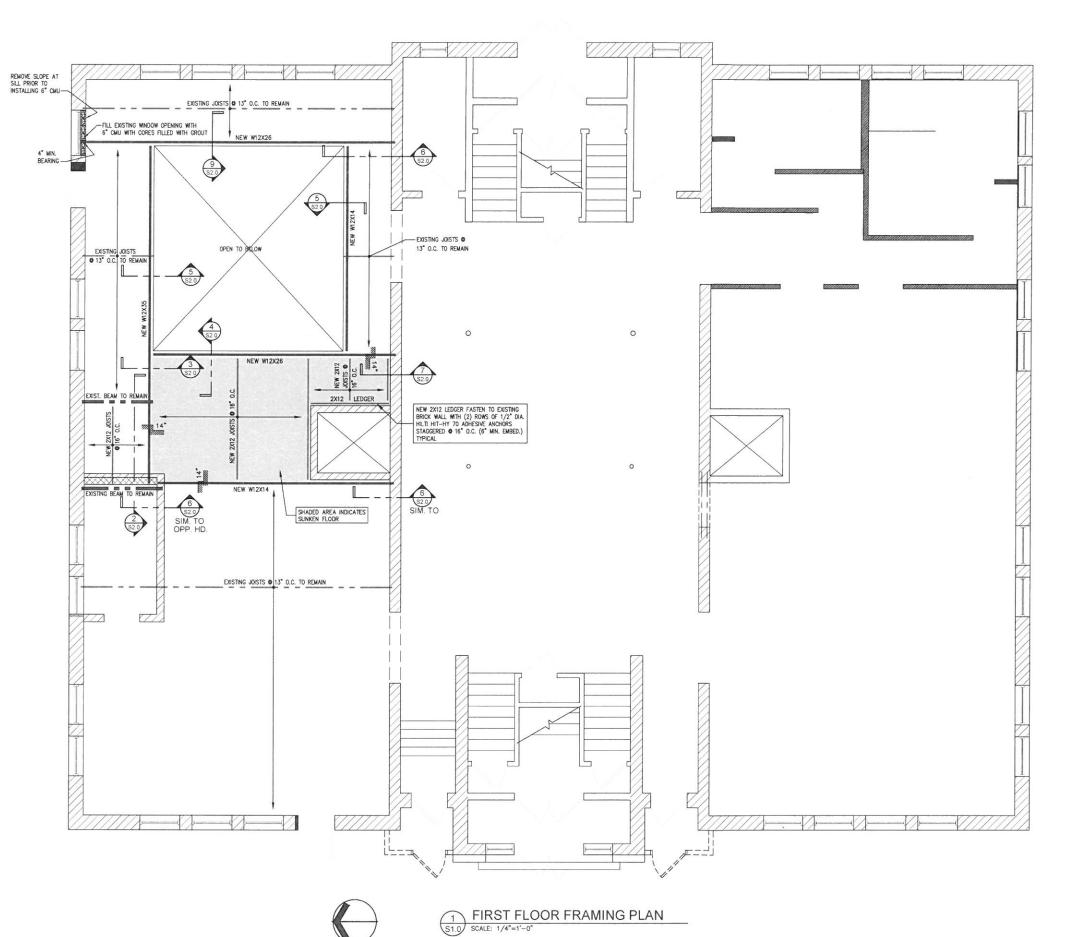

CODE INFORMATION AND DESIGN LOADS (EXCEPT AS NOTED):

SUPPORT BEAMS DESIGNED USING THE 8TH EDITION OF THE MASSACHUSETTS STATE BUILDING CODE 780-CMR (2009 INTERNATIONAL BUILDING CODE W/ MA AMENDMENTS), FALL RIVER, MA:

STRUCTURAL STEEL AND STEEL JOISTS NOTES

- ALL DETAILING, FABRICATION AND ERECTION SHALL CONFORM TO THE AISC SPECIFICATIONS AND CODES, LATEST EDITION.
- ALL ROLLED WIDE FLANGE (W) SECTION STRUCTURAL BEAMS SHALL BE ASTM A992
 Fy=56 KSI, BASE PLATES AND MISC. STRUCTURAL STEEL SHALL BE ASTM A-36
 FY=36 KSI. ALL HOLLOW STRUCTURAL SECTIONS (HSS) SHALL BE ASTM A-500 GRADE B,
 FY MINIMUM 46 KSI.
- ALL ANCHOR BOLTS AND THREADED RODS SHALL CONFORM TO THE REQUIREMENTS OF ASTM F-1554 GRADE 36. UNLESS NOTED OTHERWISE.
- ALL BOLTS, SHALL CONFORM TO THE REQUIREMENTS OF ASTM A-325 OR ASTM F1852 FOR 3/4" DIA. HIGH STRENGTH BOLTS UNLESS NOTED OTHERWISE.
- 5. ALL WELDING ELECTRODES SHALL BE E70XX.
- ALL WELDING SHALL BE DONE BY CERTIFIED WELDERS AND SHALL CONFORM TO THE AWS "CODE FOR ARC AND GAS WELDING IN BUILDING CONSTRUCTION", LATEST EDITION,
- NO CONNECTION SHALL CONSIST OF LESS THAN TWO 3/4" DIAMETER BOLTS OR WELDS DEVELOPING A MINIMUM OF 10,000 POUNDS UNLESS NOTED OTHERWISE.
- 8. ALL FILLET WELDS SHALL BE A MINIMUM OF 1/4" UNLESS NOTED OTHERWISE.
- 9. ALL WELDS SHALL BE VISUALLY INSPECTED.
- 10. AN INDEPENDENT STEEL TESTING AGENCY SHALL PERFORM ALL INSPECTION AND TESTING. THE STRUCTURAL STEEL FABRICATOR AND ERECTOR SHALL SCHEDULE ALL WORK TO ALLOW THE ABOVE TESTING REQUIREMENTS TO BE COMPLETED. A COPY OF ALL TEST REPORTS SHALL BE FILED WITH THE ARCHITECT.
- 11. THE CONTRACTOR SHALL BE RESPONSIBLE FOR THE CONTROL OF ALL ERECTION PROCEDURES AND SEQUENCES WITH RELATION TO TEMPERATURE DIFFERENTIALS AND STABILITY.
- 12. AFTER FABRICATION, ALL STEEL, EXCEPT THAT TO BE GALVANIZED, SHALL BE CLEANED OF ALL RUST, LOOSE MILL SCALE AND OTHER FOREIGN MATERIALS AND RECEIVE ONE COAT OF APPROVED PRIMER PAINT. ALL GALVANIZED STEEL SHALL BE PREPPED AND "TOUCHED UP" ONCE INSTALLATION IS COMPLETE.
- THE FABRICATOR SHALL FURNISH CHECKED SHOP AND ERECTION DRAWINGS AND OBTAIN APPROVAL PRIOR TO FABRICATING ANY STRUCTURAL STEEL.
- 14. CUTS, HOLES, OPENINGS, ETC. REQUIRED IN STRUCTURAL STEEL MEMBERS FOR THE WORK OF OTHER TRADES SHALL BE SHOWN ON SHOP DRAWINGS FOR STRUCTURAL STEEL AND SHALL BE MADE IN THE SHOP, CREATION OF HOLES OR CUTS IN STRUCTURAL STEEL WEMBERS IN THE FIELD WILL NOT BE PERMITTED EXCEPT WITH WRITTEN PERMISSION FROM THE ARCHITECT.

STRUCTURAL LUMBER:

- ALL MATERIAL AND WORKMANSHIP SHALL BE IN ACCORDANCE WITH THE LATEST EDITION OF "TIMBER CONSTRUCTION STANDARDS" OF THE AMERICAN INSTITUTE OF TIMBER CONSTRUCTION AND THE "NATIONAL ESIGN SPECIFICATION FOR STRESS—GRADE LUMBER AND ITS FASTENINGS" OF THE NATIONAL FOREST PRODUCTS ASSOCIATION.
- 2. THE MINIMUM GRADES AND DESIGN VALUES REQUIRED FOR STRUCTURAL LUMBER SHALL BE: CONSTRUCTION GRADE SPRUCE—PINE—FIR FC=1000 PSI E=1,300,000 PSI SPRUCE—PINE—FIR NO. 1/2 FB=875 PSI E=1,400,000 PSI E=1,400,000 PSI
- FLUSH FRAMING SHALL BE SUPPORTED BY JOIST HANGERS DESIGNED FOR THE FULL CAPACITY
 OF THE SUPPORTED MEMBER, REFER TO DRAWING FOR TYPE AND LOCATION.
- 4. ALL WOOD IN CONTACT WITH CONCRETE OR MASONRY SHALL BE PRESSURE TREATED WITH PRESSRYATIVE
- SUB-FLOORING SHALL BE 3/4" TONGUE & GROOVE APA STRUCTURAL 1 RATED SHEATHING EXPOSURE 1 UNLESS NOTED OTHERWISE.
- EXPOSURE 1 UNLESS NOTED OTHERWISE.
- ALL SIMPSON CONNECTORS (HANGERS, STRAPS, UPLIFT CONNECTORS, POST CAPS, ETC.) SHALL BE COATED WITH Z-MAX CORROSION RESISTANCE.



WILLIAM STARCK ARCHITECTS, INC. 126 COVE STREET FALL RIVER, MASSACHUSETTS 02720

08.679.5733 08.672.8556





650 PLYMOUTH AVE FALL RIVER, MA 02720

STRUCTURAL ALTERATIONS AT THE CONNELL SCHOOL

REVISIONS:

SCALE: AS NOTED

DATE: 8.15.2014

DRAWN BY: JMF


CAPA FILE: 215007.20

DRAWING NAME

FIRST FLOOR FRAMING PLAN

DRAWING NUMBER

S1.0

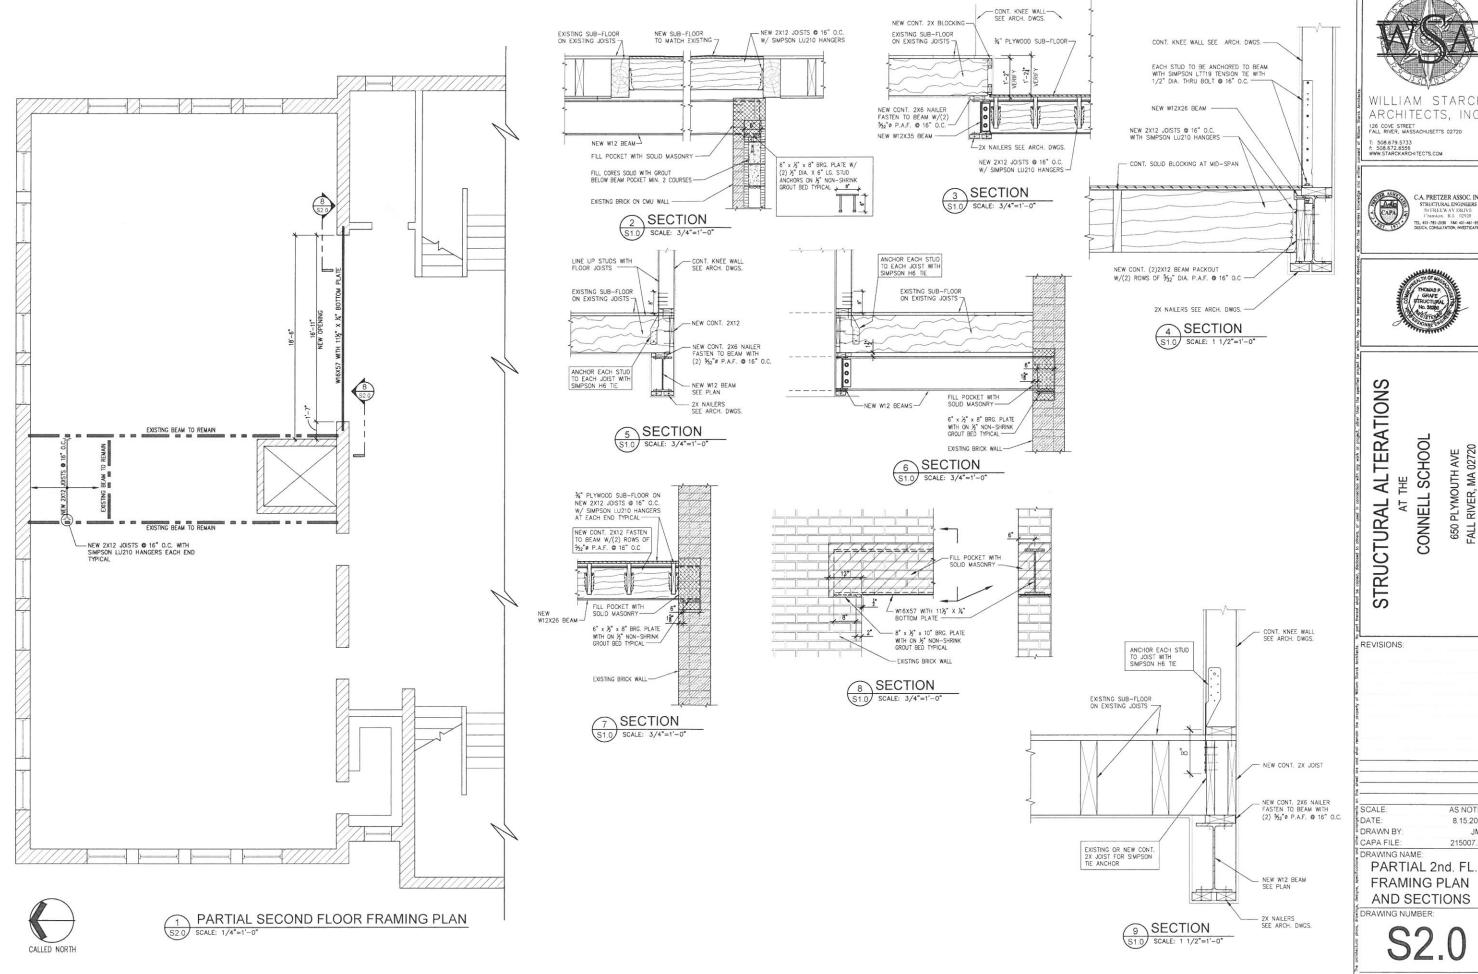



WILLIAM STARCK ARCHITECTS, INC 126 COVE STREET FALL RIVER, MASSACHUSETTS 02720



650 PLYMOUTH AVE FALL RIVER, MA 02720

AS NOTED 8.15.2014 JMF 215007.20

FRAMING PLAN AND SECTIONS