

# **REQUEST FOR DETERMINATION OF APPLICABILITY ISSUED FOR PERMITTING** FAIRHAVEN HIGH SCHOOL ATHLETIC FIELD IMPROVEMENTS **12 HUTTLESTONE AVE** FAIRHAVEN, MA 02719



### SCOPE OF WORK

BASE BID - FIELD IMPROVEMENTS

STRIPING OF TOP SOIL WITH THE STADIUMS EXISTING BRICK WALLS, REMOVAL OF EXISTING SPORTS LIGHTING, REMOVAL AND REPLACEMENT OF FENCE FABRIC, SELECTIVE DEMOLITION OF EXISTING FENCE NORTH AND SOUTH OF FIELD REPLACED BY NEW ORNAMENTAL FENCE AND BALL SAFETY NETTING. NEW ACCESSIBLE PATHWAYS NORTH AND EAST OF THE FIELD. NEW DRAINAGE AND SYNTHETIC TURF PROFILE.

ALTERNATE #1 SPORTS LIGHTING


FURNISH AND INSTALL NEW LED SPORTS LIGHTING AND ASSOCIATED ELECTRICAL DISTRIBUTION

ALTERNATE #2 RESTROOM SUPPORT BUILDING WITH STORAGE ALL DEMOLITION AND PROPOSED SITE WORK WITH THE ALT. #2 LOCATION ALONG WITH THE FURNISHING, LABOR AND INSTALLATION OF NEW RESTROOM SUPPORT BUILDING.


# PREPARED BY



## PROJECT MAPS

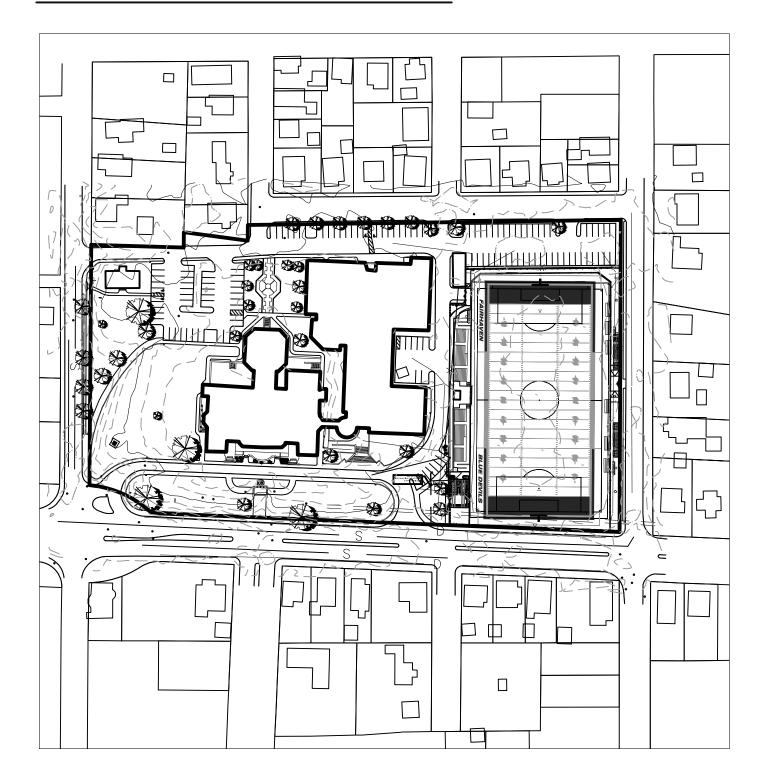

TRAVERSE LANDSCAPE ARCHITECTS PROJECT NO. A1037

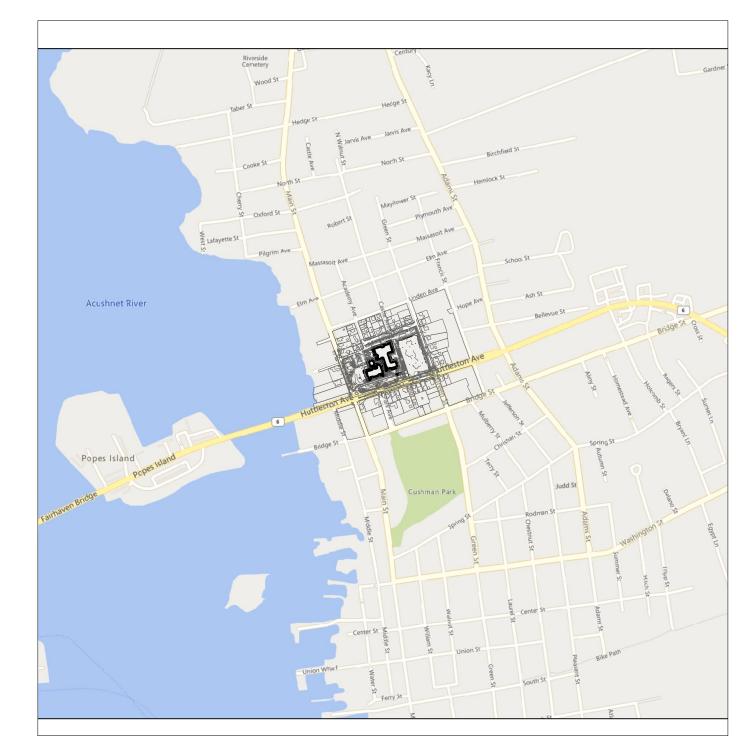

# CONTACT INFORMATION

ORGANIZATION

OWNER FAIRHAVEN SCHOOL DISTRICT 12 HUTTLESTONE AVE FAIRHAVEN, MA 02719

LANDSCAPE ARCHITECT ARCHITECTS

NAME

NICOLE POTTER (508) 979 400 EXT 140 ANDY KULAK

<u>PHONE</u>

JUSTIN ROBERTSHAW ARTHUR EDDY

(319) 440 8989 (401) 585 0017

# SHEET INDEX

| <u>SHEET</u> | DESCRIPTION                                   |
|--------------|---|
| C101         | CIVIL NOTES AND LEGEND                        |
| C201         | DEMOLITION, EROSION AND SEDIMENT CONTROL PLAN |
| C301         | GENERAL PLAN                                  |
| C401         | GRADING PLAN                                  |
| C501         | DRAINAGE AND UTILITY PLAN                     |
| C601         | CIVIL DETAILS 1                               |
| C602         | CIVIL DETAILS 2                               |
| L0.01        | LEGEND SCHEDULES AND GENERAL NOTES            |
| L1.01        | EXISTING CONDITIONS                           |
| L1.11        | OVERALL SITE PLAN                             |
| L1.21        | LANDSCAPE ATHLETICS MATERIALS PLAN            |
| L1.31        | LANDSCAPE ATHLETICS LAYOUT PLAN               |
| L3.11        | LANDSCAPE ATHLETIC DETAILS                    |
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| L3.13        | LANDSCAPE ATHLETIC DETAILS                    |
| L3.14        | LANDSCAPE ATHLETIC DETAILS                    |
| L3.15        | LANDSCAPE ATHLETIC DETAILS                    |
| L3.21        | ATHLETIC SUPPORT BUILDING DETAILS             |
| L3.22        | ATHLETIC SUPPORT BUILDING DETAILS             |



SAVE DATE:19 March 2021 PLOT DATE:19-Mar-21 4:25:03 PM Y:\JOBS\20 JOBS\20211.00 FAIRHAVEN-SYNTHETIC TURF FIELD-MA\DWGS\C101 CIVIL NOTES & LEGEND.DWG

### <u>REFERENCE</u>

- PROJECT LOCATION: FAIRHAVEN HIGH SCHOOL 12 HUTTLESTON AVENUE, FAIRHAVEN, MA. 02719
- ASSESSOR'S MAP 12, LOT 236.
- EXISTING CONDITIONS MAPPING TAKEN FROM PLAN ENTITLED "EXISTING CONDITIONS PLAN" PREPARED BY INSITE ENGINEERING SERVICES, LLC, DATED FEBRUARY 16, 2021

### **GENERAL NOTES**

- THE COMMONWEALTH OF MASSACHUSETTS STANDARD SPECIFICATIONS FOR HIGHWAYS AND BRIDGE CONSTRUCTION, 2020 EDITION OR LATEST REVISION, AND THE MASSACHUSETTS DEPARTMENT OF TRANSPORTATION CONSTRUCTION STANDARD DETAILS ARE MADE A PART HEREOF AS FULLY AND COMPLETELY AS IF ATTACHED HERETO. ALL WORK SHALL MEET OR EXCEED THE MASSACHUSETTS STANDARD SPECIFICATIONS FOR HIGHWAY AND BRIDGE CONSTRUCTION, WITH LATEST REVISIONS. THE LATEST REVISION OF THE STANDARD SPECIFICATIONS MAY BE OBTAINED AT THE MASSACHUSETTS DEPARTMENT OF TRANSPORTATION.
- 2. THE CONTRACTOR SHALL MAKE ALL NECESSARY CONSTRUCTION NOTIFICATIONS AND APPLY FOR AND OBTAIN ALL NECESSARY CONSTRUCTION PERMITS, PAY ALL FEES AND POST ALL BONDS ASSOCIATED WITH THE SAME, AND COORDINATE WITH THE ENGINEER AND OWNER'S REPRESENTATIVE AS REQUIRED. THE CONTRACTOR SHALL BE SOLELY RESPONSIBLE FOR JOB SITE SAFETY. THE CONTRACTOR SHALL PROVIDE TEMPORARY FENCING AND/OR BARRIERS 3.
- AROUND ALL OPEN EXCAVATED AREAS IN ACCORDANCE WITH OSHA FEDERAL, STATE, AND LOCAL REQUIREMENTS. THE CONTRACTOR SHALL BE RESPONSIBLE FOR VERIFYING THAT THE PROPOSED IMPROVEMENTS SHOWN ON THE PLANS DO NOT CONFLICT WITH ANY KNOWN
- EXISTING OR OTHER PROPOSED IMPROVEMENTS. IF ANY CONFLICTS ARE DISCOVERED, THE CONTRACTOR SHALL NOTIFY THE OWNER AND THE ENGINEER PRIOR TO INSTALLATION OF ANY PORTION OF THE SITE WORK WHICH WOULD BE AFFECTED. NO FIELD ADJUSTMENTS IN THE LOCATION OF SITE ELEMENTS SHALL BE MADE WITHOUT THE ENGINEERS APPROVAL.
- IF ANY DEVIATION OR ALTERATION OF THE WORK PROPOSED ON THESE DRAWINGS IS REQUIRED, THE CONTRACTOR SHALL IMMEDIATELY CONTACT AND 5. COORDINATE ANY DEVIATIONS WITH THE ENGINEER AND OWNER.
- 6. ANY AREA OUTSIDE OF THE LIMIT OF WORK THAT IS DISTURBED SHALL BE RESTORED TO ITS ORIGINAL CONDITION AT NO ADDITIONAL COST TO THE OWNER.
- 7. ALL SITE WORK SHALL MEET OR EXCEED THE SITE WORK SPECIFICATIONS PREPARED FOR THIS PROJECT.
- 8. ALL UTILITIES (LOCATION AND ELEVATION) DEPICTED SHALL BE CONSIDERED APPROXIMATE ONLY. BEFORE COMMENCING SITE WORK IN ANY AREA, CONTACT "DIG SAFE" AT 1-888-DIG-SAFE (1-888-344-7233) TO ACCURATELY LOCATE UNDERGROUND UTILITIES. ALL DAMAGE TO EXISTING UTILITIES OR STRUCTURES, AND THE COST TO REPAIR THE DAMAGES TO INITIAL CONDITIONS, AS SHOWN ON THE PLANS SHALL BE THE CONTRACTOR'S RESPONSIBILITY.
- NO EXCAVATION SHALL BE DONE UNTIL COMPANIES ARE PROPERLY NOTIFIED IN ADVANCE. NOTE THAT NOT ALL EXISTING UNDERGROUND UTILITIES ARE SHOWN. IT IS THE CONTRACTOR'S RESPONSIBILITY TO CONTACT ALL RESPECTIVE UTILITY COMPANIES TO VERIFY AND LOCATE EXISTING UTILITIES.

### LAYOUT NOTES

- 1. ALL LINES ARE PERPENDICULAR OR PARALLEL TO THE LINES FROM WHICH THEY ARE MEASURED UNLESS OTHERWISE INDICATED.
- ACCESSIBLE RAMPS SHALL BE PER THE AMERICAN WITH DISABILITIES ACT (ADA) ACCESSIBILITY GUIDELINES AND CODE OF MASSACHUSETTS REGULATIONS (CMR) TITLE 521 OF THE ARCHITECTURAL ACCESS BOARD REGULATIONS.
- PRIOR TO COMMENCING WORK, THE CONTRACTOR SHALL PERFORM BENCHMARK FIELD LEVEL VERIFICATION AND COORDINATE LAYOUT CHECK. THE CONTRACTOR SHALL CONTACT PARE CORPORATION IF ANY DISCREPANCIES ARE FOUND.
- DIMENSIONS OF PARKING SPACES AND DRIVEWAYS ARE FROM FACE OF CURB TO FACE OF CURB. DIMENSIONS FROM BUILDING ARE FROM FACE OF BUILDING TO FACE OF CURB.
- 5. ALIGN WALKWAYS ON DOORWAYS THEY SERVE TO PROVIDE MINIMUM REQUIRED MANEUVERING CLEARANCE IN ACCORDANCE WITH THE AMERICAN WITH DISABILITIES ACT (ADA) ACCESSIBILITY GUIDELINES AND CODE OF MASSACHUSETTS REGULATIONS (CMR) TITLE 521 OF THE ARCHITECTURAL ACCESS BOARD REGULATIONS.

### DEMOLITION NOTES

- THE CONTRACTOR SHALL COORDINATE ALL DEMOLITION OF STRUCTURES, PAVEMENT AND CONCRETE MATERIALS, AND UTILITIES WITH APPROPRIATE PROPOSED SITE GENERAL, GRADING, UTILITY, AND LANDSCAPING DRAWINGS.
- ALL NOTED UTILITIES TO BE REMOVED AND DISPOSED OF, RELOCATED OR CAPPED REPRESENT ALL KNOWN SITE CONDITIONS TO BE DEMOLISHED. THE CONTRACTOR SHALL COORDINATE ALL UNFORESEEN CONDITIONS WITH THE PROJECT ENGINEER, OWNER AND/OR RESPECTIVE UTILITY COMPANIES PRIOR TO PROCEEDING WITH WORK.
- 3. WATER, SEWER, DRAINAGE, GAS, AND OTHER SITE UTILITIES SERVICING THE EXISTING FACILITIES ARE TO REMAIN ACTIVE THROUGHOUT CONSTRUCTION.
- 4. THERE SHALL BE NO INTERRUPTION OF UTILITY SERVICES DURING THE CONSTRUCTION OPERATION WITHOUT APPROVAL OF THE OWNER.

### GRADING AND UTILITY NOTES

- UNDERGROUND UTILITIES DEPICTED WERE COMPILED FROM AVAILABLE RECORD PLANS AND SHALL BE CONSIDERED APPROXIMATE ONLY. BEFORE COMMENCING SITE WORK IN ANY AREA, CONTACT "DIG SAFE" AT 1-888-DIG-SAFE (1-888-344-7233) TO ACCURATELY LOCATE UNDERGROUND UTILITIES. ANY DAMAGE TO EXISTING UTILITIES OR STRUCTURES DEPICTED OR NOT DEPICTED ON THE PLANS SHALL BE THE CONTRACTOR'S RESPONSIBILITY. COSTS TO REPAIR SUCH DAMAGES SHALL BE THE CONTRACTOR'S RESPONSIBILITY. NO EXCAVATION SHALL BE DONE UNTIL UTILITY COMPANIES ARE PROPERLY NOTIFIED.
- ALL WORK PERFORMED AND ALL MATERIALS FURNISHED SHALL CONFORM WITH THE LINES AND GRADES ON THE PLANS AND SITE WORK SPECIFICATIONS. AT ALL LOCATIONS WHERE EXISTING CURBING OR PAVEMENT ABUT NEW CONSTRUCTION, THE EDGE OF THE EXISTING CURB OR PAVEMENT SHALL BE SAW
- CUT TO A CLEAN, SMOOTH EDGE. BLEND NEW PAVEMENT AND CURBS SMOOTHLY INTO EXISTING BY MATCHING LINES, GRADES AND JOINTS. 4. ALL UTILITY COVERS, GRATES, ETC. SHALL BE ADJUSTED TO BE FLUSH WITH THE SURROUNDING SURFACE OR PAVEMENT FINISH GRADE. RIM ELEVATIONS OF
- STRUCTURES AND MANHOLES ARE APPROXIMATE. FINAL ELEVATIONS ARE TO BE SET FLUSH AND CONSISTENT WITH THE GRADING PLANS. 5. THE CONTRACTOR SHALL MAKE ALL ARRANGEMENTS FOR THE ALTERATION OF PRIVATE UTILITIES BY THE UTILITY COMPANIES, AS REQUIRED.
- WHERE AN EXISTING UTILITY IS FOUND TO CONFLICT WITH THE PROPOSED WORK, THE LOCATION, ELEVATION AND SIZE OF THE UTILITY SHALL BE 6. ACCURATELY DETERMINED WITHOUT DELAY BY THE CONTRACTOR AND THE INFORMATION SHALL BE PROVIDED ON A SKETCH TO SCALE OF THE EXISTING UTILITY WITH TIES TO KNOWN POINTS, PHOTOS AND FURNISHED TO THE ENGINEER FOR RESOLUTION.
- THE CONTRACTOR SHALL PROTECT ALL UNDERGROUND DRAINAGE, SEWER AND UTILITY FACILITIES FROM EXCESSIVE VEHICULAR LOADS DURING CONSTRUCTION. ANY DAMAGE TO THESE FACILITIES RESULTING FROM CONSTRUCTION LOADS SHALL BE RESTORED TO ORIGINAL CONDITION.
- 8. GAS, ELECTRIC, AND COMMUNICATIONS ROUTING ARE SUBJECT TO REVIEW AND APPROVAL BY APPROPRIATE UTILITY COMPANIES.
- ALL GRAVITY SANITARY PIPING SHALL BE SDR-35 PVC. ALL SEWER CONSTRUCTION SHALL CONFORM TO THE TOWN OF FAIRHAVEN SEWER/WASTEWATER DEPARTMENT.
- 10. ALL WATER LINE BENDS AND TEES SHALL BE REINFORCED WITH THRUST BLOCKS. ALL WATER DISTRIBUTION PIPING AND FITTINGS MUST ADHERE TO THE TOWN OF FAIRHAVEN WATER DIVISION SPECIFICATIONS AND SHALL BE INSPECTED BEFORE, DURING, AND AFTER CONSTRUCTION PRIOR TO TAPPING THE SERVICE MAIN.
- EXCAVATION REQUIRED WITHIN THE PROXIMITY OF EXISTING UTILITY LINES SHALL BE DONE BY HAND. CONTRACTOR SHALL REPAIR ANY DAMAGE TO EXISTING UTILITY LINES OR STRUCTURES INCURRED DURING CONSTRUCTION OPERATIONS AT NO COST TO THE OWNER.
- 12. PITCH EVENLY BETWEEN SPOT GRADES. ALL PAVED AREAS MUST PITCH TO DRAIN AT A MIN. OF 1/8" PER FOOT UNLESS SPECIFIED.
- 13. THE PROPOSED WALKWAYS SHALL HAVE A MAXIMUM CROSS SLOPE OF 2% AND A MAXIMUM RUNNING SLOPE OF 5% AS SHOWN ON CONSTRUCTION DETAILS AND GRADING PLAN.

### EROSION AND SI

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- 2. THE CONTRA
- 3. THE CONTRA
- REQUIREMEN 4. SOIL EROSIO
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- ANTICIPATE **REPRESENT** 6. REQUIRED
- AND/OR OT CONSTRUCT
- 7. AS FEASIBL
- TEMPORARIL 8. THE CONTRA
- 9. EROSION AND SEDIMENTATION CONTROL MEASURES SHALL BE INSPECTED AND MAINTAINED ON A WEEKLY BASIS AND AFTER EACH STORM EVENT OF 0.25
- INCH OR GREATER DURING CONSTRUCTION TO ENSURE THAT THE EROSION CONTROL BARRIERS ARE INTACT. 10. CLEAN AND MAINTAIN SEDIMENTATION CONTROL BARRIERS WHEN SEDIMENT ACCUMULATES TO ONE HALF THE HEIGHT OF THE BARRIER. MATERIAL COLLECTED
- FROM THE SEDIMENTATION BARRIER SHALL BE REMOVED AS NECESSARY AND DISPOSED IN AN UPLAND AREA.
- STABILIZED DISCHARGE POINTS.
- REPRESENTATIVE
- PERMANENTLY STABILIZED.
- AND STATE REGULATIONS.

- STABILIZED.

| SEDIMENTATION CONTROL NOTES – MASSACHUSETTS<br>ITRACTOR SHALL BE RESPONSIBLE FOR ESTABLISHING AND MAINTAINING ALL TEMPORARY SOIL EROSION AND SEDIMENT CONTROLS IN ACCORDANCE   | EXISTING       |
|--|----------------|
| E ENVIRONMENTAL PROTECTION AGENCY'S (EPA) NATIONAL POLLUTANT DISCHARGE ELIMINATION SYSTEM (NPDES) CONSTRUCTION GENERAL PERMIT<br>ND THE CONTRACT DOCUMENTS.  |                |
| TRACTOR SHALL PREPARE AND SUBMIT A STORMWATER POLLUTION PREVENTION PLAN (SWPPP) PRIOR TO CONSTRUCTION.   |                |
| TRACTOR SHALL PREPARE AND SUBMIT AN ELECTRONIC NOTICE OF INTENT (@NOI) WITH THE EPA IN ACCORDANCE WITH THE NDPES PERMIT<br>MENTS PRIOR TO CONSTRUCTION.  |                |
| DSION AND SEDIMENTATION CONTROLS SHALL BE PROVIDED IN ACCORDANCE WITH THE "MASSACHUSETTS EROSION AND SEDIMENT CONTROL<br>ES FOR URBAN AND SUBURBAN AREAS" AND THE NOTES AND DETAILS SHOWN IN THIS PLAN SET.  | × 407.5        |
| SION AND SEDIMENTATION CONTROLS SHOWN ON THE PLANS ARE INTENDED TO REPRESENT THE MINIMUM CONTROLS NECESSARY TO MEET<br>TED SITE CONDITIONS. ADDITIONAL MEASURES SHALL BE IMPLEMENTED AS CONDITIONS WARRANT OR AS DIRECTED BY THE OWNER OR OWNER'S<br>NTATIVE.  | DD<br>WW       |
| D PERIMETER CONTROL SHALL BE PROPERLY ESTABLISHED, CLEARLY VISIBLE AND IN OPERATION PRIOR TO INITIATING ANY LAND CLEARING ACTIVITY<br>OTHER CONSTRUCTION RELATED WORK. SUCH FACILITIES SHALL REPRESENT THE LIMIT OF WORK. WORKERS SHALL BE INFORMED THAT NO<br>CTION ACTIVITY IS TO OCCUR BEYOND THE LIMIT OF WORK AT ANY TIME THROUGHOUT THE CONSTRUCTION PERIOD. | sss            |
| IBLE, CONSTRUCTION SHALL BE PHASED TO LIMIT THE AREA OF EXPOSED SOIL AND THE DURATION OF EXPOSURE. ALL DISTURBED AREAS SHALL BE<br>RILY AND/OR PERMANENTLY STABILIZED WITHIN 14 DAYS FOLLOWING COMPLETION OF GRADING ACTIVITIES.   | ———Е ————Е ——— |
| TRACTOR SHALL INSPECT AND MAINTAIN ALL EROSION AND SEDIMENTATION CONTROL MEASURES IN ACCORDANCE WITH THE CONTRACT DOCUMENTS.   | OHW            |
| AND OFFICENTATION CONTROL NELOURED CHARLER AND MAINTAINED ON A WEEKLY DADID AND AFTER FACH CTORE FOR A OF  |                |

11. THE CONTRACTOR SHALL MAINTAIN A SUFFICIENT RESERVE OF VARIOUS EROSION CONTROL MATERIALS ONSITE AT ALL TIMES FOR EMERGENCY PURPOSES OR ROUTINE MAINTENANCE. 12. THE CONTRACTOR SHALL SCHEDULE HIS WORK TO ALLOW THE FINISHED SUB GRADE ELEVATIONS TO DRAIN PROPERLY WITHOUT PUDDLING. SPECIFICALLY, ALLOW WATER TO ESCAPE WHERE PROPOSED CURB MAY RETAIN RUNOFF PRIOR TO PAVING. PROVIDE TEMPORARY POSITIVE DRAINAGE, AS REQUIRED, TO

13. CRUSHED STONE CONSTRUCTION ENTRANCES SHALL BE ESTABLISHED AT ALL POINTS OF INGRESS AND EGRESS.

14. DUST SHALL BE CONTROLLED BY SPRINKLING OR OTHER APPROVED METHODS AS NECESSARY, OR AS DIRECTED BY THE OWNER OR OWNER'S

15. CATCH BASINS AND STORM DRAINS SHALL BE PROTECTED WITH HAY BALES OR SEDIMENT BAGS IN PAVED AREAS UNTIL CONTRIBUTING AREA IS

16. DEWATERING WASTEWATER PUMPED FROM EXCAVATIONS SHALL BE CONVEYED BY HOSE TO AN UPLAND AREA AND DISCHARGED INTO A DEWATERING BASIN, HAY BALE CORRALS, OR SEDIMENTATION BAGS.

17. CONSTRUCTION SITE WASTE MATERIALS SHALL BE PROPERLY CONTAINED ONSITE AND DISPOSED OFF SITE AT A LOCATION IN ACCORDANCE WITH THE LOCAL

18. RIPRAP OR OTHER ENERGY DISSIPATERS SHALL BE USED WHERE NECESSARY TO CONTROL EROSION.

19. ANY EQUIPMENT THAT IS NOT READILY MOBILE (TRACK MACHINERY) SHALL BE PARKED WITHIN THE PROJECT LIMIT OF DISTURBANCE. LARGE AND/OR BULKY MATERIALS SHALL BE STORED SUCH THAT THEY DO NOT INTERFERE WITH THE ONGOING CONSTRUCTION ACTIVITIES OR EROSION CONTROL MEASURES. 20. THE CONTRACTOR SHALL NOT REMOVE ANY COMPOST FILTER SOCKS OR OTHER EROSION CONTROLS UNTIL THE CONTRIBUTING AREA IS PERMANENTLY

21. ALL DRAINAGE STRUCTURES SHALL BE CLEARED OF ACCUMULATED SEDIMENT PRIOR TO ACCEPTANCE OF THE FINAL PROJECT. THE CONTRACTOR SHALL SCHEDULE HIS WORK TO ALLOW THE FINISHED SUB GRADE ELEVATIONS TO DRAIN PROPERLY WITHOUT PONDING. SPECIFICALLY, ALLOW WATER TO ESCAPE WHERE PROPOSED CURB MAY RETAIN RUNOFF PRIOR TO APPLICATION OF SURFACE PAVING. PROVIDE TEMPORARY POSITIVE DRAINAGE, AS REQUIRED, TO STABILIZED DISCHARGE POINTS.

22. INSTALLATION OF THE EROSION CONTROL BARRIERS AS ILLUSTRATED IS INTENDED TO REPRESENT THE MINIMUM SEDIMENTATION CONTROL FACILITIES NECESSARY TO MEET ANTICIPATED SITE CONDITIONS. ADDITIONAL EROSION CONTROL MEASURES SHALL BE IMPLEMENTED AS CONDITIONS WARRANT OR AS DIRECTED BY THE OWNER OR OWNER'S REPRESENTATIVE.

23. ALL DISTURBED AREAS SHALL BE STABILIZED WITHIN 14 DAYS UPON COMPLETION OF WORK IN THAT AREA

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### **CONSTRUCTION NOTES**

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| $\langle$ | DFG  | > | = | REMO   |
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| PROPERTY LINE          |
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| SETBACKS               |
| EASEMENT LINE          |
| CONTOUR                |
| SPOT ELEVATION         |
| DRAINAGE LINE          |
| WATER LINE             |
| SANITARY SEWER LINE    |
| GAS LINE               |
| ELECTRIC               |
| OVERHEAD ELECTRIC LINE |
| LIMIT OF DISTURBANCE   |
| CATCH BASIN            |
| DRAINAGE MANHOLE       |
| SEWER MANHOLE          |
| UTILITY POLE           |
| WATER VALVE            |
| GAS GATE               |

LIGHT POLE CHAIN LINK FENCE CURBING

EDGE OF PAVEMENT

SAWCUT LINE COMPOST FILTER SOCK

TEST PIT

IUST TO GRADE

ENT CONCRETE WALK

TRUCTION ENTRANCE

IPOST FILTER SOCK (SEE DETAIL)

CUT AND MATCH

NECT TO EXISTING

OVE AND DISPOSE CONCRETE WALK

OVE AND DISPOSE DRAINAGE

OVE AND DISPOSE FENCE

OVE AND DISPOSE FRAME & GRATE

OVE AND DISPOSE FLEXIBLE PAVMENT

OVE AND DISPOSE LIGHT POLE INE TREE PROTECTION

TING TO REMAIN. PROTECT DURING CONSTRUCTION.

VALVE

MIXED ASPHALT PAVEMENT (SEE DETAIL)

TO ELECTRICAL DRAWINGS

TO LANDSCAPE DRAWINGS

OVE AND DISPOSE

OVE AND STOCKPILE

PORARY INLET PROTECTION

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|                                     | CIVIL NOTES  | S & LEGE                               | ND  |
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| PROJ                                | ECT NAME   |  |   |
| PROJ                                |  |  |   |
| PROJ                                | FAIRHAV  | 'EN HIGH<br>OOL                        |   |
| PROJ                                | FAIRHAV<br>SCH   | _                                      |   |
| PROJ                                | FAIRHAV<br>SCH   | OOL<br>.ETIC                           |   |
|                                     | FAIRHAV<br>SCH<br>ATHL   | OOL<br>.ETIC                           |   |
| PROJ                                | FAIRHAV<br>SCH<br>ATHL<br>FIELD-SYNT   | OOL<br>.ETIC                           |   |
| PROJ<br>12 HU                       | FAIRHAV<br>SCH<br>ATHL<br>FIELD-SYNT   | OOL<br>.ETIC                           |   |
| PROJ<br>12 HU <sup>T</sup><br>FAIRH | FAIRHAV<br>SCH<br>ATHL<br>FIELD-SYNT<br>ECT ADDRESS<br>TTLESTONE AVE<br>AVEN , MA 02719  | OOL<br>.ETIC                           | JRF   |
| PROJ<br>12 HU <sup>T</sup><br>FAIRH | FAIRHAV<br>SCH<br>ATHL<br>FIELD-SYNT<br>ECT ADDRESS  | OOL<br>ETIC<br>HETIC TU                | JRF   |
| PROJ<br>12 HU<br>FAIRH              | FAIRHAV<br>SCH<br>ATHL<br>FIELD-SYNT<br>ECT ADDRESS<br>ITLESTONE AVE<br>AVEN , MA 02719  | OOL<br>ETIC<br>HETIC TU                | JRF   |
| PROJ<br>12 HU<br>FAIRH<br>SUBM      | FAIRHAV<br>SCH<br>ATHL<br>FIELD-SYNT<br>ECT ADDRESS<br>ITLESTONE AVE<br>AVEN , MA 02719  | OOL<br>LETIC<br>HETIC TU               | JRF<br>DATE<br>2021/01/29                             |
| PROJ<br>12 HU<br>FAIRH<br>SUBM      | FAIRHAV<br>SCH<br>ATHL<br>FIELD-SYNT<br>ECT ADDRESS<br>TTLESTONE AVE<br>AVEN , MA 02719  | OOL<br>LETIC<br>HETIC TU               | JRF<br>DATE<br>2021/01/29<br>2021/03/05               |
| PROJ<br>12 HU<br>FAIRH              | FAIRHAV<br>SCH<br>ATHL<br>FIELD-SYNT<br>ECT ADDRESS<br>TTLESTONE AVE<br>AVEN , MA 02719<br>ITTAL<br>SCHEMATIC DES<br>DESIGN DEVELOPP<br>SUED FOR PERMI | OOL<br>LETIC<br>HETIC TU               | JRF<br>DATE<br>2021/01/29<br>2021/03/05<br>2021/03/22 |
| PROJ<br>12 HU<br>FAIRH<br>SUBM      | FAIRHAV<br>SCH<br>ATHL<br>FIELD-SYNT<br>ECT ADDRESS<br>TTLESTONE AVE<br>AVEN , MA 02719  | OOL<br>LETIC<br>HETIC TU               | JRF<br>DATE<br>2021/01/29<br>2021/03/05               |
| PROJ<br>12 HU<br>FAIRH              | FAIRHAV<br>SCH<br>ATHL<br>FIELD-SYNT<br>ECT ADDRESS<br>TTLESTONE AVE<br>AVEN , MA 02719<br>ITTAL<br>SCHEMATIC DES<br>DESIGN DEVELOPP<br>SUED FOR PERMI | OOL<br>LETIC<br>HETIC TU               | JRF<br>DATE<br>2021/01/29<br>2021/03/05<br>2021/03/22 |
| PROJ<br>12 HU<br>FAIRH              | FAIRHAV<br>SCH<br>ATHL<br>FIELD-SYNT<br>ECT ADDRESS<br>TTLESTONE AVE<br>AVEN , MA 02719<br>ITTAL<br>SCHEMATIC DES<br>DESIGN DEVELOPP<br>SUED FOR PERMI | OOL<br>LETIC<br>HETIC TU               | JRF<br>DATE<br>2021/01/29<br>2021/03/05<br>2021/03/22 |
| PROJ<br>12 HU<br>FAIRH              | FAIRHAV<br>SCH<br>ATHL<br>FIELD-SYNT<br>ECT ADDRESS<br>TTLESTONE AVE<br>AVEN , MA 02719<br>ITTAL<br>SCHEMATIC DES<br>DESIGN DEVELOPP<br>SUED FOR PERMI | OOL<br>LETIC<br>HETIC TU               | JRF<br>DATE<br>2021/01/29<br>2021/03/05<br>2021/03/22 |
| PROJ<br>12 HU<br>FAIRH              | FAIRHAV<br>SCH<br>ATHL<br>FIELD-SYNT<br>ECT ADDRESS<br>TTLESTONE AVE<br>AVEN , MA 02719<br>ITTAL<br>SCHEMATIC DES<br>DESIGN DEVELOPP<br>SUED FOR PERMI | OOL<br>LETIC<br>HETIC TU               | JRF<br>DATE<br>2021/01/29<br>2021/03/05<br>2021/03/22 |
|                                     | FAIRHAV<br>SCH<br>ATHL<br>FIELD-SYNT<br>ECT ADDRESS<br>TTLESTONE AVE<br>AVEN , MA 02719<br>ITTAL<br>SCHEMATIC DES<br>DESIGN DEVELOPP<br>SUED FOR PERMI | OOL<br>LETIC<br>HETIC TU               | JRF<br>DATE<br>2021/01/29<br>2021/03/22<br>DATE       |

# NOT FOR CONSTRUCTION

PROJ. NO.

SHEET NO.

A1037

C101

### **DEMOLITION NOTES:**

- 1. UTILITY SERVICE TO THE FACILITY SHALL NOT BE INTERRUPTED DUE TO UTILITY WORK SHOWN HEREON. ALL UTILITIES SHALL BE MAINTAINED THROUGHOUT CONSTRUCTION.
- 3. PRIOR TO COMMENCING SITE WORK IN ANY AREA, THE CONTRACTOR SHALL LOCATE EXISTING UTILITIES WITH THE PROJECT AREA USING GROUND-PENETRATING RADAR OR OTHER NONDESTRUCTIVE SURVEY METHODS. THE CONTRACTOR SHALL BE RESPONSIBLE FOR ANY EXISTING UTILITIES OR STRUCTURES WITHIN THE PROJECT AREA DEPICTED AND NOT DEPICTED ON THE PLANS. ANY DAMAGE TO EXISTING WORKING UTILITIES OR STRUCTURES NOT INTENDED TO BE REMOVED SHALL BE RESTORED TO ORIGINAL CONDITION AT NO ADDITIONAL COST TO THE OWNER.

CFS

-LOD

DFG

DF

DCW

CFS

(TYP.)

( DLP )

СМ

(TYP.)

DF

ETR


BLEACHERS

- 4. PRIOR TO ANY UTILITY AND/OR DRAINAGE SYSTEM DEMOLITION, PROVISIONS FOR MAINTAINING THE UTILITY SHALL BE APPROVED BY THE OWNER OR THE OWNER'S REPRESENTATIVE BEFORE ANY RELATED WORK MAY COMMENCE.
- 5. ALL TEMPORARILY CUT UTILITIES SHALL BE PROTECTED FROM SEDIMENTATION UNTIL IT IS CONNECTED IN ITS POST-CONSTRUCTION POSITION.
- 6. REFER TO ELECTRICAL SITE PLAN FOR ALL ELECTRICAL AND TELECOMMUNICATIONS WORK, INCLUDING DEMOLITION.
- 7. REFER TO "CIVIL NOTES AND LEGEND" FOR ADDITIONAL NOTES.

### EROSION AND SEDIMENT CONTROL NOTES:


- 1. THE EROSION AND SEDIMENTATION CONTROLS SHOWN ON THE PLANS ARE INTENDED TO REPRESENT THE MINIMUM CONTROLS NECESSARY TO MEET ANTICIPATED SITE CONDITIONS. ADDITIONAL MEASURES SHALL BE IMPLEMENTED AS CONDITIONS WARRANT OR AS DIRECTED BY THE OWNER OR OWNER'S REPRESENTATIVE.
- 2. CONTRACTOR SHALL FURNISH, INSTALL, AND MAINTAIN SILT SACKS IN ALL EXISTING AND NEWLY INSTALLED CATCH BASINS UNTIL THE UPSTREAM AREA IS STABILIZED.
- 3. CONTRACTOR SHALL INSTALL AND MAINTAIN CONSTRUCTION ENTRANCES AT ALL POINTS OF EGRESS FROM THE SITE THROUGHOUT CONSTRUCTION.
- 4. THE CONTRACTOR SHALL MAINTAIN EROSION CONTROLS THROUGHOUT CONSTRUCTION. THE CONTRACTOR SHALL REPLACE DAMAGED EROSION CONTROLS AT THE OWNER AND ENGINEER'S REQUEST AT NO ADDITIONAL EXPENSE TO THE OWNER.
- 5. THE CONTRACTOR SHALL NOT LEAVE DISTURBED AREAS UNSTABILIZED FOR PERIODS MORE THAN 14 DAYS. PROVIDE TEMPORARY SEED OR MULCH ON DISTURBED AREAS THAT WILL REMAIN EXPOSED FOR GREATER THAN 14 DAYS.
- 6. INSTALL EROSION CONTROLS DOWNSTREAM OF ANY DISTURBED AREAS TO REDUCE POTENTIAL FOR EROSION. CONTRACTOR SHALL INDICATE LOCATIONS OF EROSION CONTROLS FOR REVIEW WITH GENERAL CONTRACTOR AND OWNER'S REPRESENTATIVE PRIOR TO COMMENCING WORK.
- 7. REFER TO "CIVIL NOTES AND LEGEND" FOR ADDITIONAL NOTES.

DLP LEGEND: TIP  $(\bigcirc)$ PROTECT EXISTING TREE TO REMAIN ETR PRESS BOX PRIOR TO COMMENCING WORK, CONTRACTOR SHALL EXCAVATE TEST PIT TO CONFIRM LOCATION, ELEVATION, AND SIZE OF UTILITY. PROVIDE INFORMATION TO ENGINEER. CFS (TYP.) ETR BLEACHERS INV(N) = 4.4DFG СМ DF DF DLP SIDEWALK 1111 1111 ETR 3 DRAINAGE DTP DD DRAINAGE -CUT AND CAP DF HUTTLESTON AVE

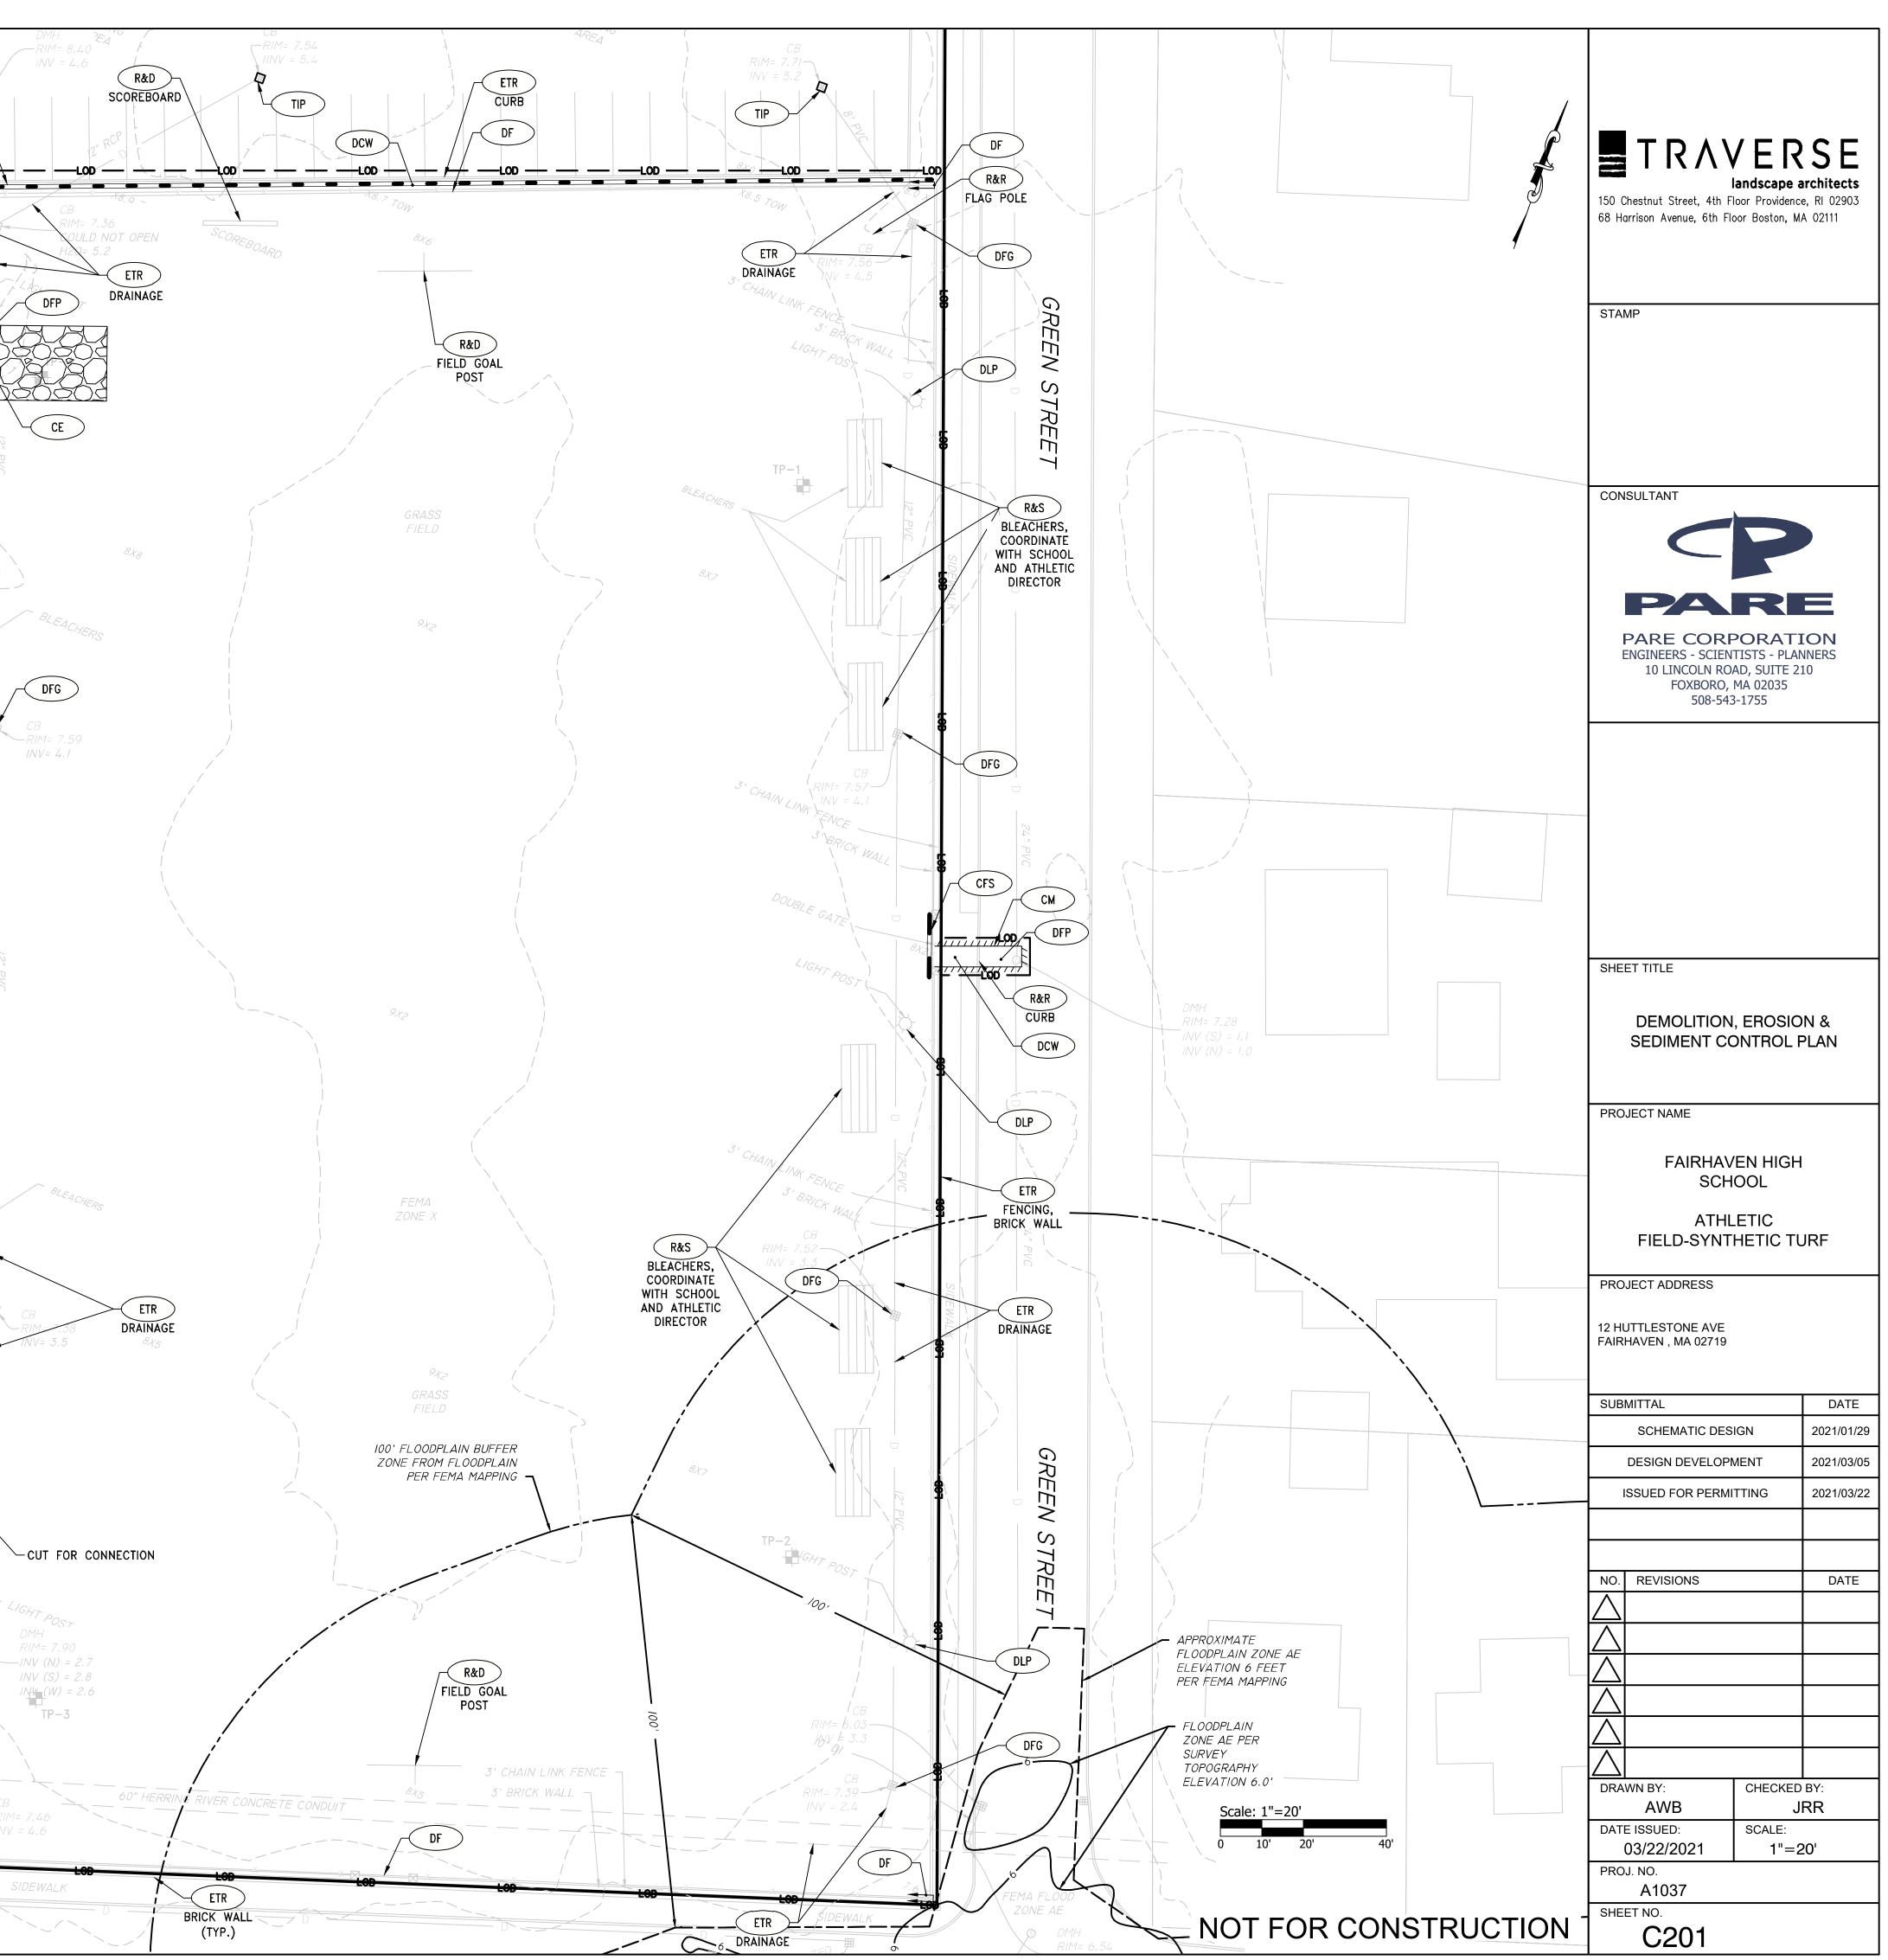

**ESIGN DEVELOPMENT-**

- LANDSCAPE DRAWINGS.
- WARNING PAVERS.
- PROFESSIONAL LAND SURVEYOR REGISTERED IN THE COMMONWEALTH OF AND SITE IMPROVEMENTS. THE CONTRACTOR'S SURVEYOR SHALL COORDINATE THE BUILDING LAYOUT WITH THE PROJECT LAND SURVEYOR TO ACCURATELY LOCATE THE BUILDING ON THE SITE.

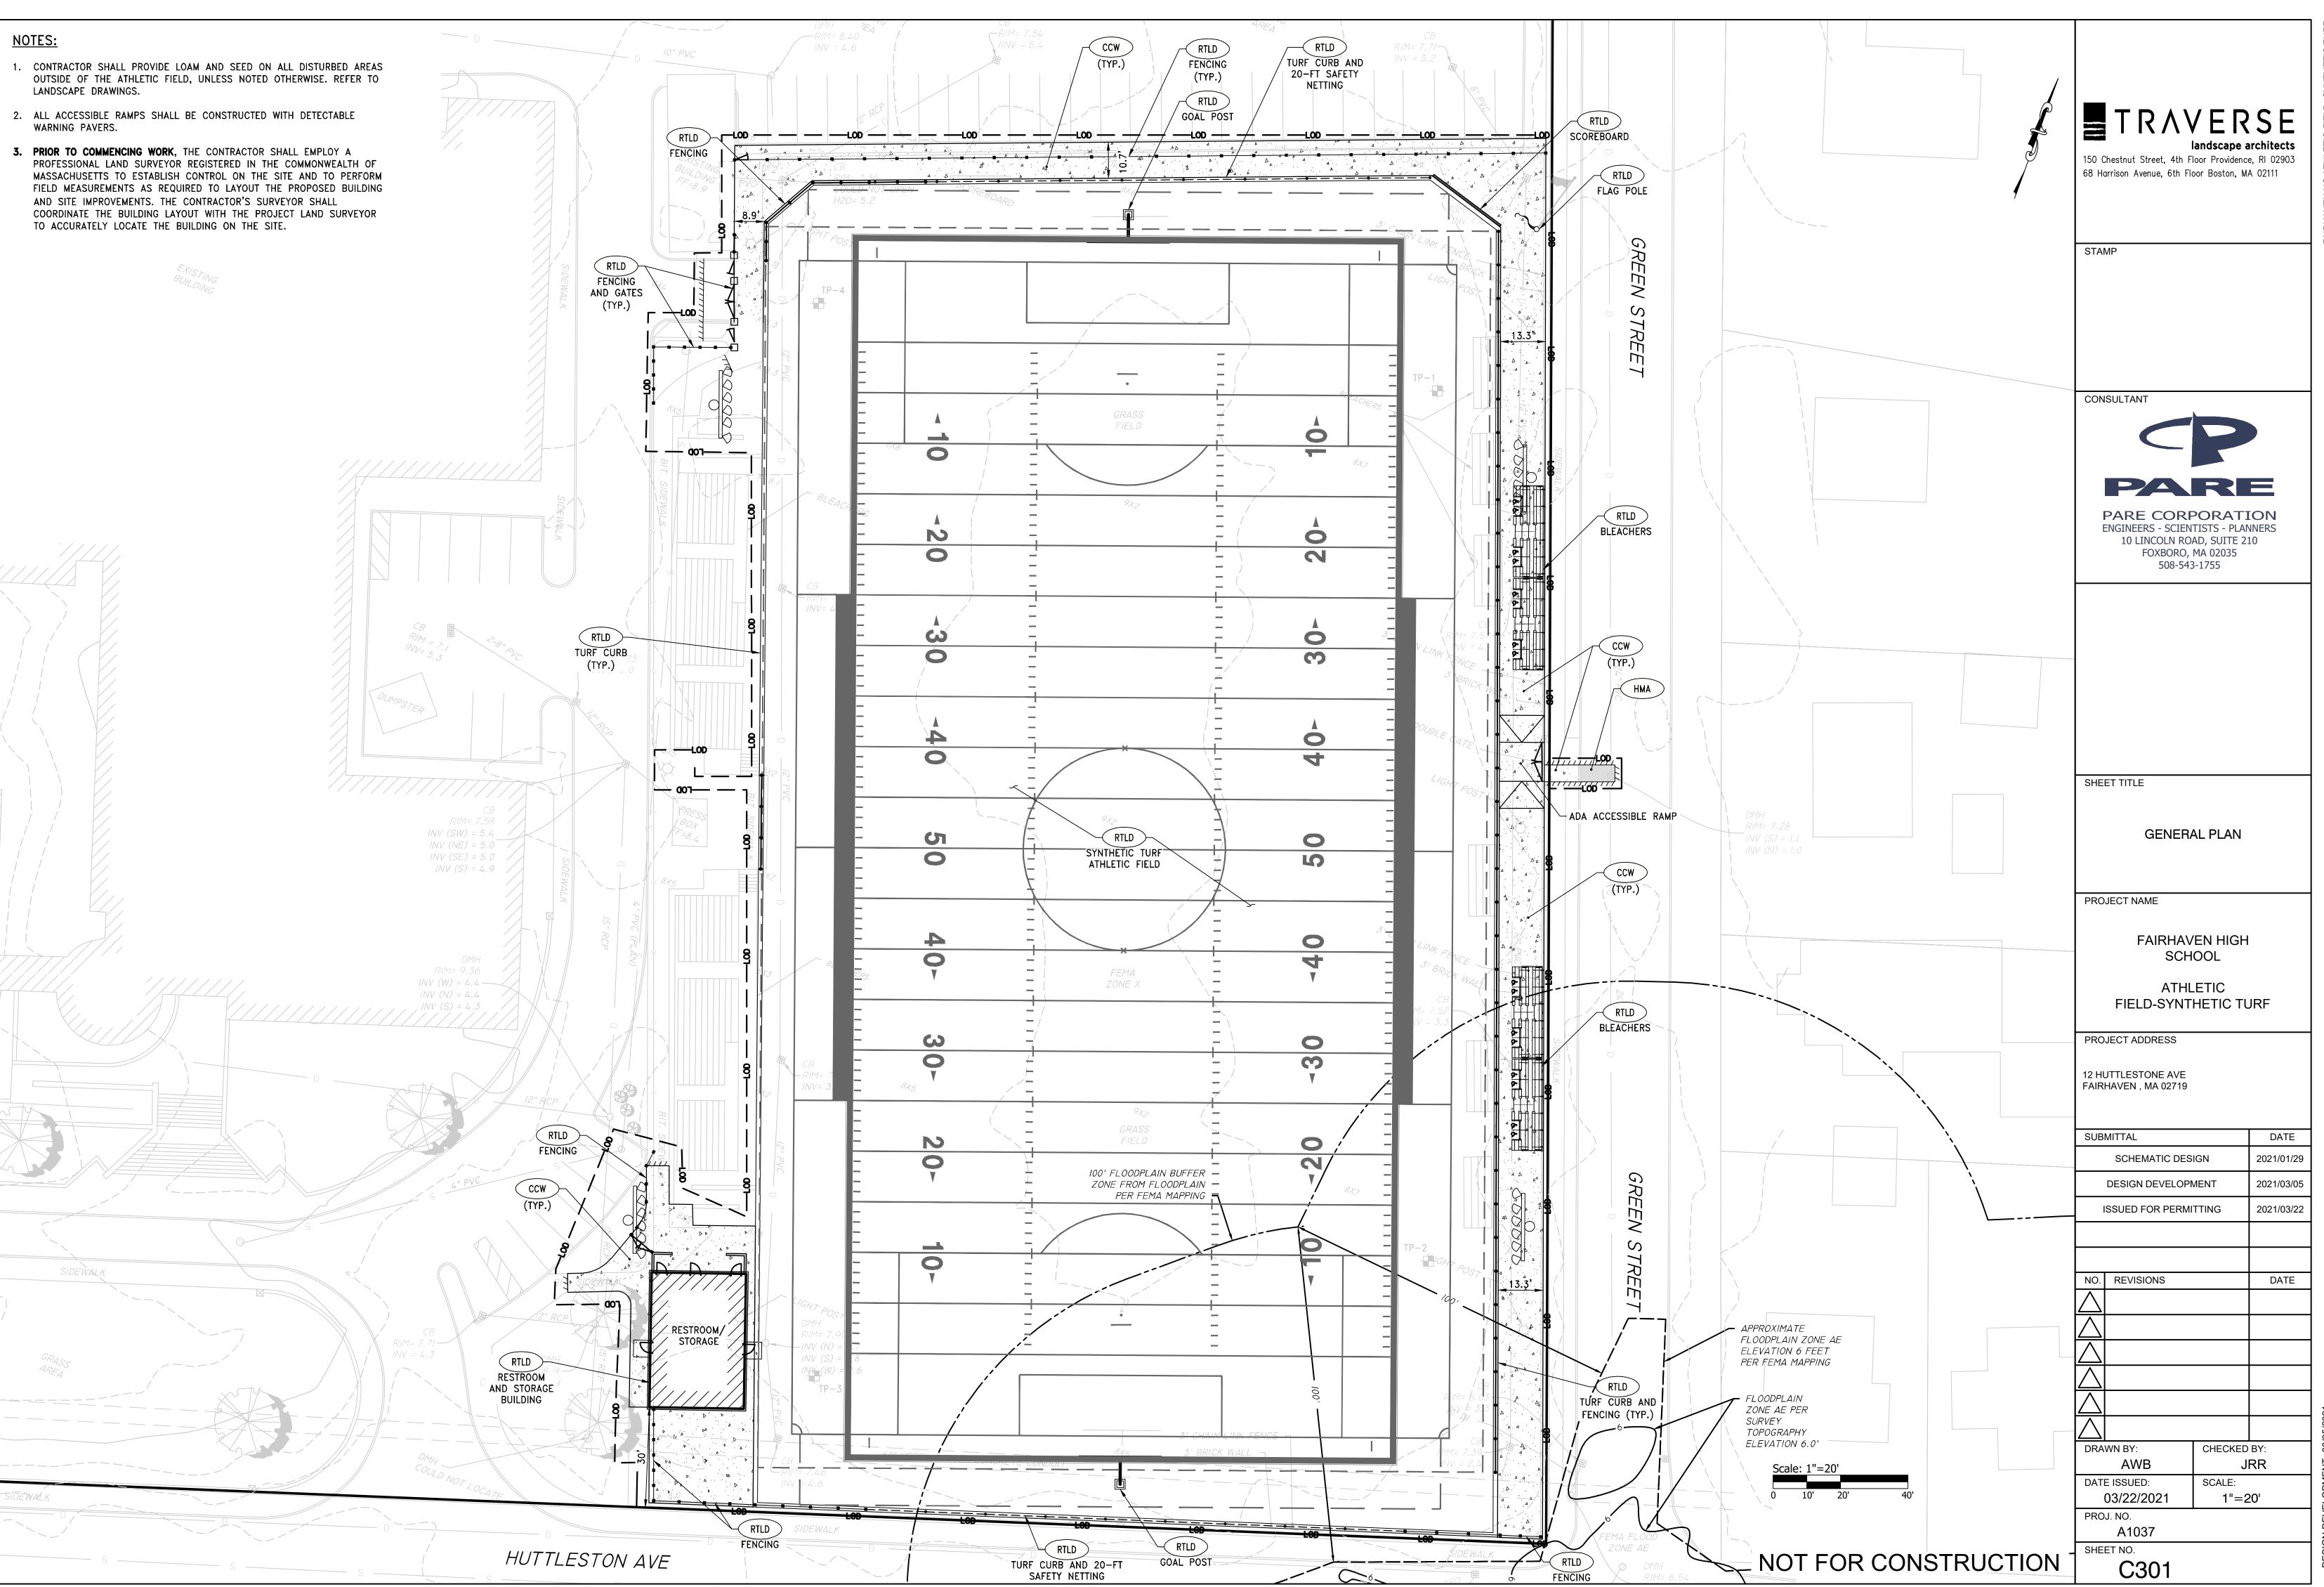

### <u>NOTES:</u>

SIDEWALK

- 1. AT ALL LOCATIONS WHERE EXISTING CURBING OR PAVEMENT ABUT NEW CONSTRUCTION, THE EDGE OF THE EXISTING CURB OR PAVEMENT SHALL BE SAW CUT TO A CLEAN, SMOOTH EDGE. BLEND NEW PAVEMENT AND CURBS SMOOTHLY INTO EXISTING BY MATCHING LINES, GRADES AND JOINTS.
- 2. ALL UTILITY COVERS, GRATES, ETC. SHALL BE ADJUSTED TO BE FLUSH WITH THE SURROUNDING SURFACE OR PAVEMENT FINISH GRADE. RIM ELEVATIONS OF STRUCTURES AND MANHOLES ARE APPROXIMATE. FINAL ELEVATIONS ARE TO BE SET FLUSH AND CONSISTENT WITH THE GRADING PLANS.
- 3. PITCH EVENLY BETWEEN SPOT GRADES. ALL PAVED AREAS MUST PITCH TO DRAIN AT A MIN. OF 1/8" PER FOOT UNLESS SPECIFIED.
- 4. THE PROPOSED WALKWAYS SHALL HAVE A MAXIMUM CROSS SLOPE OF 2% AND A MAXIMUM RUNNING SLOPE OF 5% AS SHOWN ON CONSTRUCTION DETAILS.
- 5. ALL GRADING AT ACCESSIBLE ROUTES SHALL COMPLY WITH THE RULES AND REGULATIONS OF THE AMERICANS WITH DISABILITIES ACT (ADA) OF 2010, LATEST EDITION.

6. REFER TO "CIVIL NOTES AND LEGEND" FOR ADDITIONAL NOTES.

HUTTLESTON AVE

1007

<u>(8.82)</u>

8.67

(8.67) ×

(8.52)


(8.90) (8.82)

**—LOD** : :


/ RESTROOM/
/ STORAGE


(8.81)

<u>(8.52</u>)

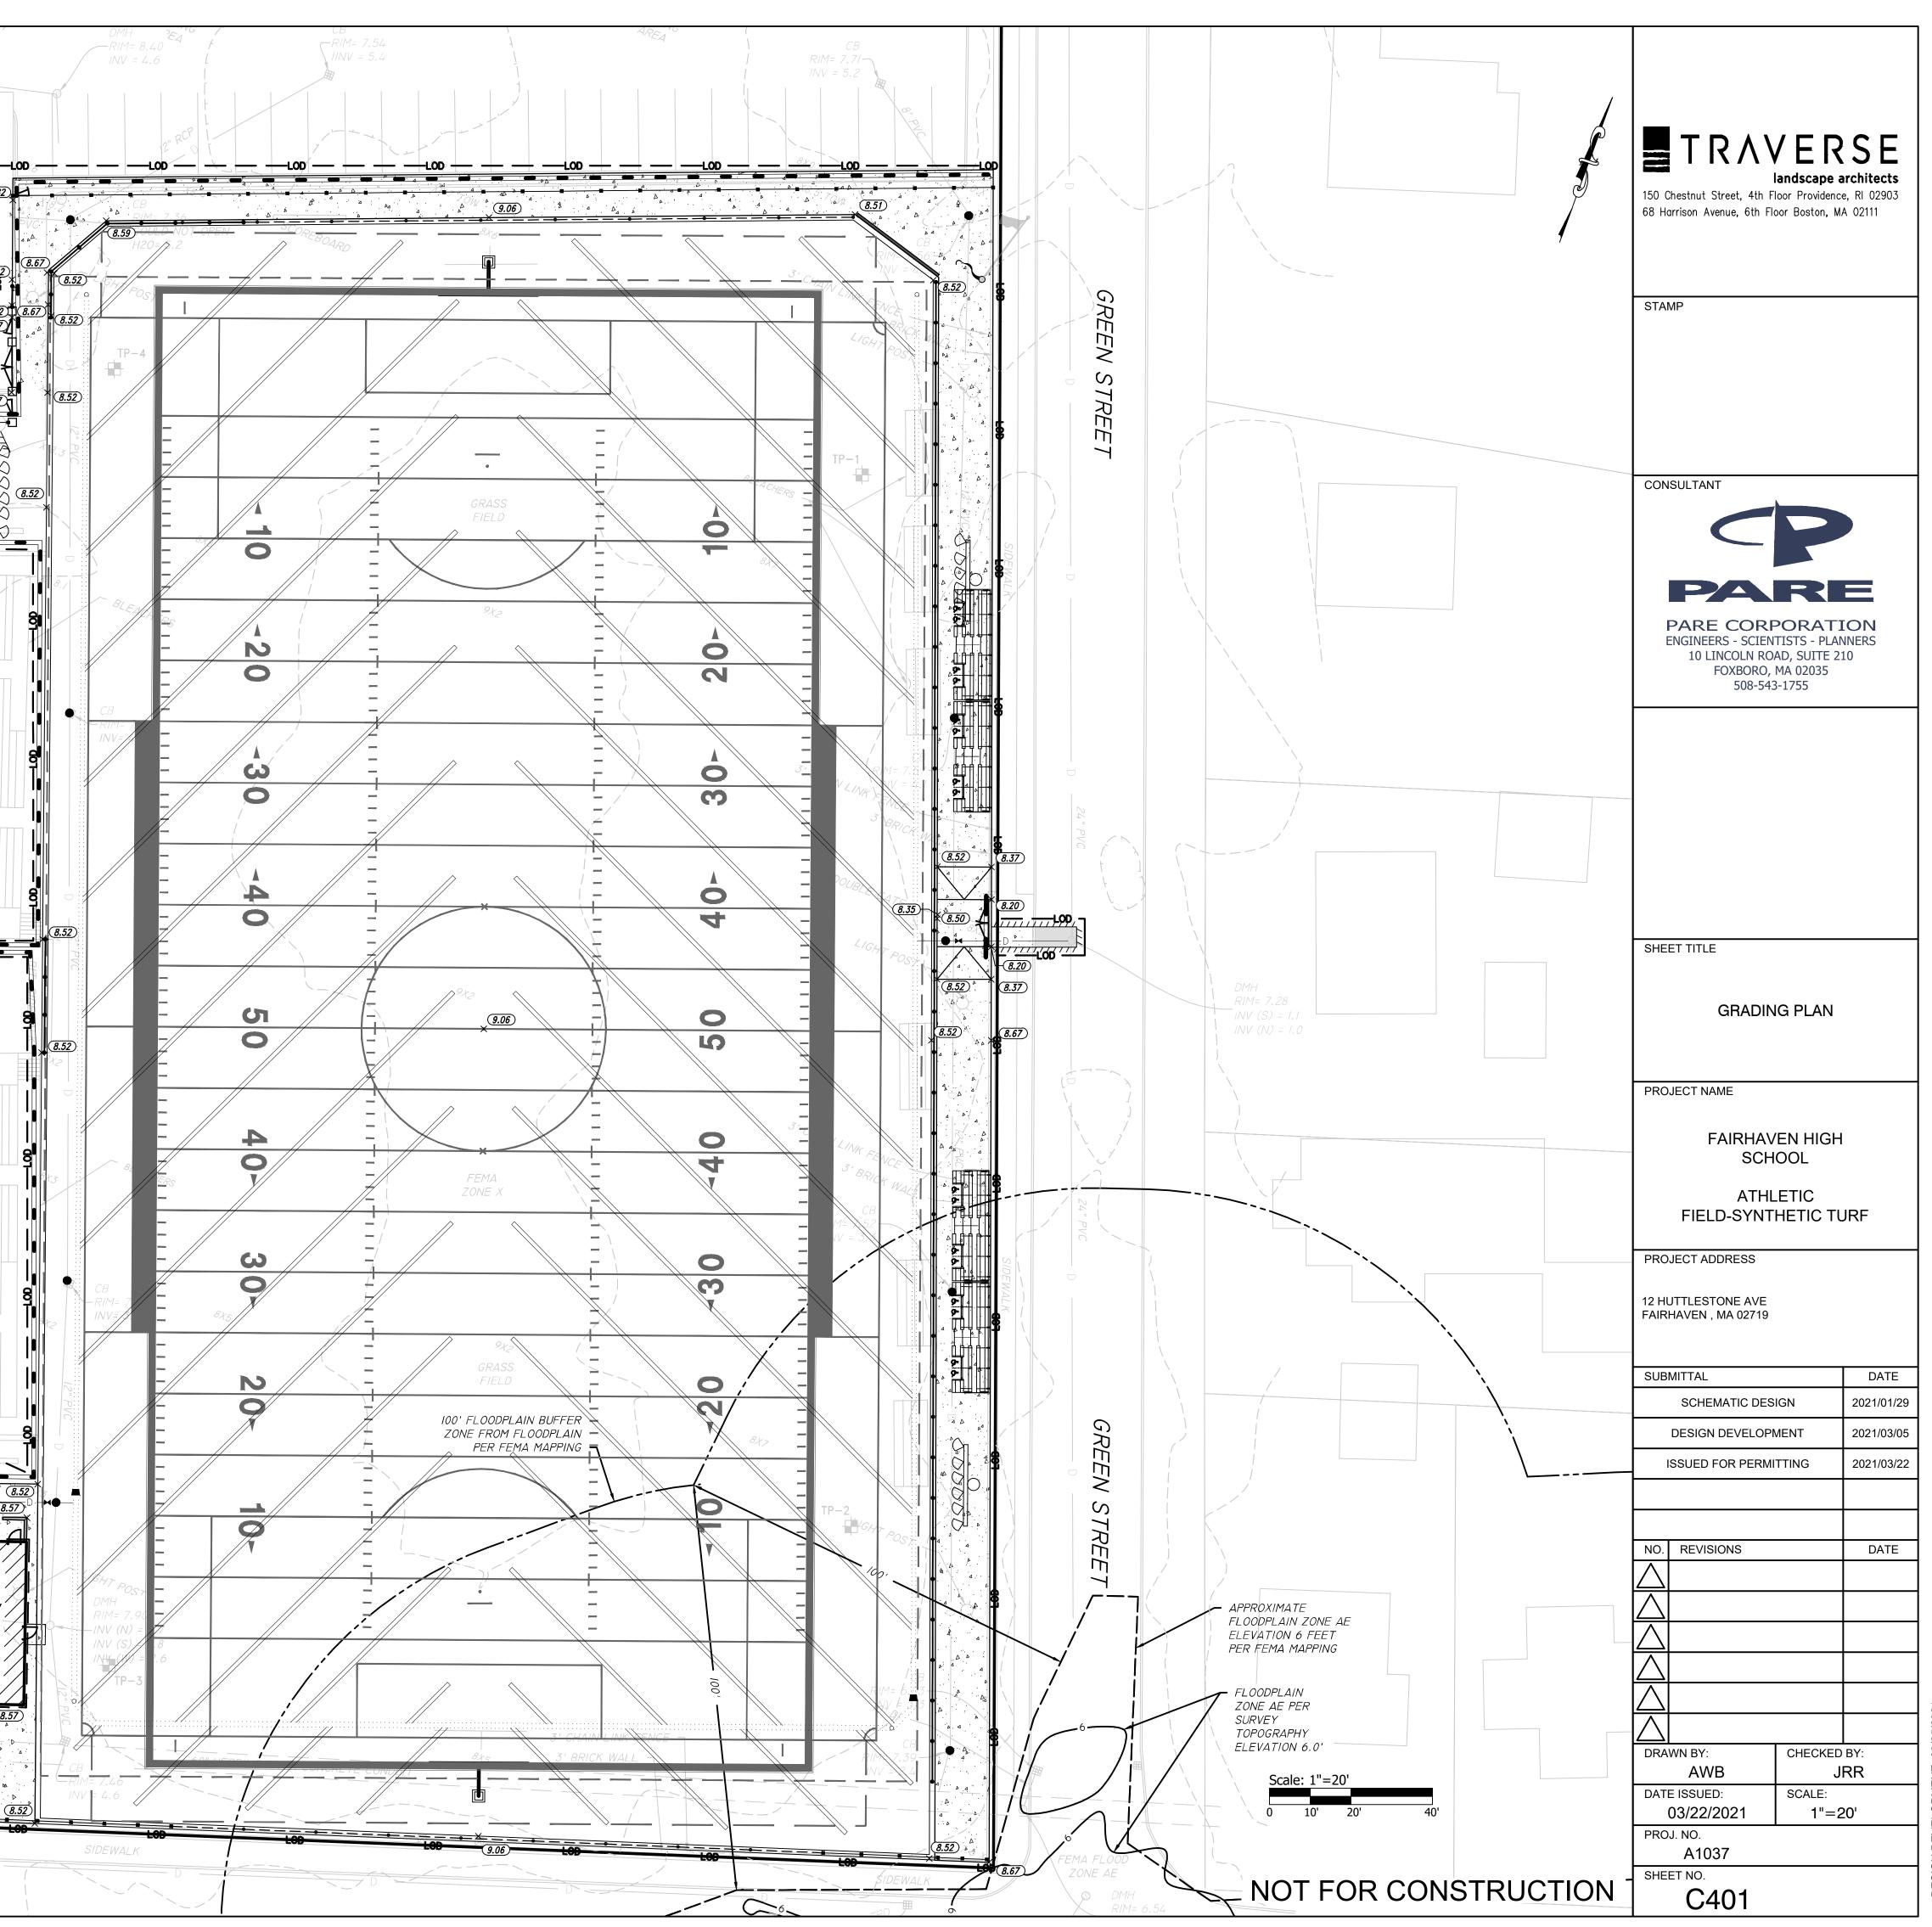

- NOTED OTHERWISE.
- UNLESS NOTED OTHERWISE.
- PER THE DETAIL.
- AND STRUCTURES. ALL ELECTRICAL FACILITIES DISPLAYED FOR REFERENCE ONLY.
- ADDITIONAL COST TO THE OWNER.
- SHALL BE DESIGNED, FURNISHED AND INSTALLED BY THE CONTRACTOR. THIS INCLUDES ALL WATER AND ELECTRICAL COMPONENTS INSTALLED PER MANUFACTURERS RECOMMENDATIONS.

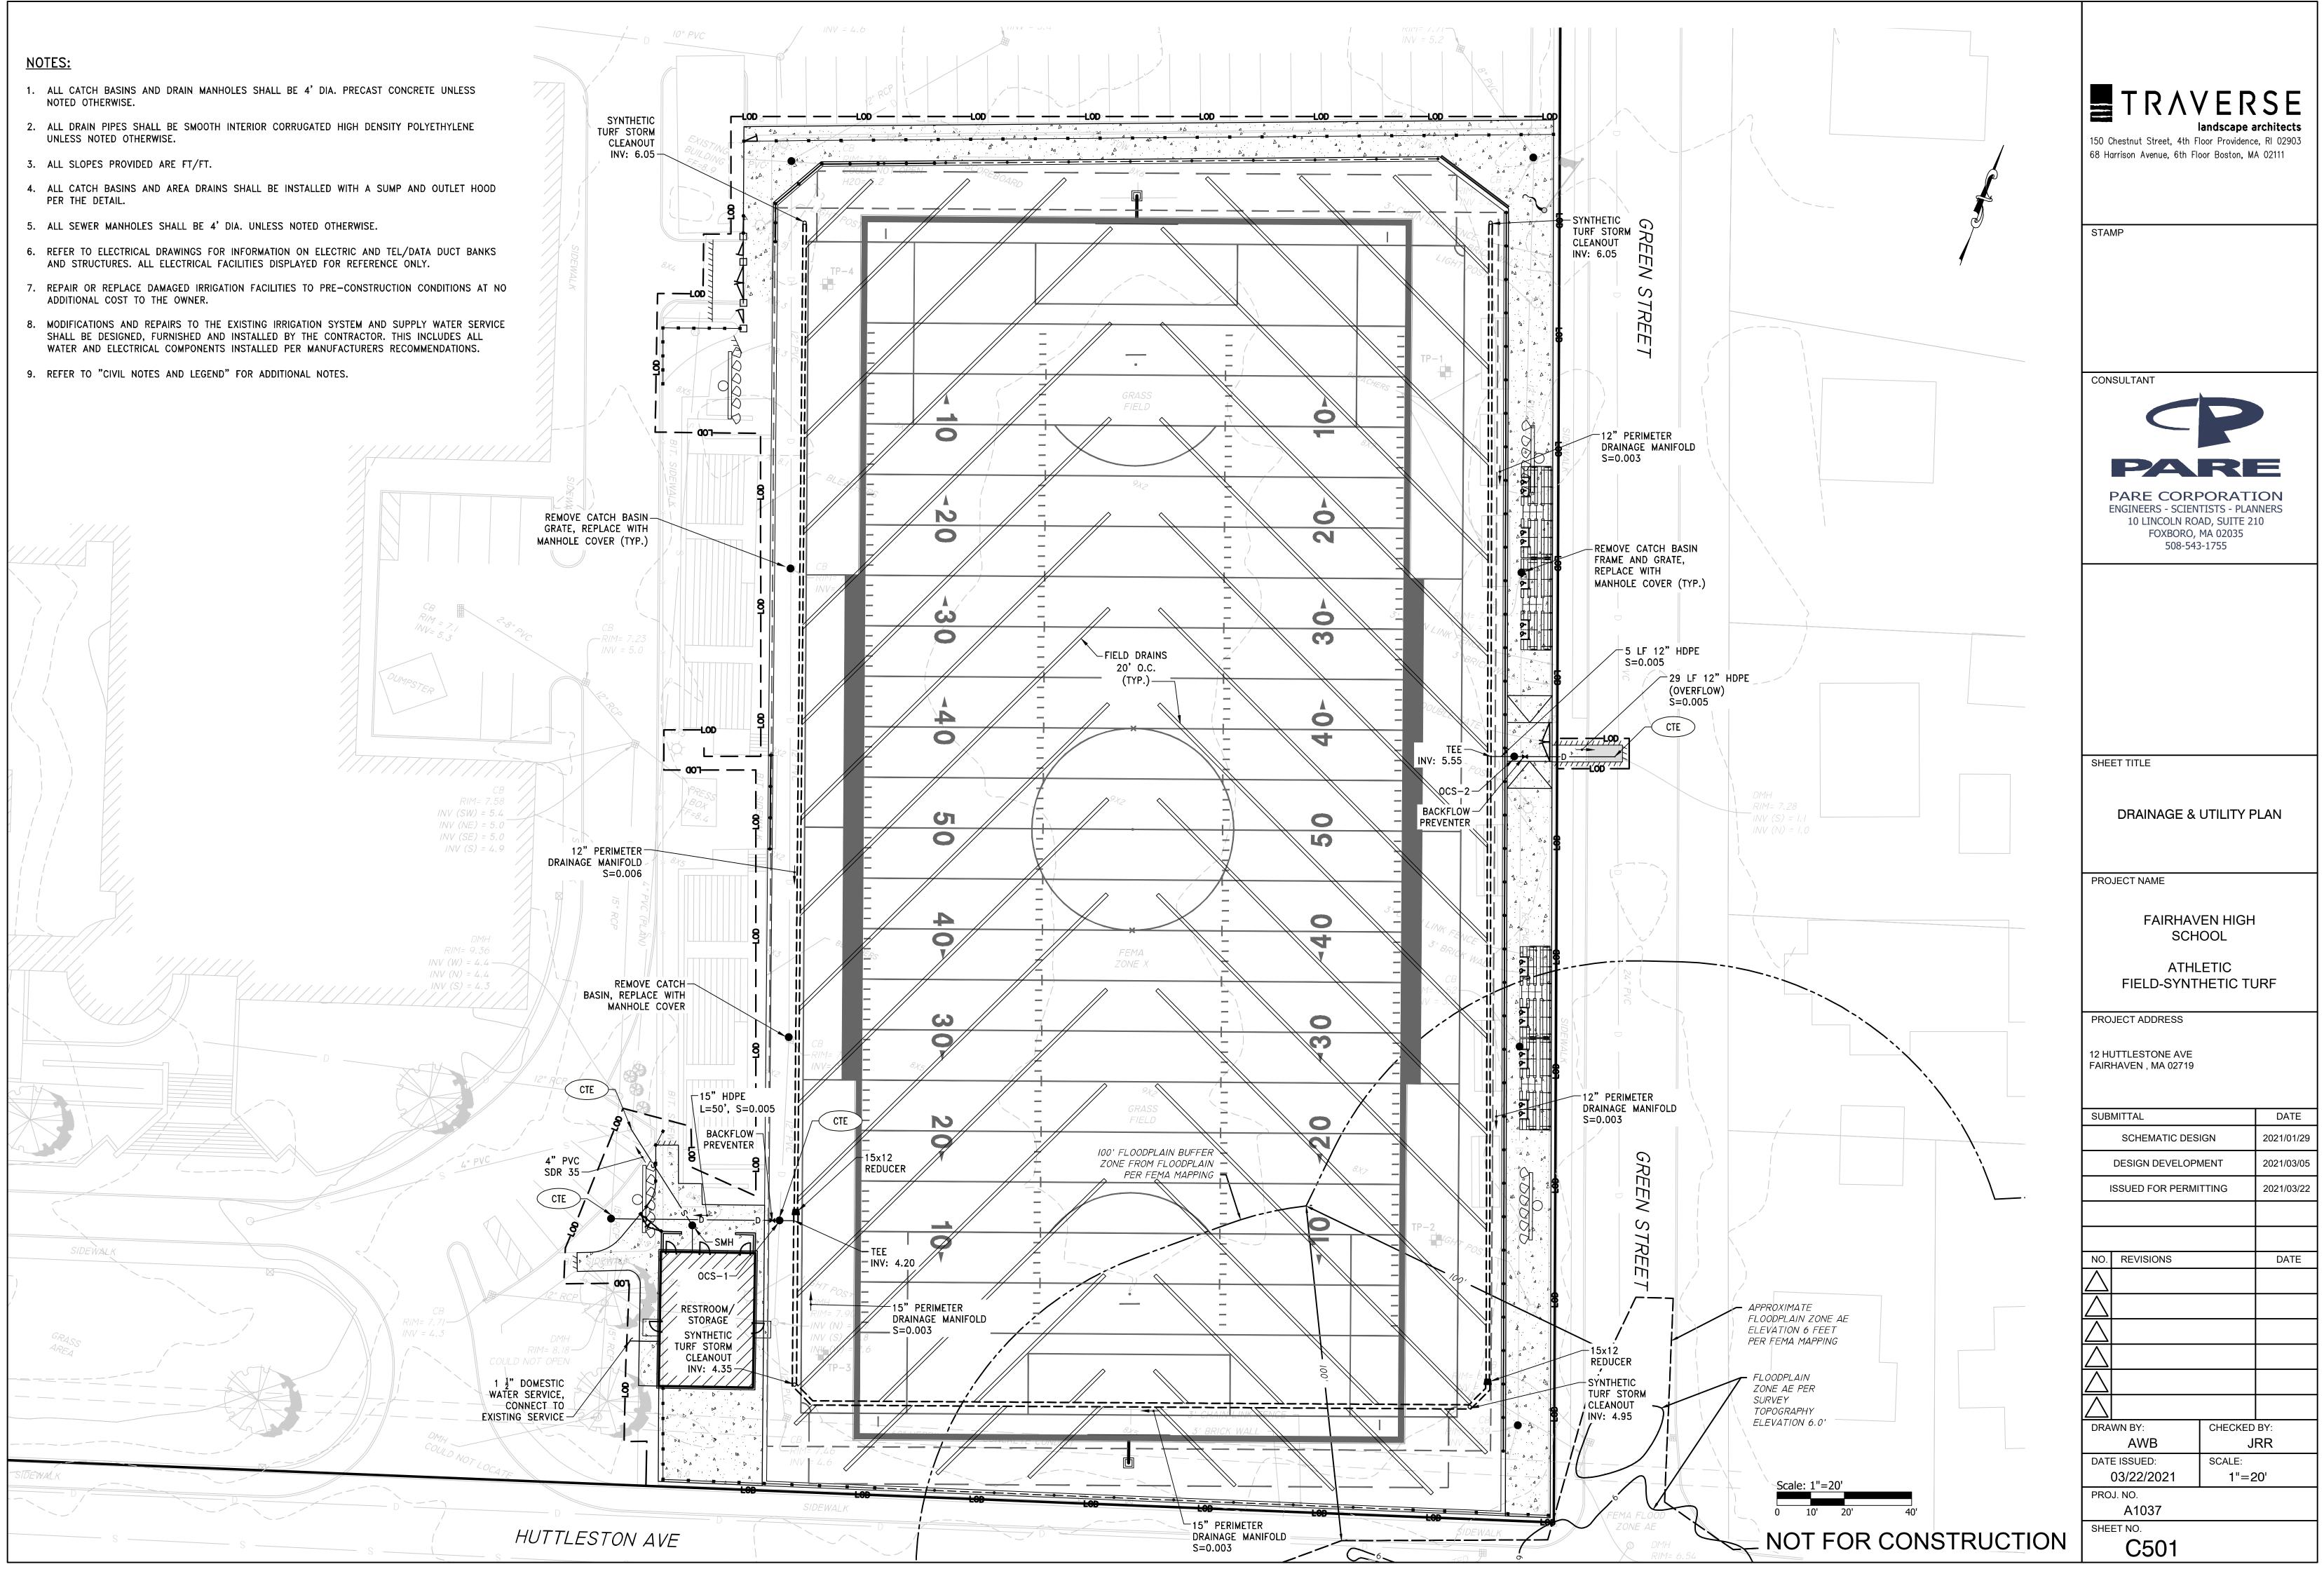


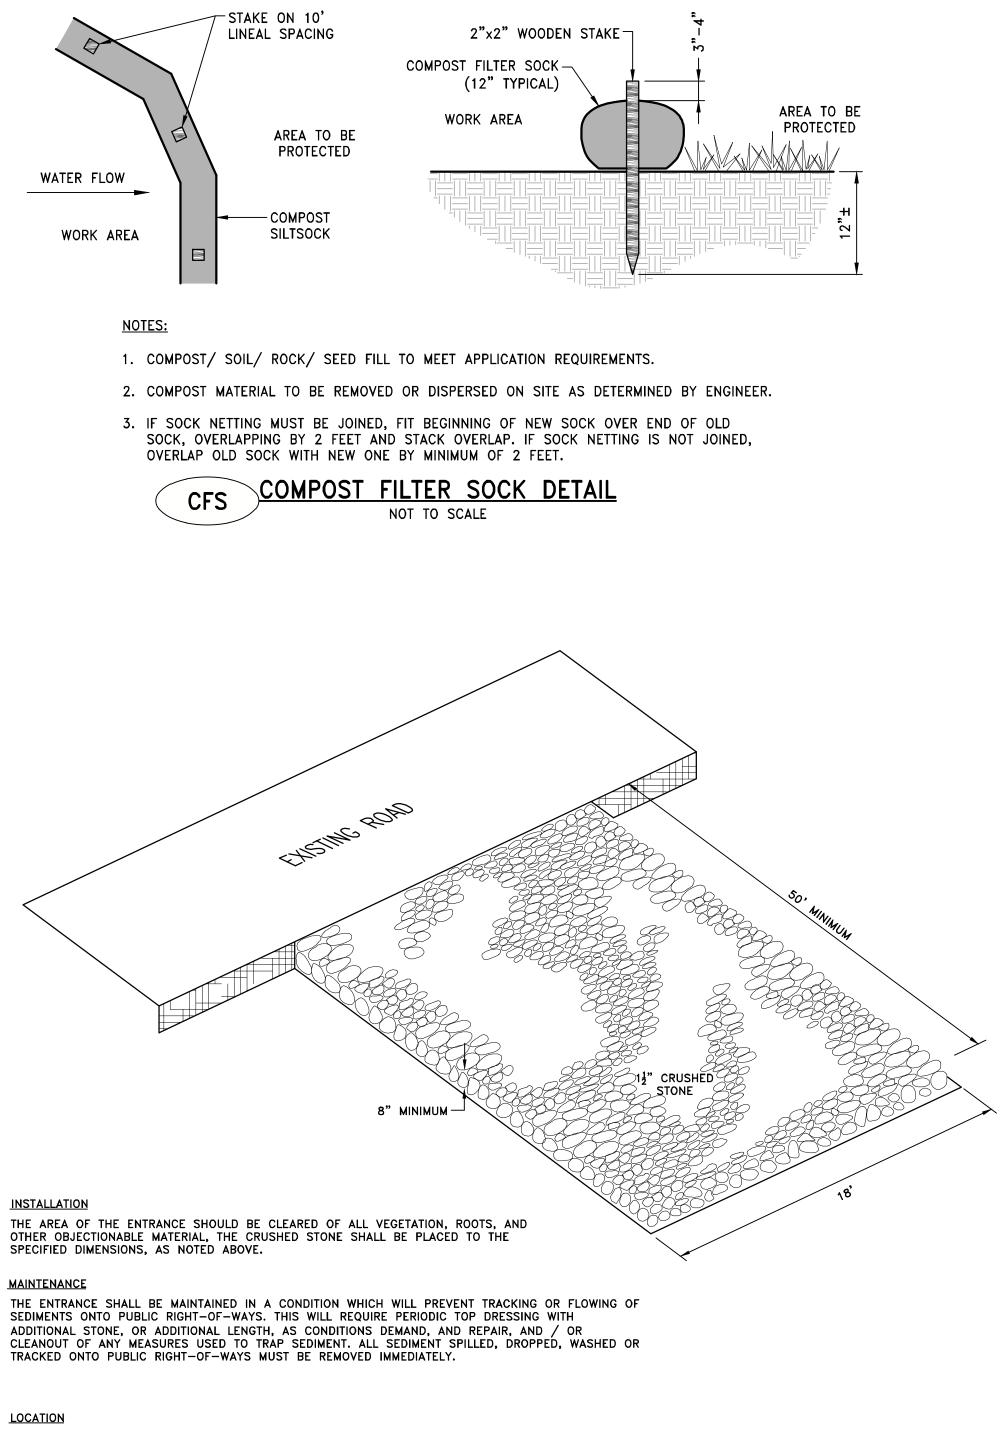

SEE PROJECT PLANS FOR LOCATION OF CONSTRUCTION ENTRANCE.

CONSTRUCTION ENTRANCE PROTECTION STONE STABILIZATION PAD NOT TO SCALE

> CHECKMATE ULTRAFLEX INLINE CHECK VALVE OR APPROVED EQUIVALENT (INSTALL PER MANUFACTURERS RECCOMENDATIONS) -

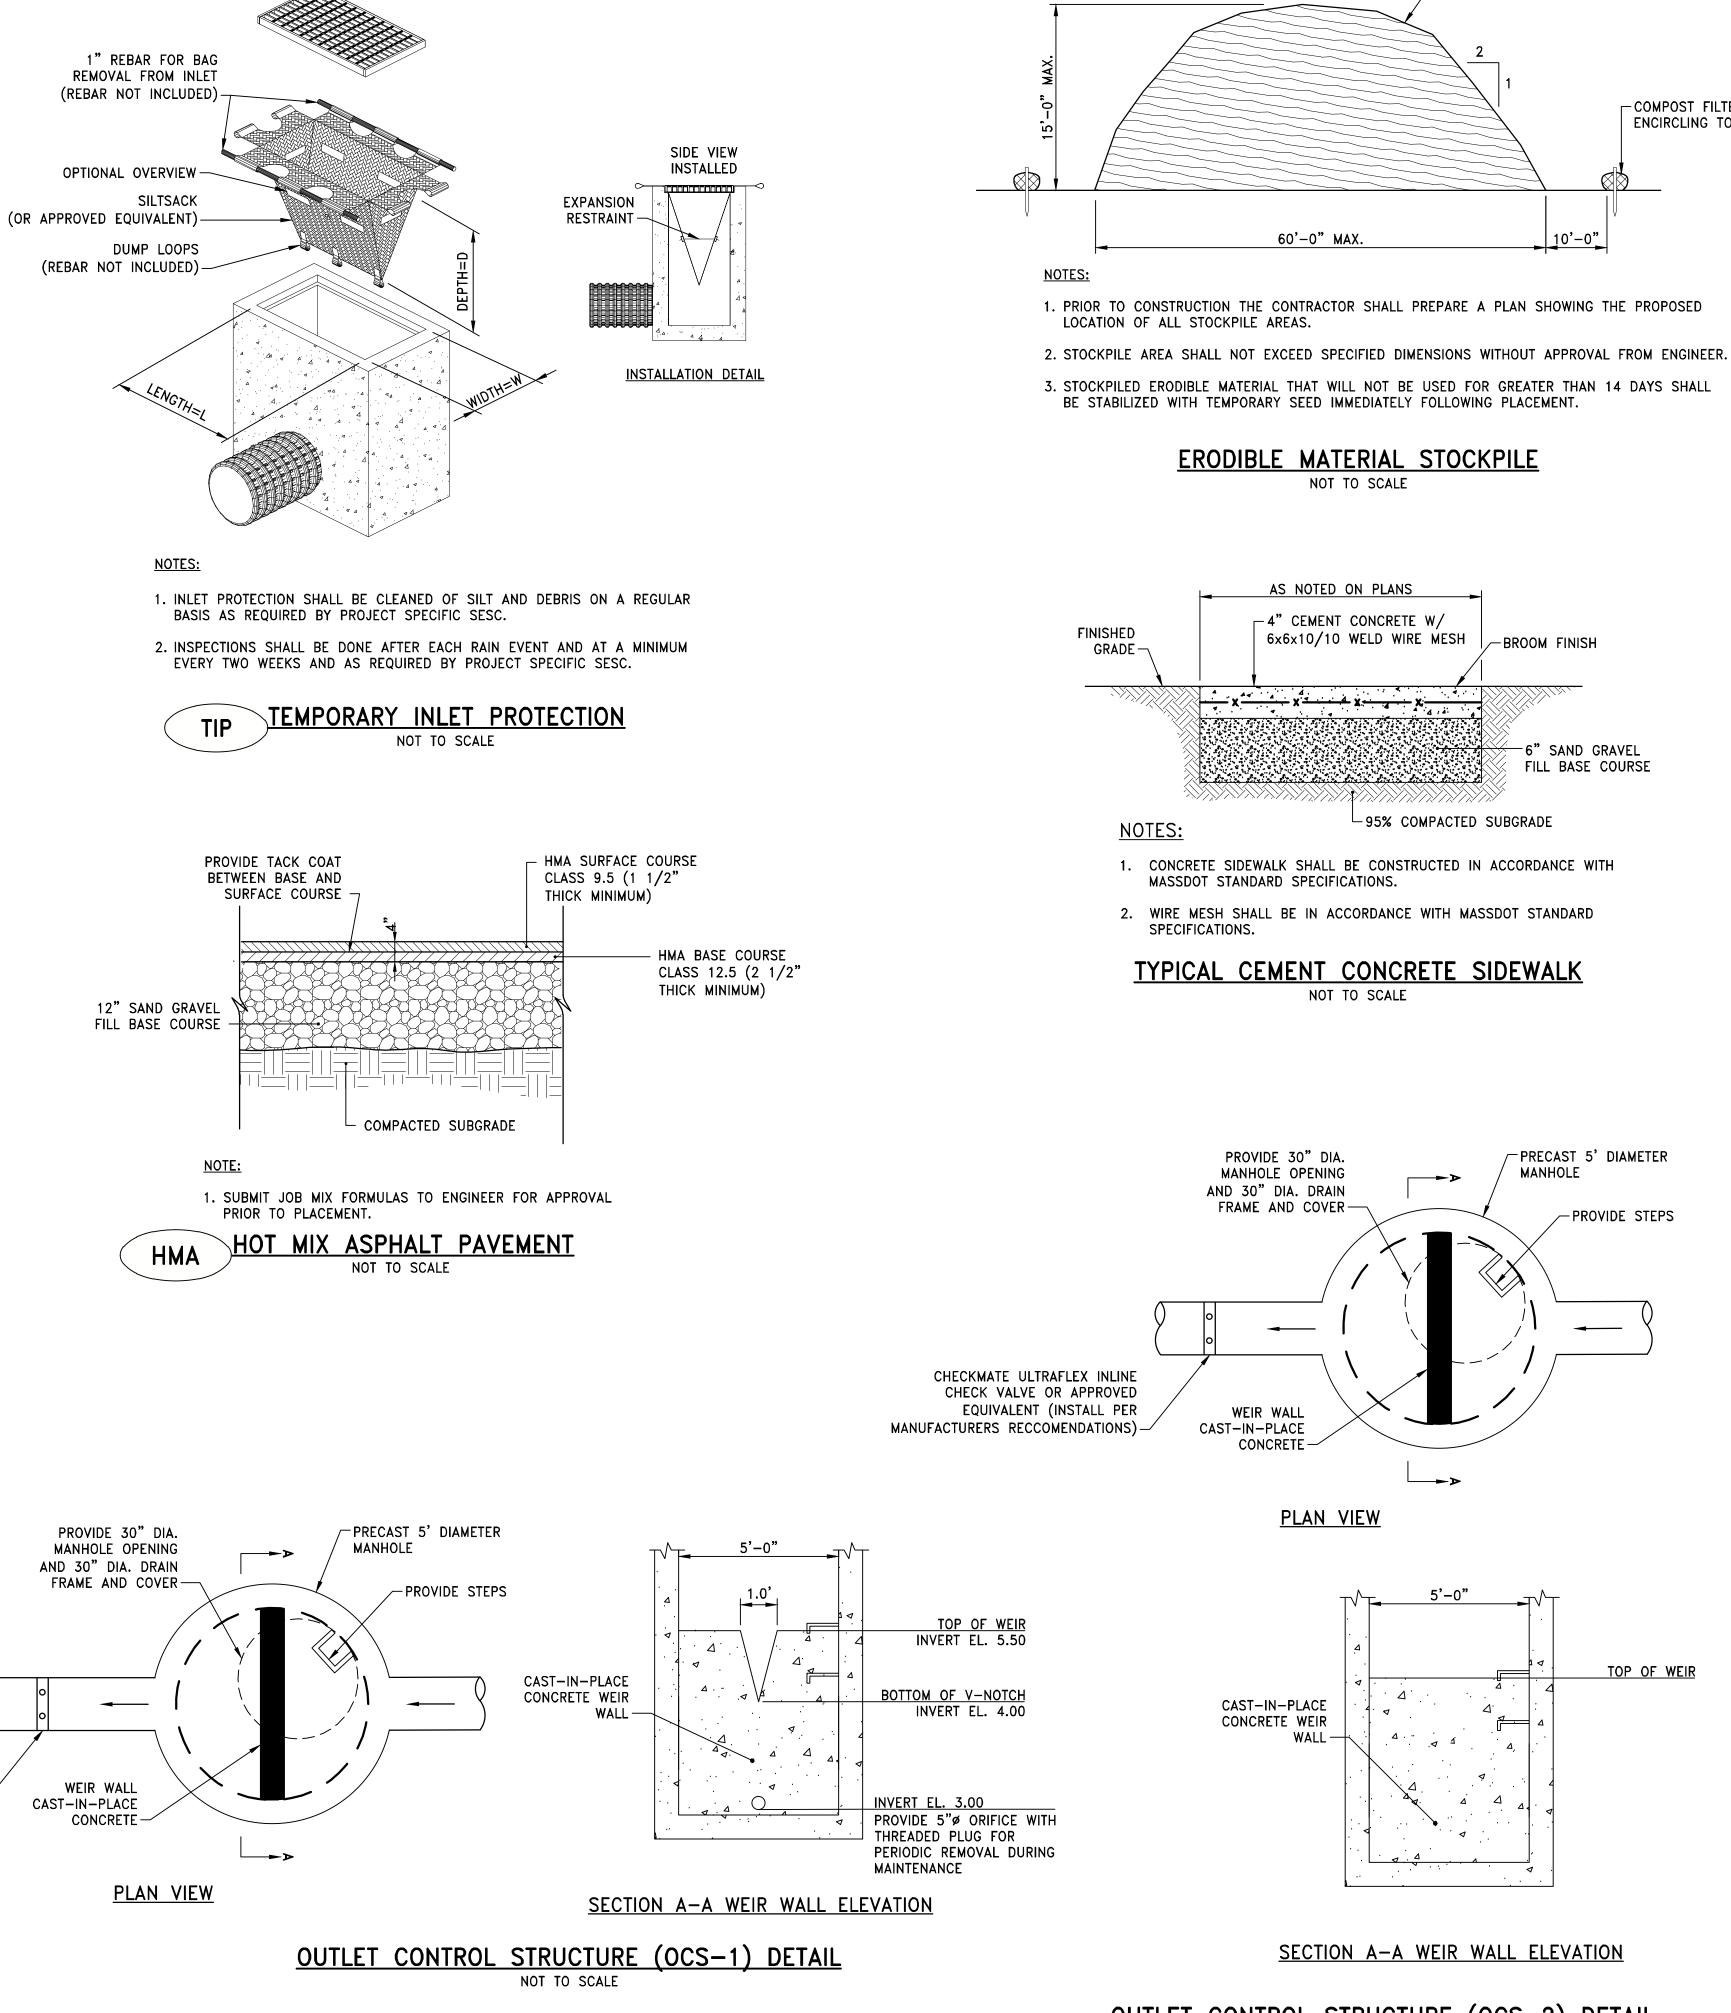

TOP OF WEIR

# NOT TO SCALE



### OUTLET CONTROL STRUCT DETAIL

| <u>URE</u> | <u>(0CS-2)</u> | <u> </u> |
|------------|----------------|----------|

- PROVIDE TEMPORARY SEED (SEE NOTE 3)

10'-0"

-BROOM FINISH

6" SAND GRAVEL

└ 95% COMPACTED SUBGRADE

\_\_**►**>

┝──⋗⋗

5'-0"

FILL BASE COURSE

-PRECAST 5' DIAMETER

- PROVIDE STEPS

MANHOLE

60'-0" MAX.

NOT TO SCALE

AS NOTED ON PLANS

-4" CEMENT CONCRETE W/

6x6x10/10 WELD WIRE MESH

NOT TO SCALE


-

<u>PLAN VIEW</u>

WALL -

COMPOST FILTER SOCK ENCIRCLING TOE

|  | <b>Iscape architects</b><br>Providence, RI 02903<br>Boston, MA 02111 |
|--|--|
| STAMP  |  |
|  |  |
| CONSULTANT   |  |
|  |  |
|  | RE   |
| ENGINEERS - SCIENTIST<br>10 LINCOLN ROAD,<br>FOXBORO, MA<br>508-543-17 | TS - PLANNERS<br>SUITE 210<br>02035                                  |
|  |  |
|  |  |
|  |  |
| SHEET TITLE  |  |
| CIVIL DETA   | JI S 1   |
|  |  |
| PROJECT NAME   |  |
| FAIRHAVEN<br>SCHOC   |  |
| ATHLET<br>FIELD-SYNTHE   |  |
| PROJECT ADDRESS  |  |
| 12 HUTTLESTONE AVE<br>FAIRHAVEN , MA 02719                             |  |
|  | DATE   |
| SUBMITTAL  | 2021/01/29   |
| SCHEMATIC DESIGN   | T 2021/02/05   |
|  |  |
| SCHEMATIC DESIGN<br>DESIGN DEVELOPMEN                                  |  |
| SCHEMATIC DESIGN<br>DESIGN DEVELOPMEN<br>ISSUED FOR PERMITTIN          | IG 2021/03/22  |
| SCHEMATIC DESIGN<br>DESIGN DEVELOPMEN<br>ISSUED FOR PERMITTIN          | NG 2021/03/22  |
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| SCHEMATIC DESIGN<br>DESIGN DEVELOPMEN<br>ISSUED FOR PERMITTIN          | NG 2021/03/22<br>DATE  |

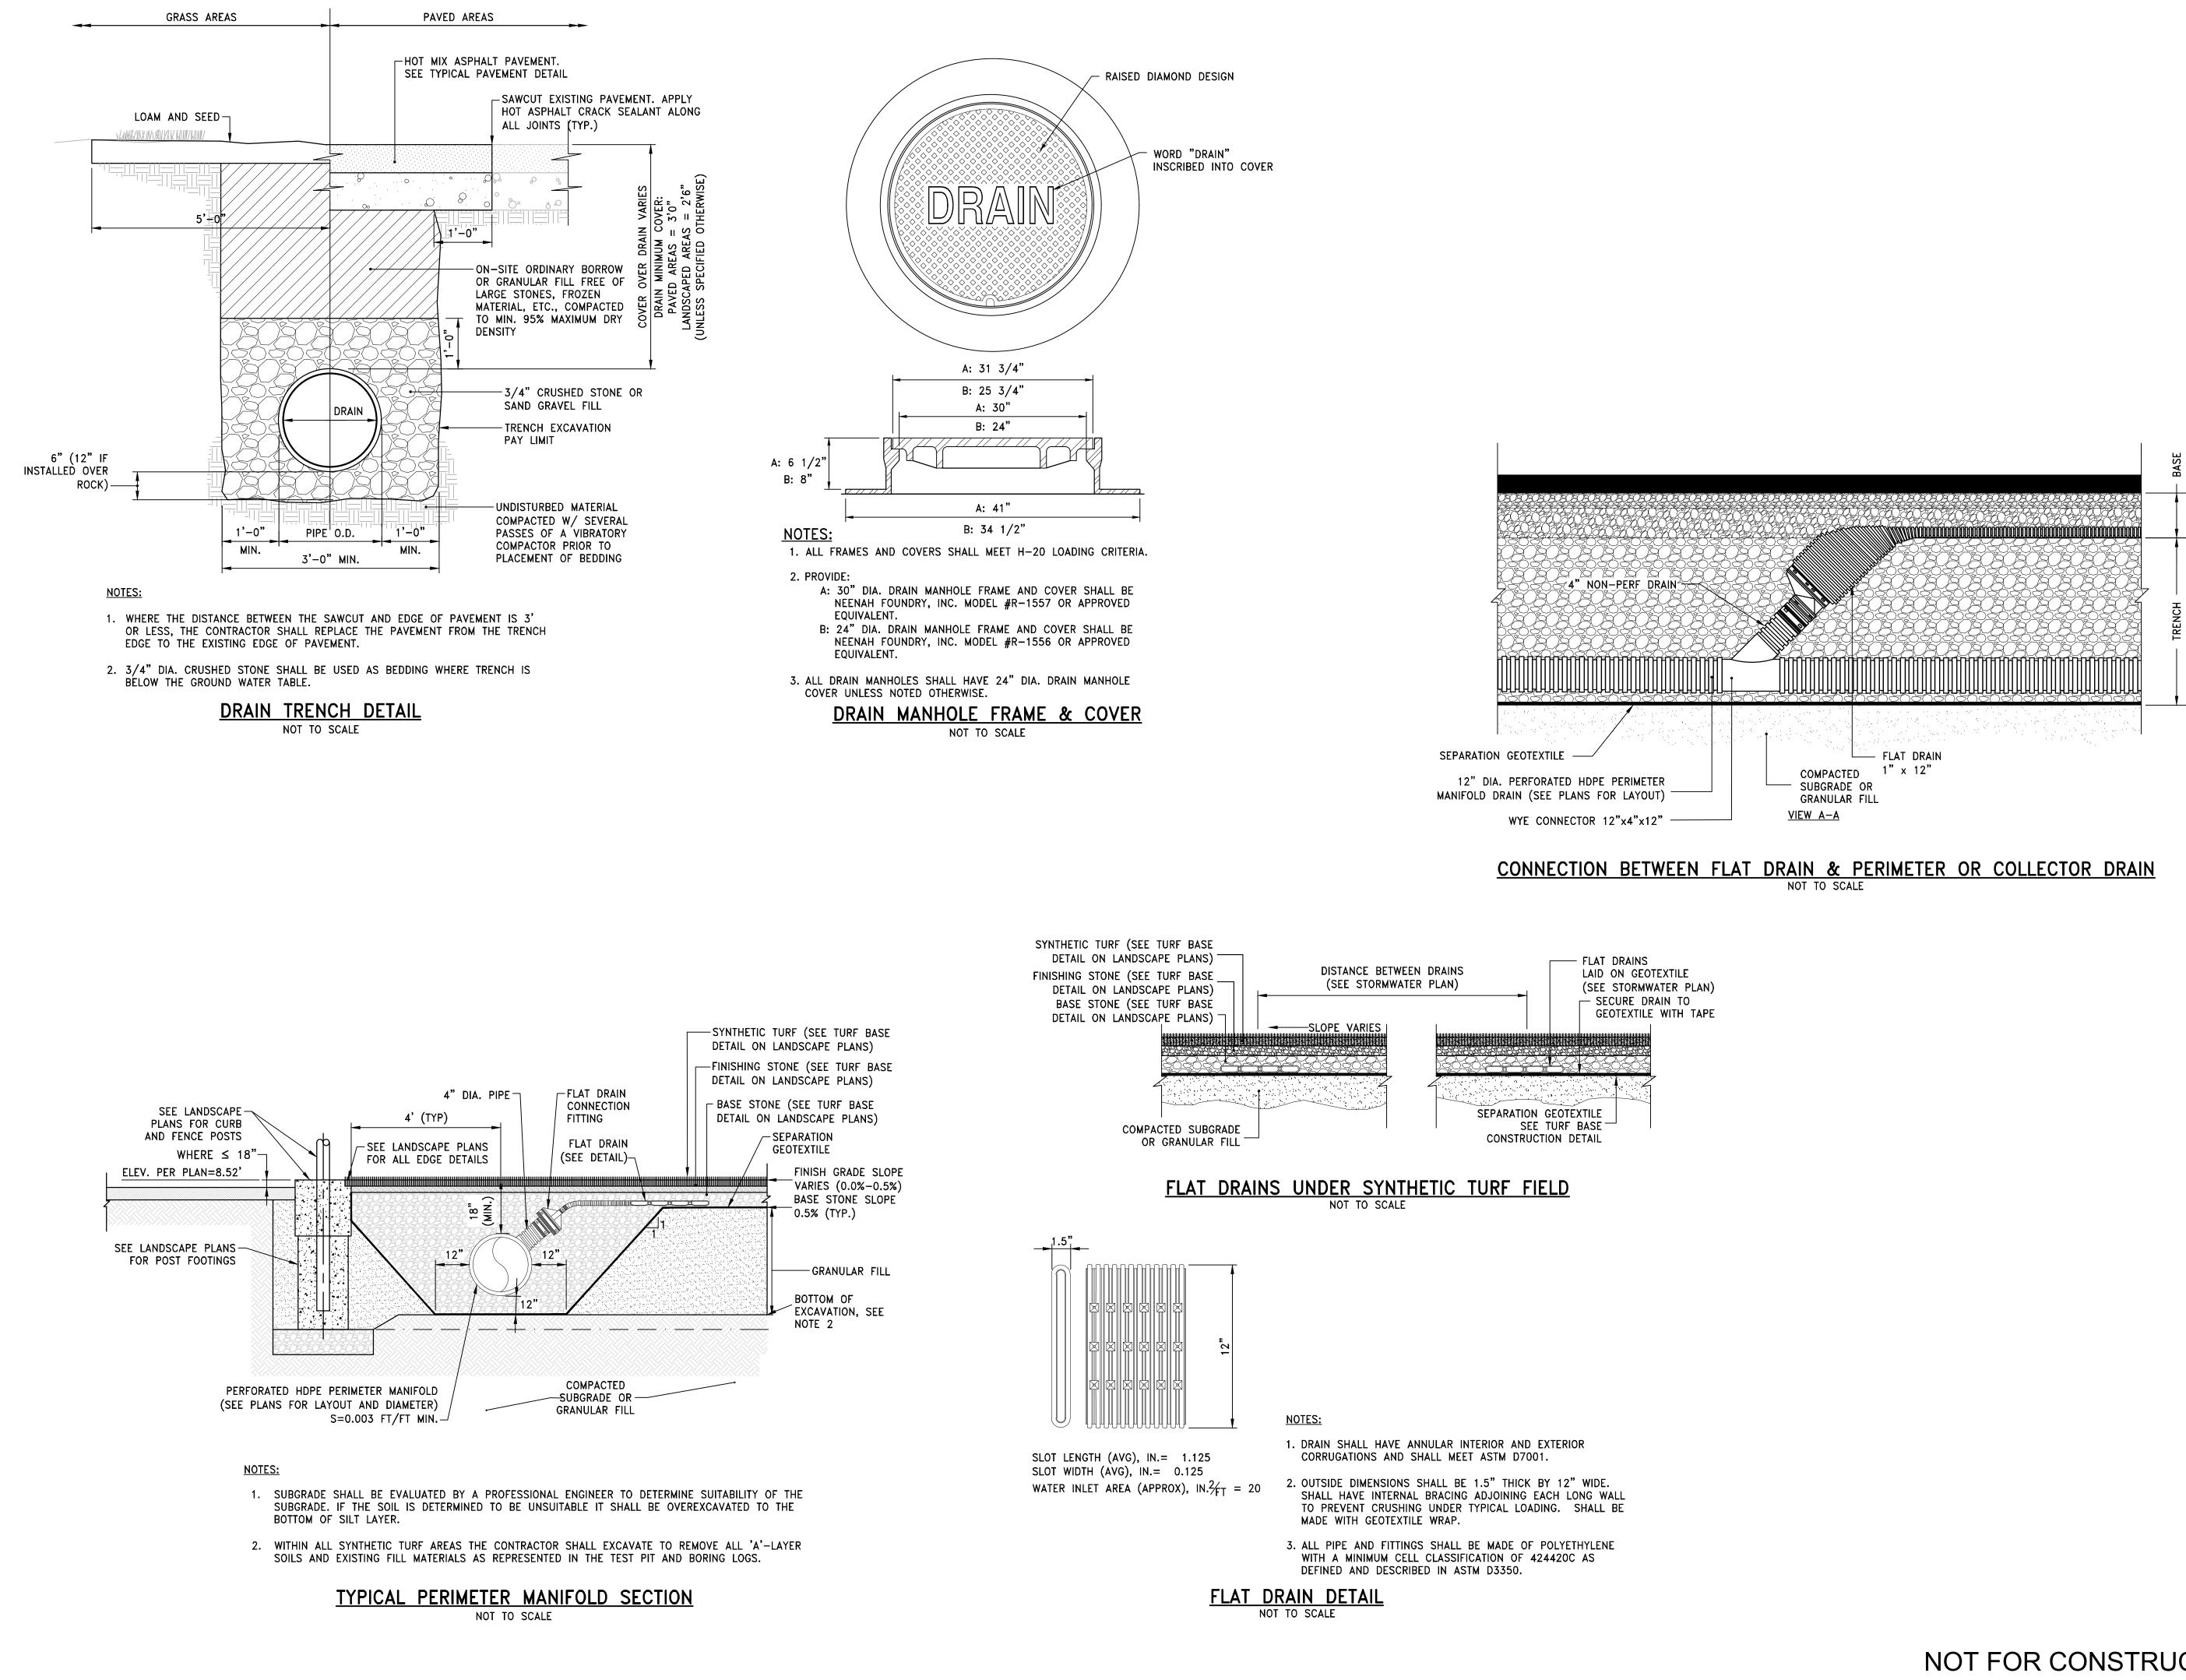

| TRAN<br>150 Chestnut Street, 4th Fl<br>68 Harrison Avenue, 6th Fla  | andscape a                               | e, RI 02903              |  |
|---|--|--------------------------|--|
| STAMP   |  |                          |  |
| CONSULTANT  | TISTS - PLAN<br>AD, SUITE 21<br>MA 02035 | INERS                    |  |
| SHEET TITLE   |  |                          |  |
| CIVIL DETAILS 2   |  |                          |  |
| PROJECT NAME<br>FAIRHAV<br>SCH  | 'EN HIGH<br>OOL                          |                          |  |
| ATHL<br>FIELD-SYNT  |  | JRF                      |  |
| PROJECT ADDRESS<br>12 HUTTLESTONE AVE<br>FAIRHAVEN , MA 02719   |  |                          |  |
| SUBMITTAL   |  | DATE                     |  |
| SCHEMATIC DESIGN  |  | 2021/01/29               |  |
| ISSUED FOR PERMI  |  | 2021/03/05<br>2021/03/22 |  |
|   |  |                          |  |
| NO. REVISIONS   |  | DATE                     |  |
| $\square$   |  |                          |  |
|   |  |                          |  |
| $ \Delta $  |  |                          |  |
| $ \land \qquad $ |  |                          |  |
| $\overline{\bigtriangleup}$   |  |                          |  |
| DRAWN BY:<br>AWB  | CHECKED                                  | BY:<br>RR                |  |
| DATE ISSUED:<br>03/22/2021  | SCALE:<br>N.T.                           |                          |  |
| PROJ. NO.   |  |                          |  |
| A1037<br>SHEET NO.  |  |                          |  |
| C602  |  |                          |  |

# NOT FOR CONSTRUCTION

# **GENERAL INFORMATION**

- SITE SAFETY AND PEDESTRIAN SAFETY IS OF EXTREME IMPORTANCE. THE CONTRACTOR SHALL BE RESPONSIBLE FOR EXECUTING THE WORK IN A SAFE MANNER AND WILL BE EXPECTED TO WORK OFF HOURS AS REQUIRED TO ACCOMMODATE CAMPUS ACTIVITIES WHILE MAINTAINING THE PROJECT SCHEDULE.
- 2. CONTRACTOR TO COORDINATE WITH PUBLIC SAFETY AND PARKING THROUGH THE CONSTRUCTION MANAGER.
- 3. THE CONTRACTOR IS SOLELY RESPONSIBLE FOR COMPLIANCE WITH ALL OSHA **REGULATIONS. COMPLIANCE IS MANDATORY**
- 4. SITE FENCING SHALL BE ERECTED BY THE CONTRACTOR AND APPROVED BY THE OWNER PRIOR TO THE COMMENCEMENT OF WORK.
- 5. VEHICULAR TRAFFIC OR PARKING OF CONSTRUCTION VEHICLES UNDER THE DRIP LINES (IN OR OUT OF THE CONSTRUCTION LIMITS) OF TREES IS STRICTLY PROHIBITED AND VEHICLES MAY BE TOWED.
- 6. UNFORESEEN CONDITIONS ARE INHERENT TO UNDERGROUND WORK AND ARE TO BE EXPECTED WITH THIS PROJECT. THE CONTRACTOR WILL RESPOND TO UNFORESEEN CONDITIONS AND PROVIDE THE NEEDED MANPOWER AND EQUIPMENT NECESSARY TO COMPLETE THE PROJECT BY THE CONTRACT COMPLETION DATE.
- 7. STAKING SHALL BE PROVIDED AND PAID FOR BY THE CONTRACTOR. STAKING TO BE PERFORMED BY LICENSED LAND SURVEYOR.
- 8. SITE CLEAN-UP SHALL BE PERFORMED ON A DAILY BASIS. SIDEWALKS. PARKING LOTS, ROADWAYS, ETC. SHALL BE KEPT CLEAN AT ALL TIMES.
- 9. ANY WORK REQUIRED TO COMPLETE THE SCOPE OF THIS PROJECT BUT NOT SET FORTH AS A SPECIFIC BID ITEM, SHALL BE CONSIDERED INCIDENTAL TO THE PROJECT. NO ADDITIONAL COMPENSATION SHALL BE ALLOWED FOR THE COMPLETION OF THIS WORK.
- 10. REPAIR OR REPLACE EXISTING FACILITIES (CURBS, PAVEMENT, UTILITIES, ETC.) TO REMAIN, AT NO ADDITIONAL EXPENSE TO THE OWNER.
- 11. IT IS INTENDED THAT ALL COSTS OF MATERIALS, EQUIPMENT, TOOLS, LABOR AND INCIDENTALS BE PAID FOR UNDER THE ITEMS LISTED ON THE BIDDER'S PROPOSAL. BEFORE SUBMITTING A BID ON THIS PROJECT, THE CONTRACTOR SHALL EXAMINE ALL DRAWINGS, SPECIFICATIONS, SPECIAL PROVISIONS AND

## **EXISTING CONDITIONS NOTES**

- 1. UTILITY INFORMATION SHOWN IS BASED ON UTILITY LOCATES BY THE OPERATING AUTHORITY OF EACH UTILITY, SURFACE FEATURES, AND RECORD DRAWINGS, NO SUBSURFACE INVESTIGATION HAS BEEN MADE. IT IS THE CONTRACTOR'S RESPONSIBILITY TO DETERMINE THE EXACT LOCATION OF UNDERGROUND UTILITIES. CALL DIG SAFE 811 FOR UTILITY LOCATES PRIOR TO CONSTRUCTION.
- 2. ALL NEW CONSTRUCTION THAT IS IN CLOSE PROXIMITY TO EXISTING OR NEW UTILITIES SHALL BE PLANNED AND EXECUTED CAREFULLY SO THAT UTILITIES ARE NOT DAMAGED. CONTRACTOR SHALL PHYSICALLY VERIFY THE LOCATION OF ALL UTILITIES PRIOR TO COMMENCING WORK.

### STAKING CONTROL POINTS

CP NORTHING EASTING ELEVATION

## STAKING/LAYOUT NOTES

- 1. ALL STAKING CONTROL POINTS SHALL BE PROTECTED THROUGHOUT THE PROJECT
- 2. STAKING AND LAYOUT FOR THIS PROJECT IS THE RESPONSIBILITY OF THE CONTRACTOR.
- COORDINATES WILL BE PROVIDED FOR THE WORK SHOWN ON 3. THE LANDSCAPE LAYOUT SHEETS. ELECTRONIC AUTOCAD FILES WILL BE PROVIDED AND IT IS THE CONTRACTOR'S RESPONSIBILITY TO PROVIDE STAKING AND LAYOUT BASED ON ELECTRONIC DRAWING DATA.
- 4. UNLESS OTHERWISE APPROVED, IT IS EXPECTED THAT UTILITY ELEVATIONS ARE CAREFULLY OBTAINED FROM THE PLANS, AND THAT UTILITIES WILL BE INSTALLED AS CLOSE TO PRECISE PROFILE ELEVATIONS AS CONSTRUCTION METHODS WILL REASONABLY ALLOW.

THE JOB SITE. IF ANY DISCREPANCIES OR DELETIONS OCCUR IN THE CONTRACT DOCUMENTS, THE CONTRACTOR SHALL REPORT SAME TO THE OWNERS REPRESENTATIVE IN WRITING AND OBTAIN WRITTEN CLARIFICATION AND/OR INSTRUCTIONS ON HOW TO PROCEED.

- 12. WORK WHICH DOES NOT CONFORM TO THE REQUIREMENTS OF THE OWNERS REPRESENTATIVE OR LANDSCAPE ARCHITECT AT THE DONE WITHOUT AUTHORITY WILL NOT BE PAID FOR.
- 13. CONTRACTOR SHALL REVIEW ALL DRAWINGS AND SPECIFICATIONS TO WORK.
- THE PROPOSED IMPROVEMENTS SHOWN ON THE PLAN.

# LAYOUT NOTES:

- 1. ALL LINES ARE PERPENDICULAR OR F UNLESS OTHERWISE INDICATED.
- UNLESS OTHERWISE NOTED

# LAYOUT LEGEND:


CENTER LINE (TYPE)

NORTHING/EASTING LAYOUT COORDINATE CALLOUT

TYPICAL DIMENSION

RADII DIMENSION

PROPOSED ANGLE BETWEEN ELEMENTS

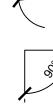

ABBREVIATIONS

N 711146.3001

E 2734339.8730

1'-0"

R4"

TEMPORARY

WATER MAIN

UNDERGROUND ELECTRIC

| CC      | ASPHALT                       | MJ                |
|---------|-------------------------------|-------------------|
| BAN     | ABANDONED                     | OE<br>PCC<br>PL   |
|         |                               | PVC<br>RCP        |
| IA      | DIAMETER<br>DUCTILE IRON PIPE | RE'D/REQ'D<br>RGS |
| W<br>O  | DOMESTIC WATER                | RJ<br>DIP         |
| W<br>PS | FIRE WATER                    | ROW               |
| Ē       | INVERT ELEVATION              | SMH<br>STM        |
|         |                               | STRM<br>TELU      |
| F       | LINEAR FEET                   | TEMP              |
| 1H      | MANHOLE                       | WAT/W             |

CONTRACT WILL BE CONSIDERED UNACCEPTABLE. UNACCEPTABLE WORK, WHETHER THE RESULT OF POOR WORKMANSHIP, USE OF DEFECTIVE MATERIALS, DAMAGE THROUGH CARELESSNESS OR ANY OTHER CAUSE FOUND TO EXIST PRIOR TO THE FINAL ACCEPTANCE OF THE WORK, SHALL BE REMOVED AND REPLACED IN AN ACCEPTABLE MANNER, AS REQUIRED BY THE CONTRACTOR'S EXPENSE. WORK DONE CONTRARY TO THE INSTRUCTIONS ,WORK DONE BEYOND THE LINES SHOWN ON THE PLANS OR ANY EXTRA WORK

DETERMINE THE TOTAL SCOPE OF WORK AND ALL REQUIRED COORDINATION PRIOR TO SUBMITTING THEIR BID PROPOSAL, AND PRIOR TO COMMENCING

14. THE LOCATIONS OF ALL KNOWN UNDERGROUND UTILITIES ARE NOTED ON THE DRAWINGS. THE CONTRACTOR IS SPECIFICALLY CAUTIONED THAT THE LOCATION AND/OR ELEVATION OF EXISTING UTILITIES AND STRUCTURES, AS SHOWN ON THESE PLANS, IS BASED ON RECORDS OF VARIOUS UTILITY COMPANIES AND, WHERE POSSIBLE, MEASUREMENTS TAKEN IN THE FIELD. THIS INFORMATION IS NOT TO BE RELIED ON AS BEING EXACT OR COMPLETE THE CONTRACTOR, PRIOR TO THE START OF CONSTRUCTION, SHALL VERIFY THE LOCATION OF ALL UNDERGROUND UTILITIES AND STRUCTURES IN THE FIELD.THE CONTRACTOR MUST CONTACT THE APPROPRIATE UTILITY COMPANY, ANY GOVERNING PERMITTING AUTHORITY, AND "DIG SAFE" AT LEAST 72 HOURSPRIOR TO ANY EXCAVATION WORK TO REQUEST THE EXACT FIELD LOCATION OF UTILITIES. THE LANDSCAPE ARCHITECT SHALL BE NOTIFIED, IN WRITING, OF ANY UTILITIES INTERFERING WITH THE PROPOSED CONSTRUCTION AND APPROPRIATE REMEDIAL ACTIONS TAKEN BEFORE PROCEEDING WITH THE WORK. IT SHALL BE THE RESPONSIBILITY OF THE CONTRACTOR TO RELOCATE ALL EXISTING UTILITIES WHICH CONFLICT WITH

| PARALLEL TO THE LINES FROM WHICH THEY ARE MEASURE | D |
|---|---|
|   |   |

DIMENSIONS OF PARKING SPACES AND DRIVEWAYS ARE FROM FACE OF CURB TO FACE OF CURB

ACCESSIBLE RAMPS SHALL BE PER THE AMERICANS WITH DISABILITIES ACT (ADA) ACCESSIBILITY AND MASSACHUSETTS ARCHITECTURAL ACCESS BOARD (MAAB) GUIDELINES AND INCLUDE DETECTABLE WARNING PLATES. SEE CIVIL ENGINEERING PLANS FOR ALL TIP DOWN GRADING AND LOCATIONS

4. AUTOCAD PLANS OR ADDITIONAL COORDINATES WILL BE PROVIDED AFTER THE AWARD OF THE BID.

SPOT GRADES ABBREVIATIONS MECHANICAL JOINT OVERHEAD ELECTRIC PORTLAND CEMENT CONCRETE PROPERTY LINE POLYVINYL CHLORIDE PIPE REINFORCED CONCRETE PIPE REQUIRED **RIGID STEEL RESTRAINED JOINT** DUCTILE IRON PIPE RIGHT-OF-WAY SANITARY SEWER SANITARY MANHOLE STEAM STORM SEWER TELECOMMUNICATIONS

> FINISHED FLOOR ELEVATION FFE 568.00 NUMBER OF RISERS + HEIGHT 17R@6" -

SYMBOL 2% -∕\\_► | FLOW ARROW -0-0-

LEGEND UTILTIES

|   | SFOT GIVADES | ADDINE | ATIONS                   |
|---|--------------|--------|--------------------------|
| E |              | FFE    | FINISHED FLOOR ELEVATION |
|   |              | тс     | TOP OF CURB              |
|   |              | TOW    | TOP OF WALK              |
|   |              | TW     | TOP OF WALL              |
|   |              | BW     | BOTTOM OF WALL           |
|   |              | TS     | TOP OF STEP              |
|   |              | BS     | BOTTOM OF STEP           |
|   |              | EOR    | END OF RADIUS            |
|   |              | HP     | HIGH POINT               |
|   |              | LP     | LOW POINT                |
|   |              | PT     | POINT OF TANGENCY        |

# LEGEND

SITE

- DESCRIPTION BOLLARD POLE
  - HANDICAPPED PARKING
  - SLOPE ARROW
  - SINGLE POLE SIGN
  - DOUBLE POLE SIGN

150 Chestnut Street, 4th Floor Providence, RI 02903

68 Harrison Avenue, 6th Floor Boston, MA 02111


STAMP

| EXISTING | DESCRIPTION                   |  |  |  |
|----------|-------------------------------|--|--|--|
|          | CABLE LINE - OVERHEAD         |  |  |  |
|          | CABLE LINE - UNDERGROUND      |  |  |  |
|          | ELECTRIC LINE - OVERHEAD      |  |  |  |
|          | ELECTRICAL LINE - UNDERGROUND |  |  |  |
|          | GAS MAIN                      |  |  |  |
| )        | SANITARY SEWER                |  |  |  |
|          | STEAM                         |  |  |  |
| >        | STORM SEWER                   |  |  |  |
|          |                               |  |  |  |
|          | OVERHEAD TELEPHONE            |  |  |  |
|          | FIBER OPTICS                  |  |  |  |
|          |                               |  |  |  |

UNDERGROUND TELEPHONE WATER MAIN

# LEGEND FENCE AND CURB

DESCRIPTION CHAIN LINK FENCE 4' ORNAMENTAL FENCE BALL SAFETY NETTING 12' BALL SAFETY NETTING 20' ORNAMENTAL FENCE AND NET COMBINATION TREE PROTECTION 14" CURB EXPOSED WITH PT NAILER 14" FIELD CURB

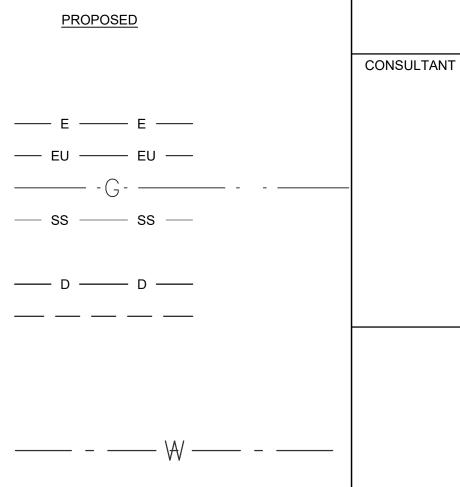

PROPOSED

| •        | • |  |
|----------|---|--|
|          |   |  |
| <u> </u> | X |  |
| ⋺        | Ф |  |
|          |   |  |
|          |   |  |

SHEET TITLE

## LEGEND SCHEDULE AND GENERAL NOTES

PROJECT NAME

FAIRHAVEN HIGH SCHOOL

ATHLETIC FIELD-SYNTHETIC TURF

PROJECT ADDRESS

**12 HUTTLESTONE AVE** FAIRHAVEN, MA 02719

# SUBMITTAL

| SCHEMATIC DESIGN   | 2021/01/29 |
|--------------------|------------|
| DESIGN DEVELOPMENT | 2021/03/0  |
| PERMITTING         | 2021/03/22 |

NO. REVISIONS

DATE

DATE


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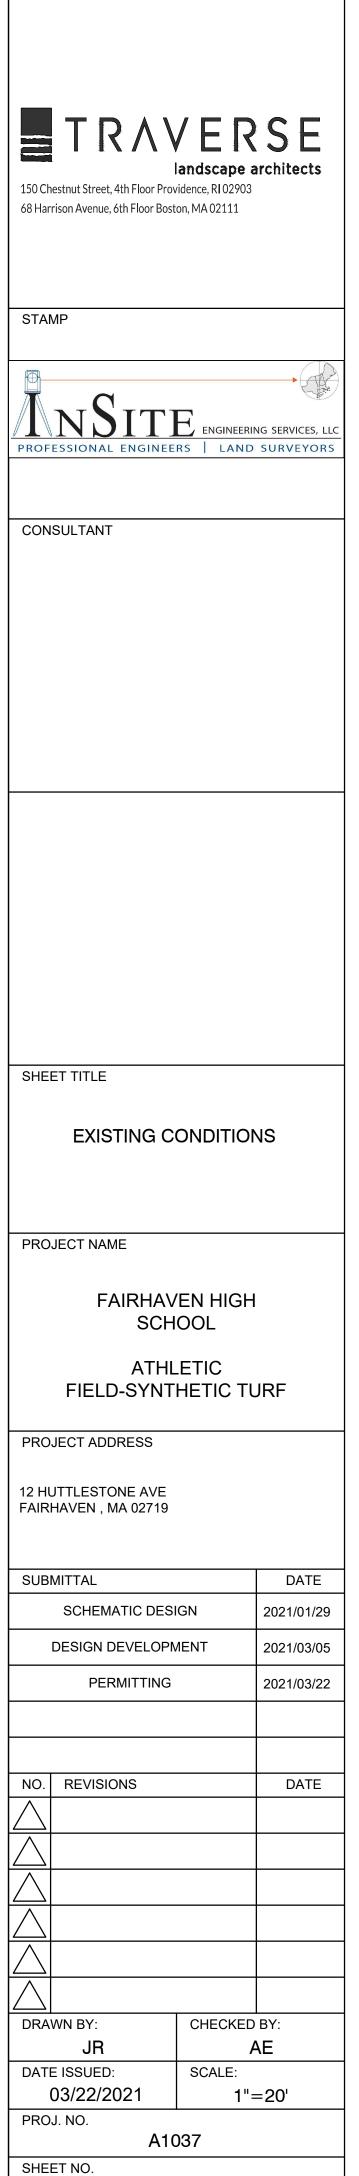
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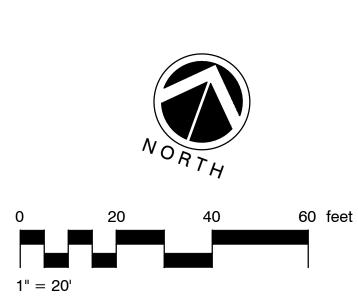
03/05/2021 PROJ. NO. A1037

SHEET NO.




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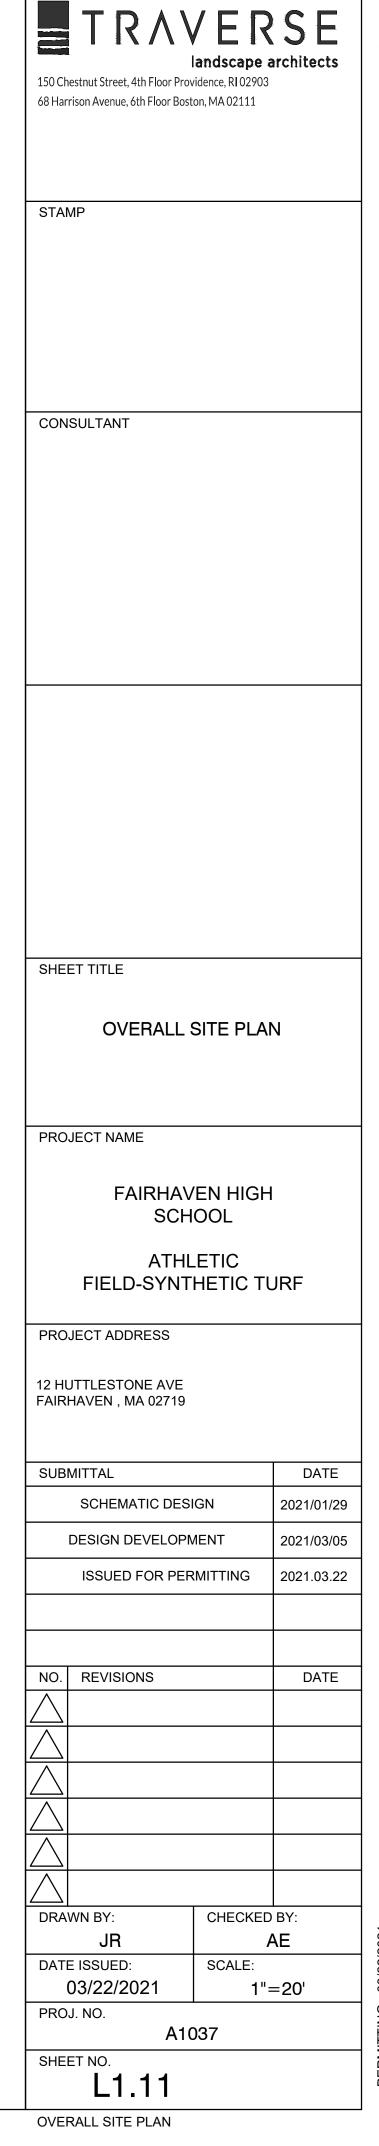


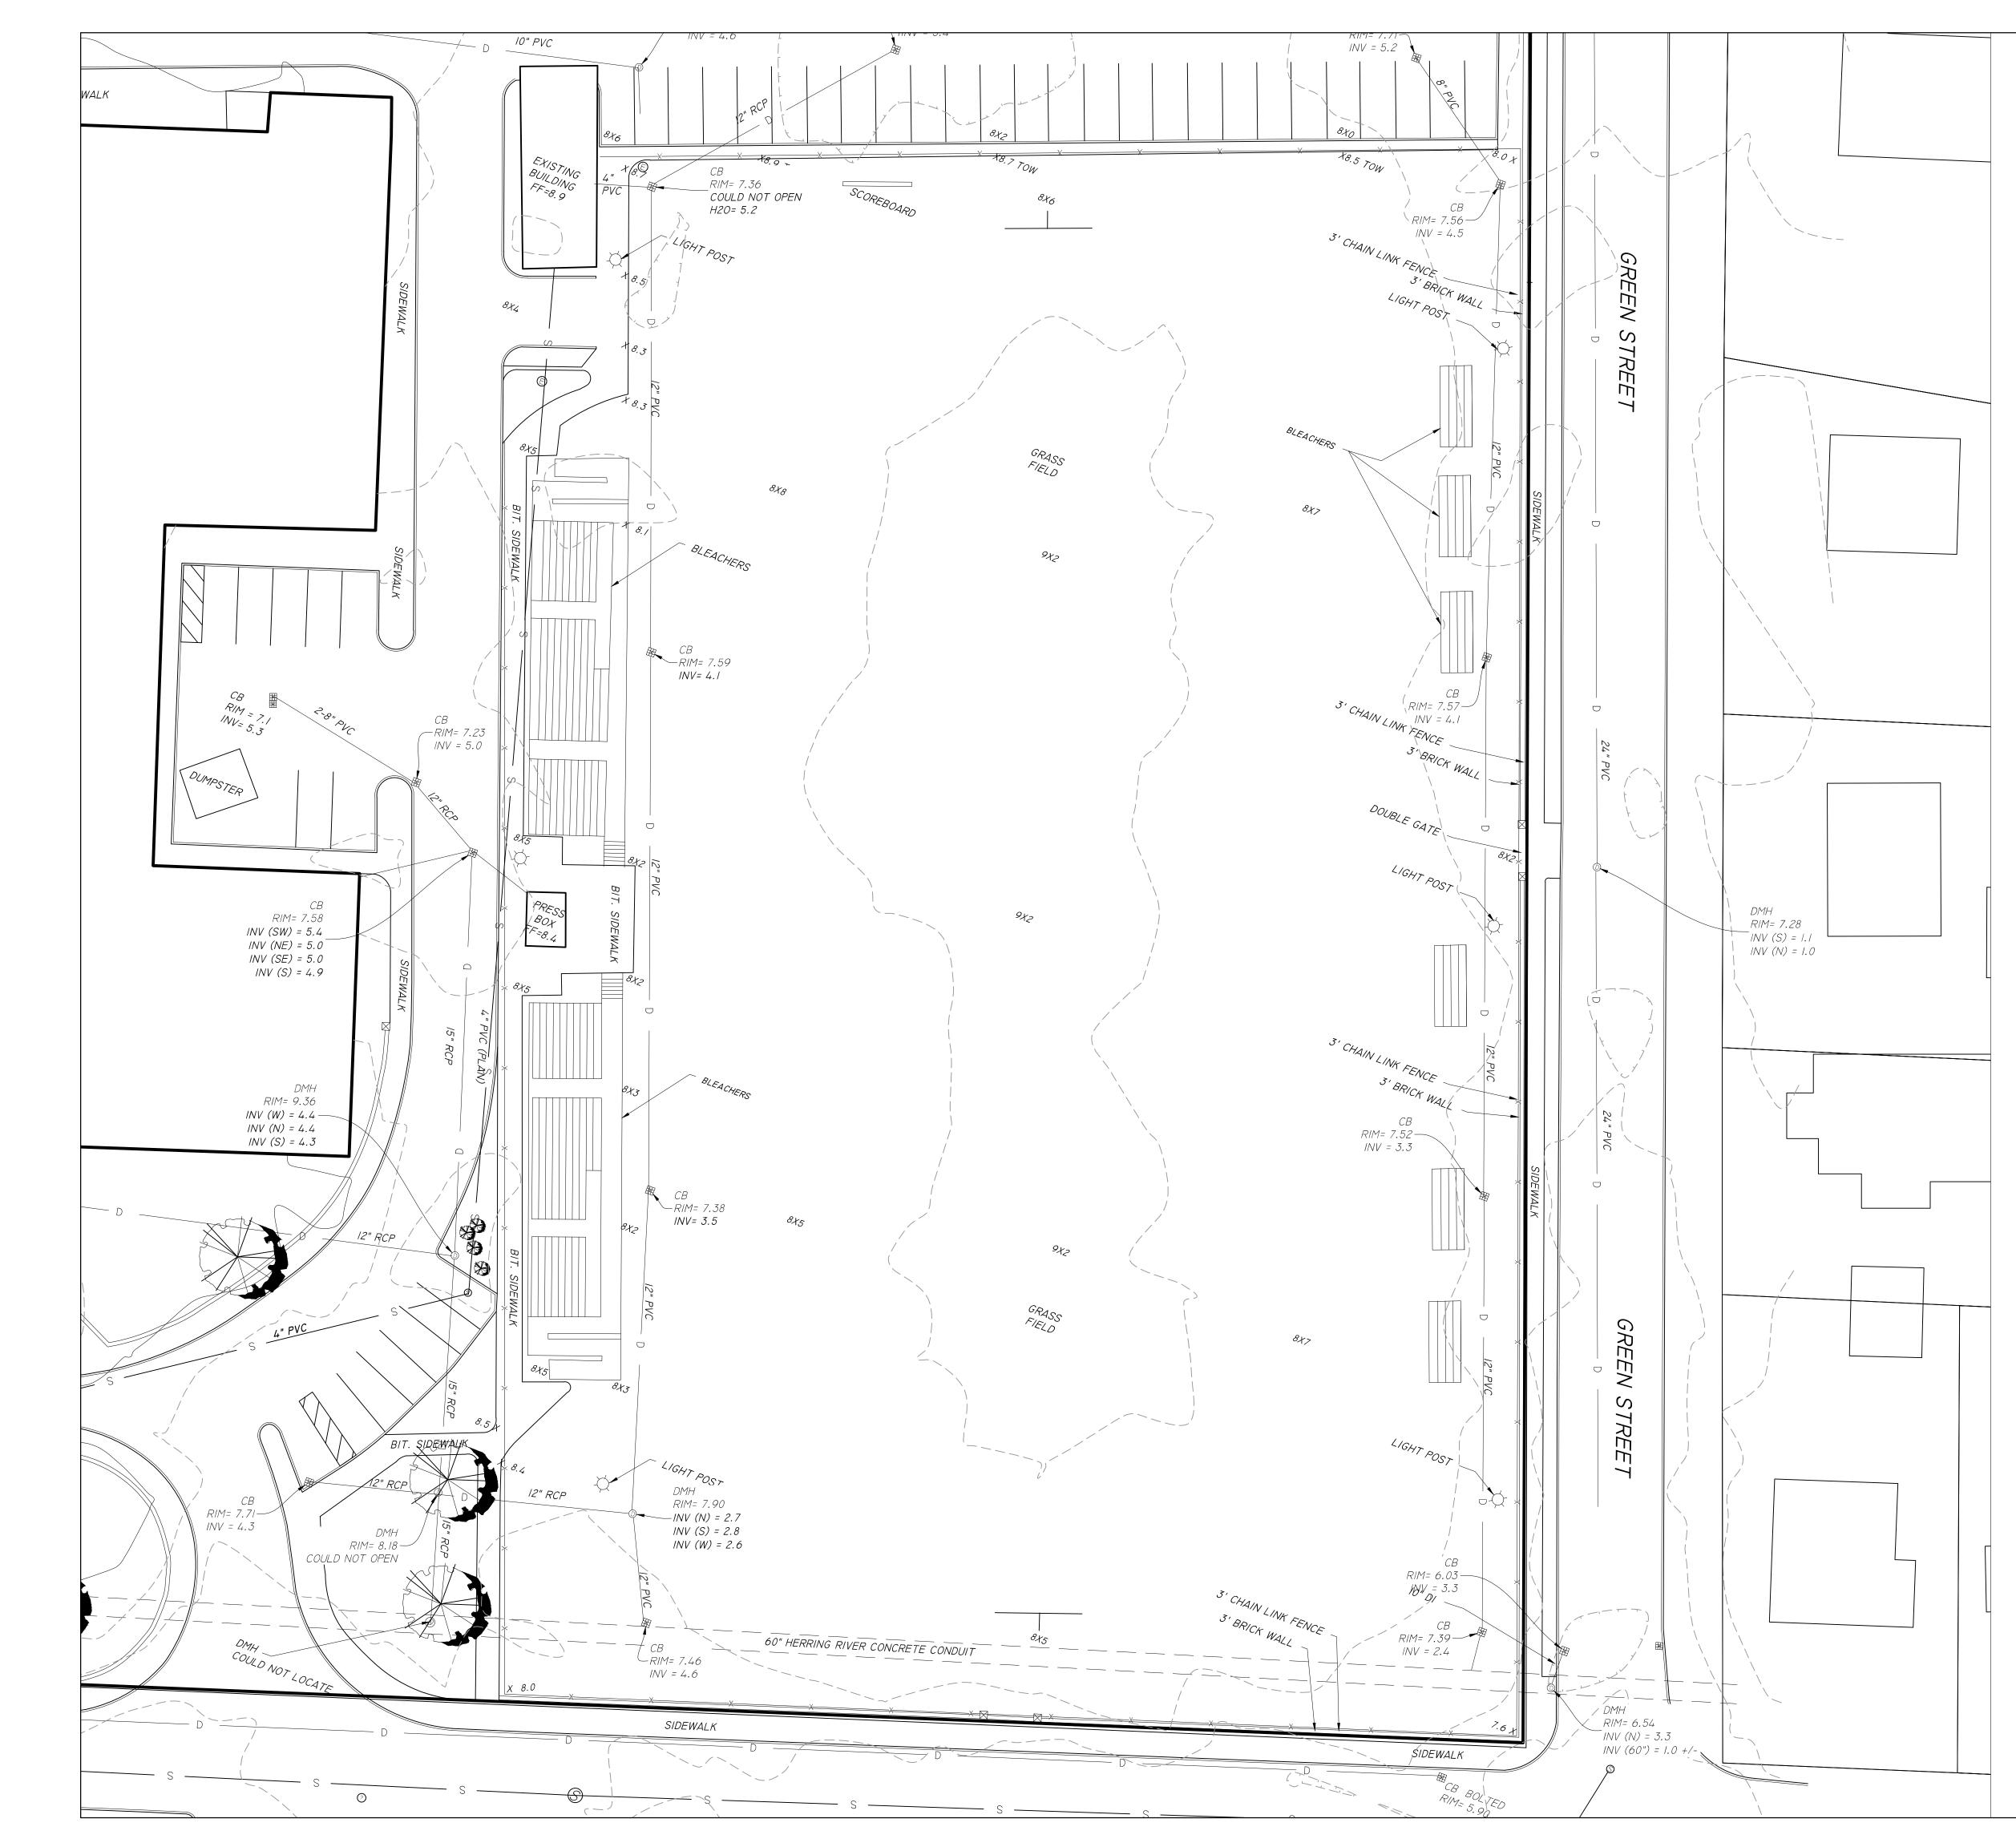



L1.01

EXISTING CONDITIONS



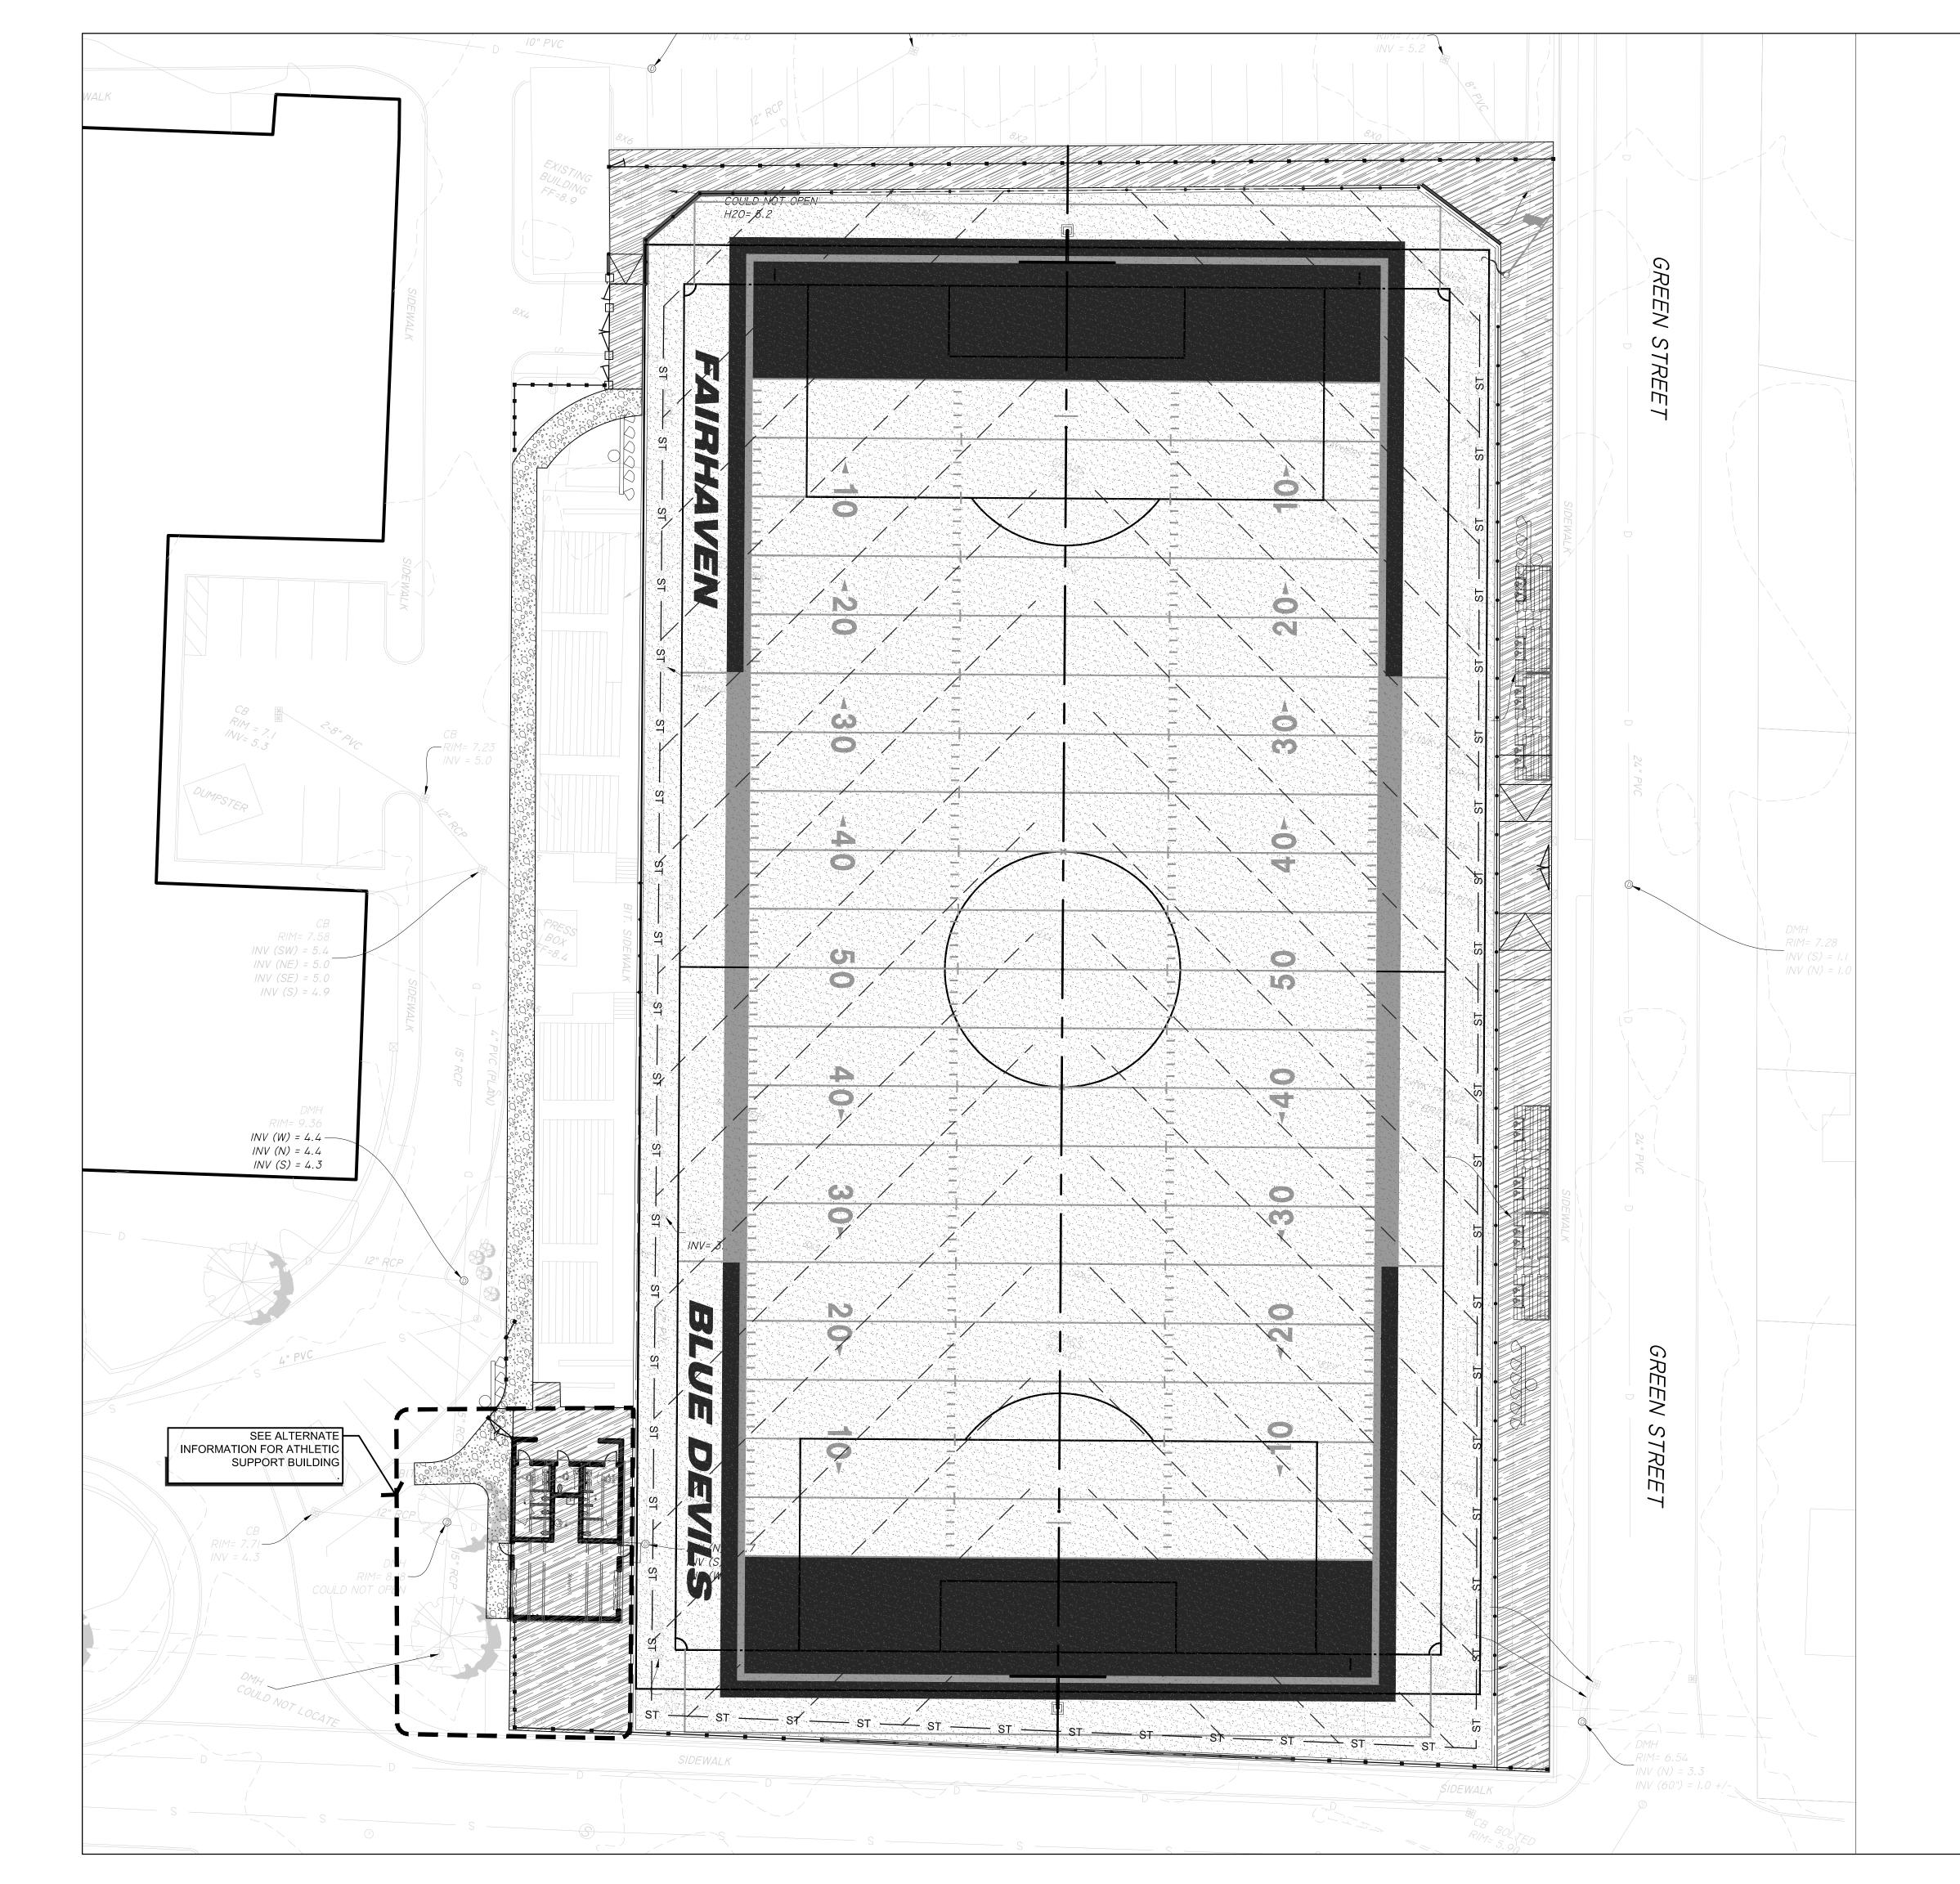

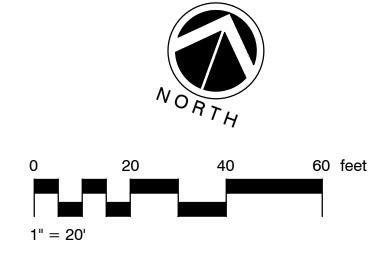

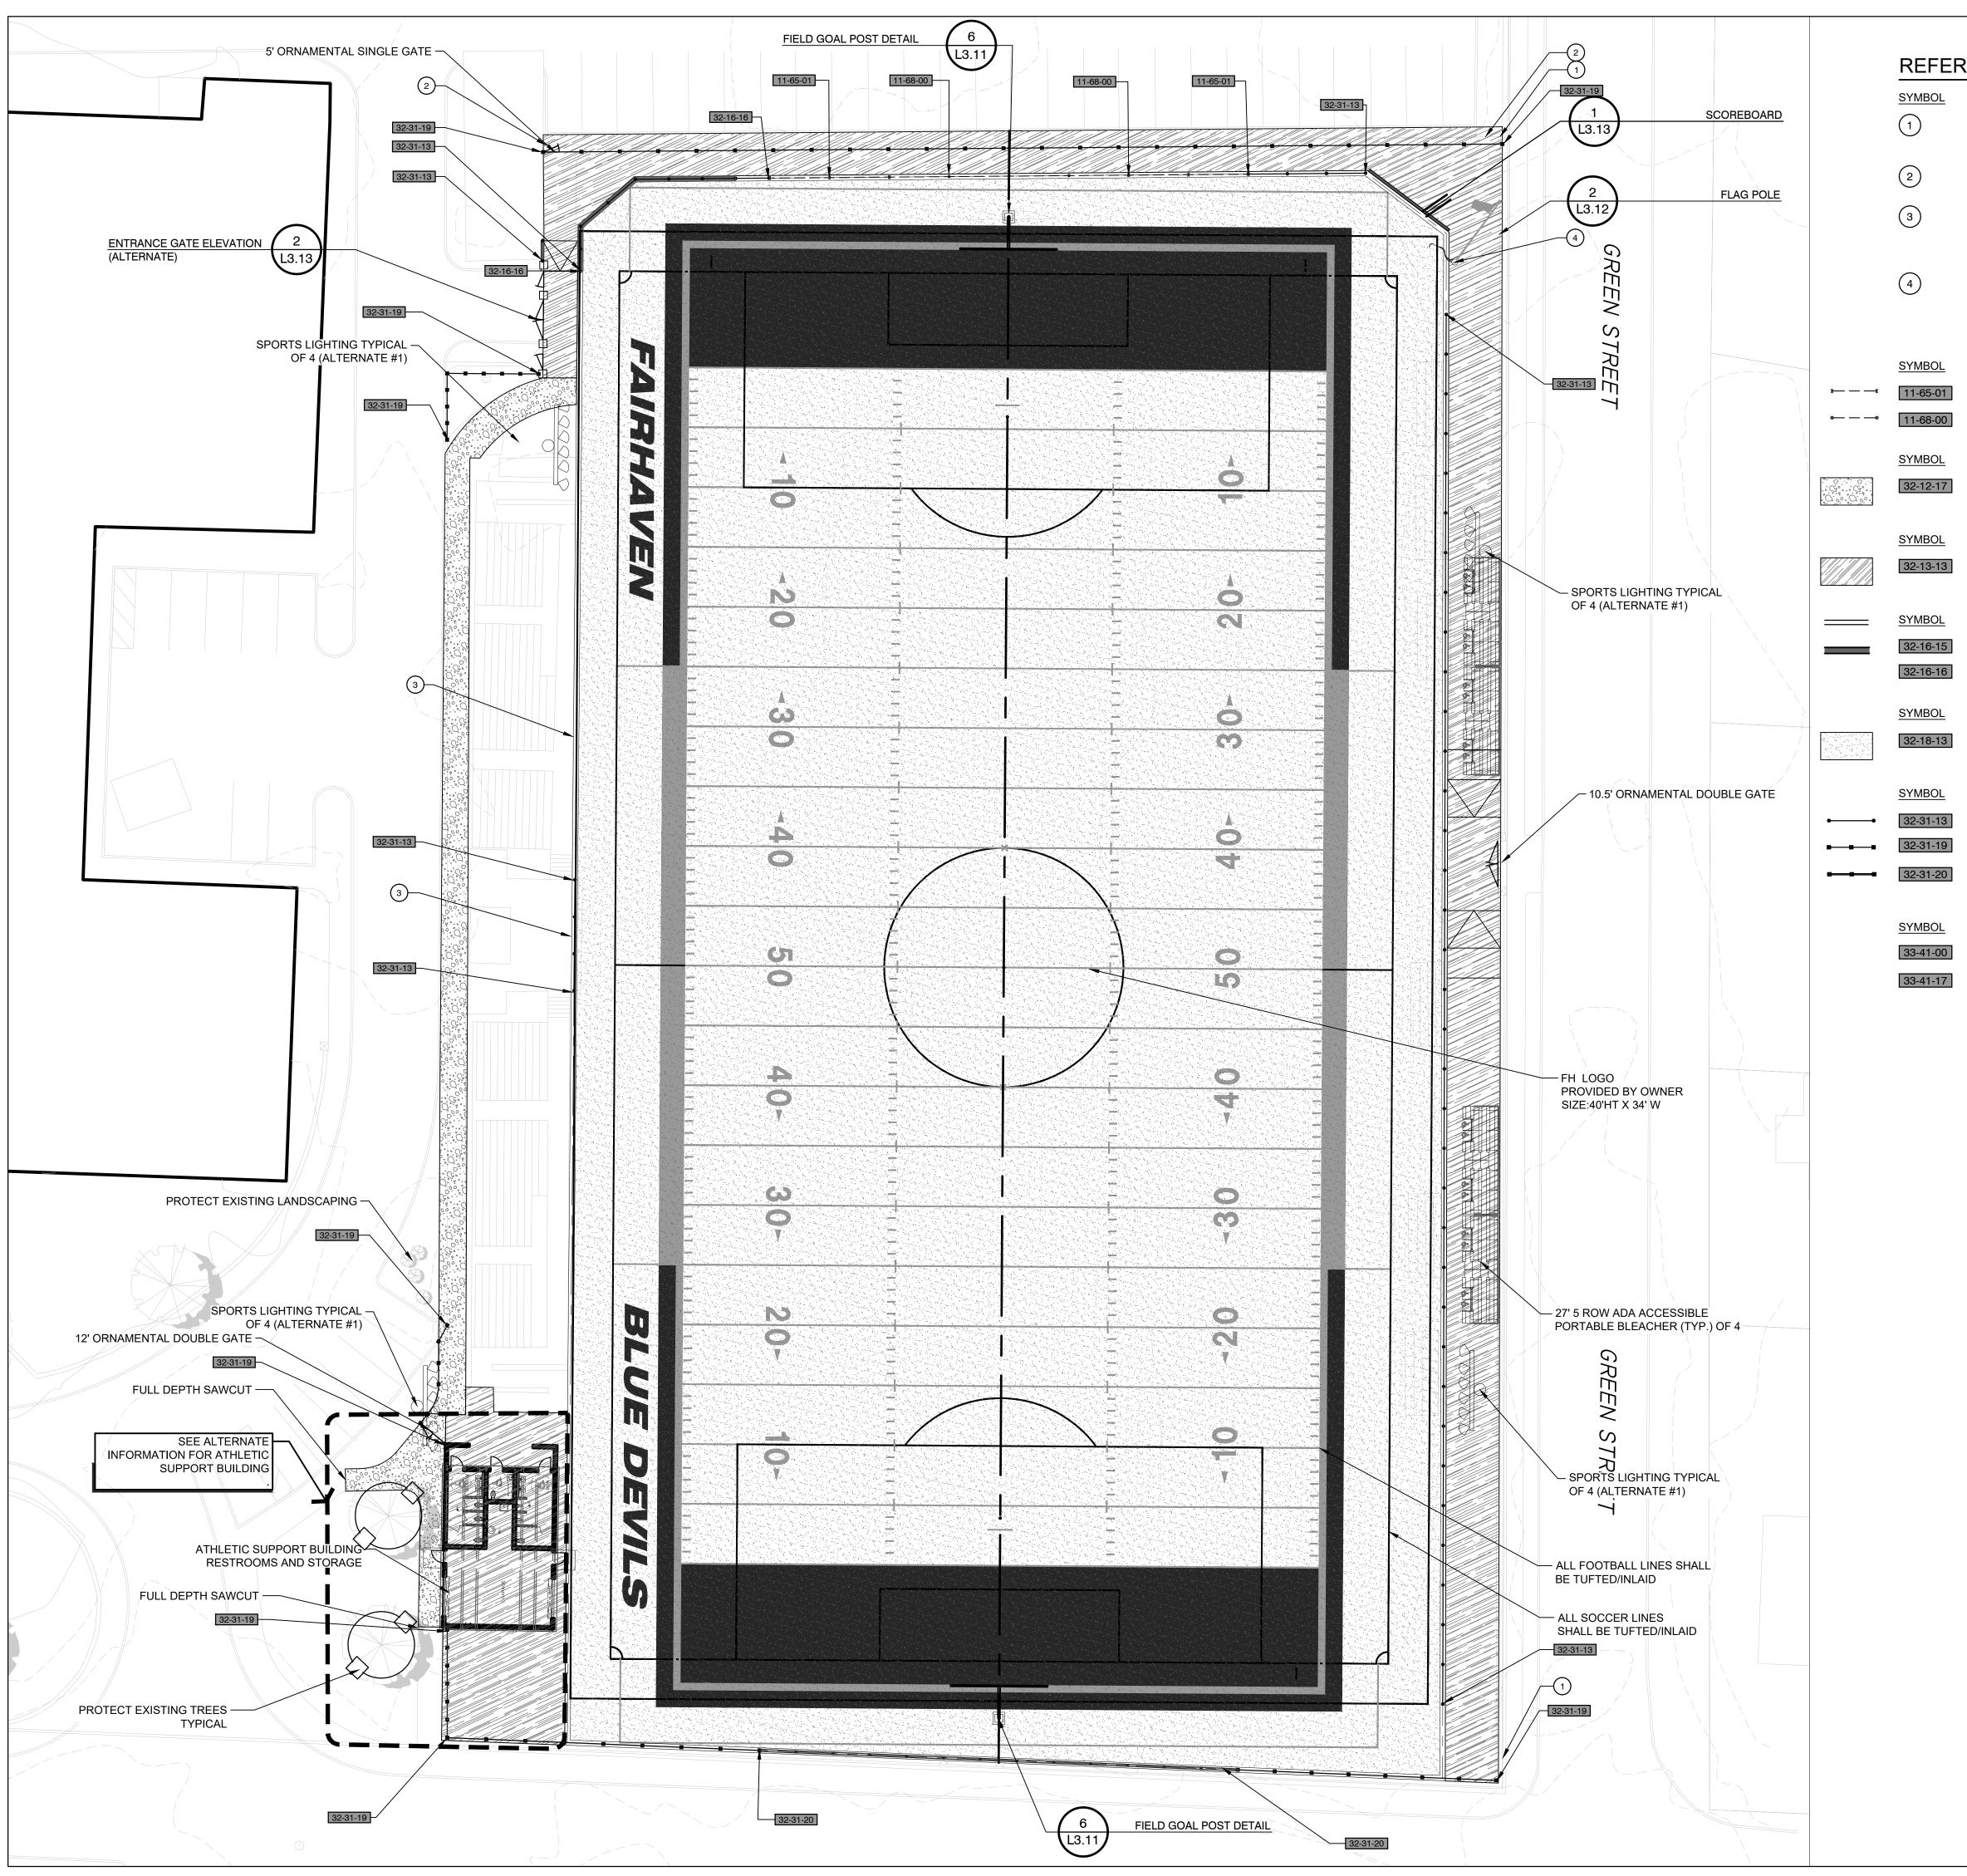

| ENCE NOTES SCHEDULE  |  |  |  |  |
|--|--|--|--|--|
| DESCRIPTION  | QTY  | DETAIL   |  |  |
| REMOVE FENCE FENCE FABRIC (PRIOR TO<br>PAVING ) PRESERVE FENCE POSTS AND<br>REPLACE FABRIC (AFTER PAVING)                |  |  |  |  |
| REMOVE AND DISPOSE OF EXISTING<br>FENCING IN CLUDING POSTS.  |  |  |  | 150<br>68⊦   |
| PLACE 1/2" EXPANSION JNT WITH FOAM<br>BACKER AND SEALAT AT EXISTING CLEAN<br>PAVEMENT EDGE (SAW CUT IF<br>NECESSARY)     |  |  |  |  |
| REMOVE EXISTING FLAG POLE. PRESERVE<br>AND RELOCATE POLE WITH NEW<br>FOUNDATION PER DETAIL OR<br>MANUFACTURERS DIRECTION |  |  |  | ST   |
| Play Field Equipment and Structures  |  | DETAIL   |  |  |
|  |  |  |  |  |
|  |  |  |  |  |
|  | 60 If  | 3/L3.11  |  |  |
| DESCRIPTION  | <u>QTY</u>   | DETAIL   | Alternate #  | cc   |
| HMA sidewalks  | 2,354 sf   | 1/L3.12  | #1   |  |
| CONCRETE PAVING<br>DESCRIPTION   | ΟΤΥ  |  | Alternate #  |  |
| Broom Finished Sidewalk  | <u>11,214</u> sf   | /  |  |  |
|  |  |  |  |  |
| DESCRIPTION  | QTY  | DETAIL   | Alternate #  |  |
| Field Curb with shelf  | 1,151 lf   | 3/L3.11  |  |  |
| Field Curb with PT Nailer Board  | 63 lf  | 9/L3.11  |  |  |
| ATHLETIC AND RECREATIONAL SURFACING<br>DESCRIPTION   | <u>QTY</u>   | DETAIL   | Alternate #  |  |
| Synthetic Turf   | 85,681 sf  | 1/L3.11  |  |  |
|  |  |  |  |  |
| DESCRIPTION  | <u>QTY</u>   | DETAIL   | Alternate #  |  |
| 4` Black Vinyl Chainlink   | 474 lf   | 6/L3.12  |  |  |
| Ornmental Fence  | 485 lf   | 3/L3.12  |  |  |
| Comination 20` Ball Safety Netting and<br>Ornamental Fence   | 120 lf   |  |  |  |
| STORM DRAINAGE UTILITIES<br>DESCRIPTION  | <u>QTY</u>   | DETAIL   |  | S⊦   |
| Storm Collector Drain  | 937 lf SE  | E CIVIL PLANS  |  |  |
| Flat Panel Drain   | 3,780 lf SE  | E CIVIL PLANS  |  |  |
|  | DESCRIPTION         REMOVE FENCE FENCE FABRIC (PRIOR TO<br>PAVING) PRESERVE FENCE POSTS AND<br>REPLACE FABRIC (AFTER PAVING)         REMOVE AND DISPOSE OF EXISTING<br>FENCING IN CLUDING POSTS.         PLACE 1/2" EXPANSION JNT WITH FOAM<br>BACKER AND SEALAT AT EXISTING CLEAN<br>PAVEMENT EDGE (SAW CUT IF<br>NECESSARY)         REMOVE EXISTING FLAG POLE. PRESERVE<br>AND RELOCATE POLE WITH NEW<br>FOUNDATION PER DETAIL OR<br>MANUFACTURERS DIRECTION         Play Field Equipment and Structures<br>DESCRIPTION         12' Ball Safety Netting in Field Curb         20' Ball Safety Netting in Field Curb         BCSCRIPTION         HMA sidewalks         CONCRETE PAVING<br>DESCRIPTION         Broom Finished Sidewalk         CURBS AND GUTTERS<br>DESCRIPTION         Field Curb with shelf         Field Curb with PT Nailer Board         ATHLETIC AND RECREATIONAL SURFACING<br>DESCRIPTION         Synthetic Turf         FENCES AND GATES<br>DESCRIPTION         4' Black Vinyl Chainlink         Ornmental Fence         Comination 20' Ball Safety Netting and<br>Ornamental Fence         STORM DRAINAGE UTILLITIES<br>DESCRIPTION         Storm Collector Drain | DESCRIPTIONQTYREMOVE FENCE FENCE FABRIC (PRIOR TO<br>PAVING) PRESERVE FENCE POSTS AND<br>REPLACE FABRIC (AFTER PAVING) | DESCRIPTIONQTYDETAILREMOVE FENCE FACE FABRIC (PRIOR TO<br>PAVING) PRESERVE FENCE POSTS AND<br>REPLACE FABRIC (AFTER PAVING)REMOVE AND DISPOSE OF EXISTING<br>FENCING IN CLUDING POSTS.PLACE 1/2" EXPANSION JNT WITH FOAM<br>BACKER AND SEALAT AT EXISTING CLEAN<br>PAVEMENT EDGE (SAW CUT IF<br>NECESSARY)REMOVE EXISTING FLAG POLE. PRESERVE<br>AND RELOCATE POLE WITH NEW<br>FOUNDATION PER DETAIL OR<br>MANUFACTURERS DIRECTIONQTYDETAILPlay Field Equipment and Structures<br>DESCRIPTIONQTYDETAIL20' Ball Safety Netting in Field Curb60 If3/L3.1120' Ball Safety Netting in Field Curb60 If3/L3.12CONCRETE PAVING<br>DESCRIPTIONQTYDETAILHMA sidewalks2,354 sf1/L3.12CONCRETE PAVING<br>DESCRIPTIONQTYDETAILField Curb with shelf1,151 If3/L3.11Field Curb with shelf1,151 If3/L3.11Field Curb with shelf1,151 If3/L3.11Field Curb with PT Nailer BoardG3 If9/L3.11ATHLETIC AND RECREATIONAL SURFACING<br>DESCRIPTIONQTYDETAILSynthetic Turf85,681 sf1/L3.12Commental Fence435 If3/L3.12Commental Fence435 If3/L3.12Commental Fence435 If3/L3.12Commental Fence435 If3/L3.12Commental Fence435 If3/L3.12Commental Fence435 If3/L3.12Commental Fence315 3/L3.12Commental Fence315 3/L3.12Commental Fe | DESCRIPTIONOTYDETAILREMOVE FENCE FENCE FABRIC (PRIOR TO<br>PAVING ) PRESERVE FENCE POSTS AND<br>REPLACE FABRIC (AFTER PAVING)Image: Constraint of the state of the |

NORTH

1" = 20'

60 feet



12 HUTTLESTONE AVE FAIRHAVEN , MA 02719

# SUBMITTAL

| SCHEMATIC DESIGN      | 2021/01/2 |
|-----------------------|-----------|
| DESIGN DEVELOPMENT    | 2021/03/0 |
| ISSUED FOR PERMITTING | 2021/03/2 |

NO. REVISIONS




CHECKED BY:

SCALE:

AE

1"=20'

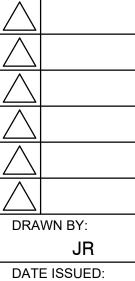



03/22/2021 PROJ. NO.


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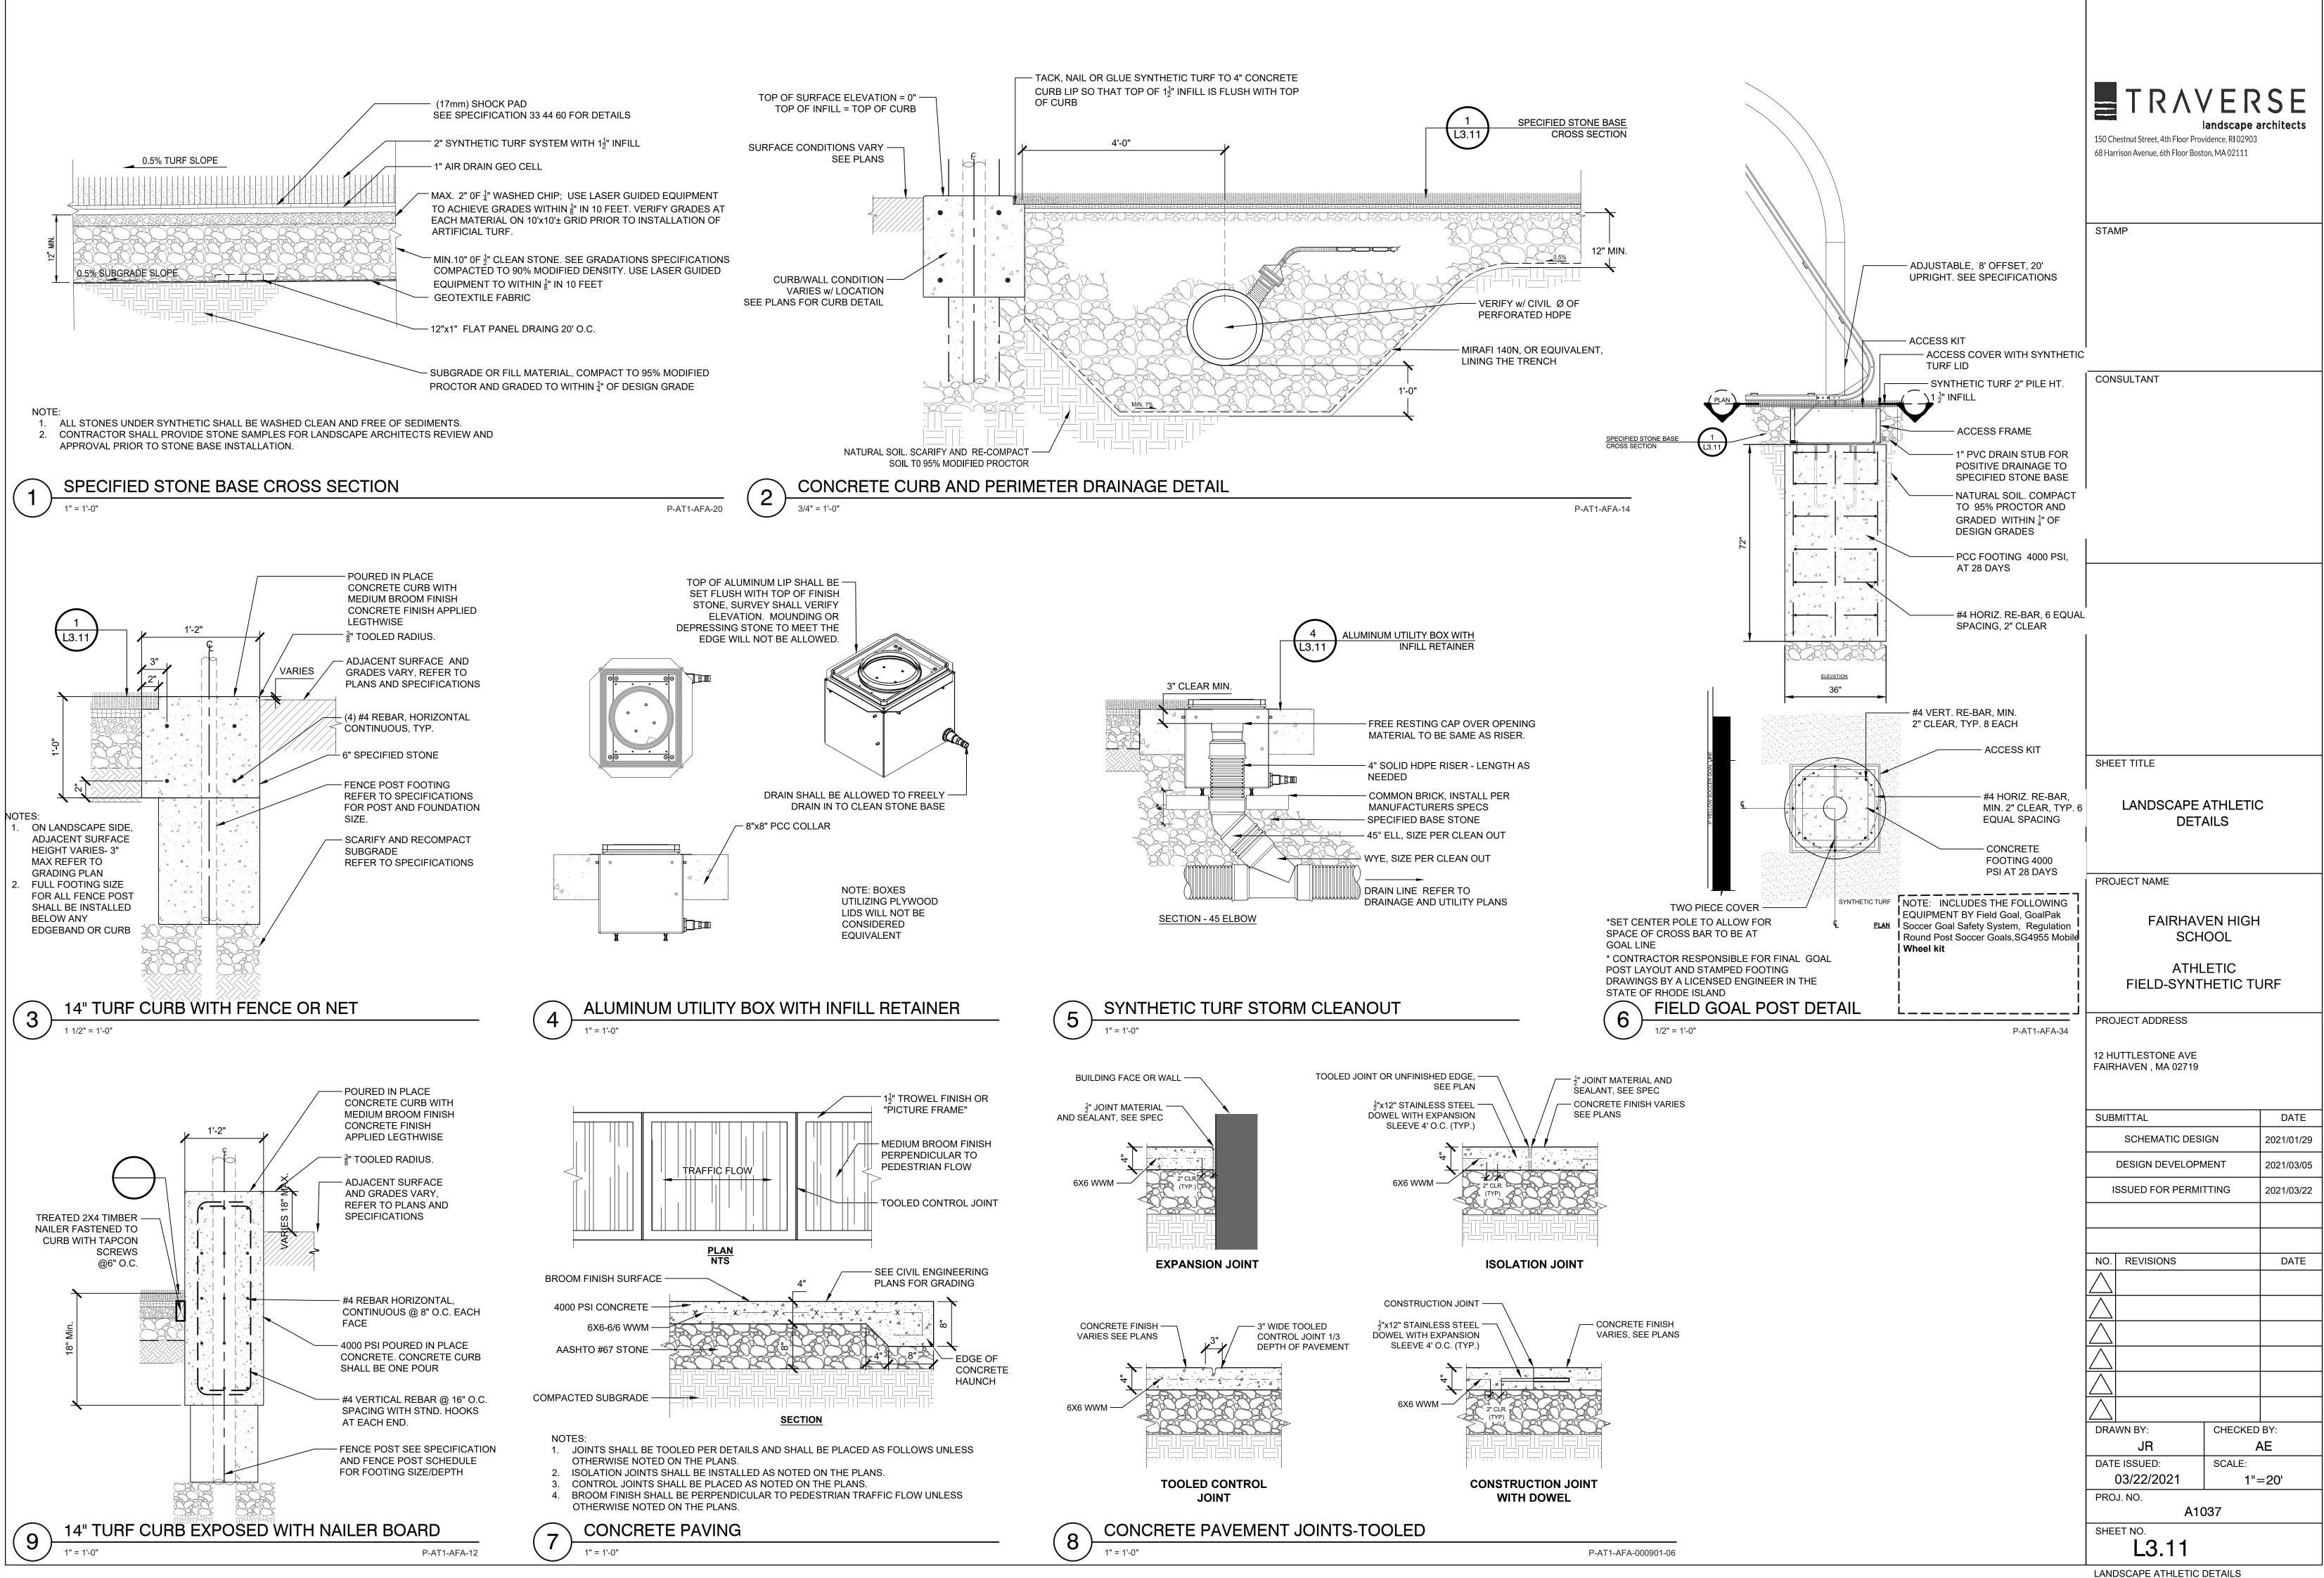
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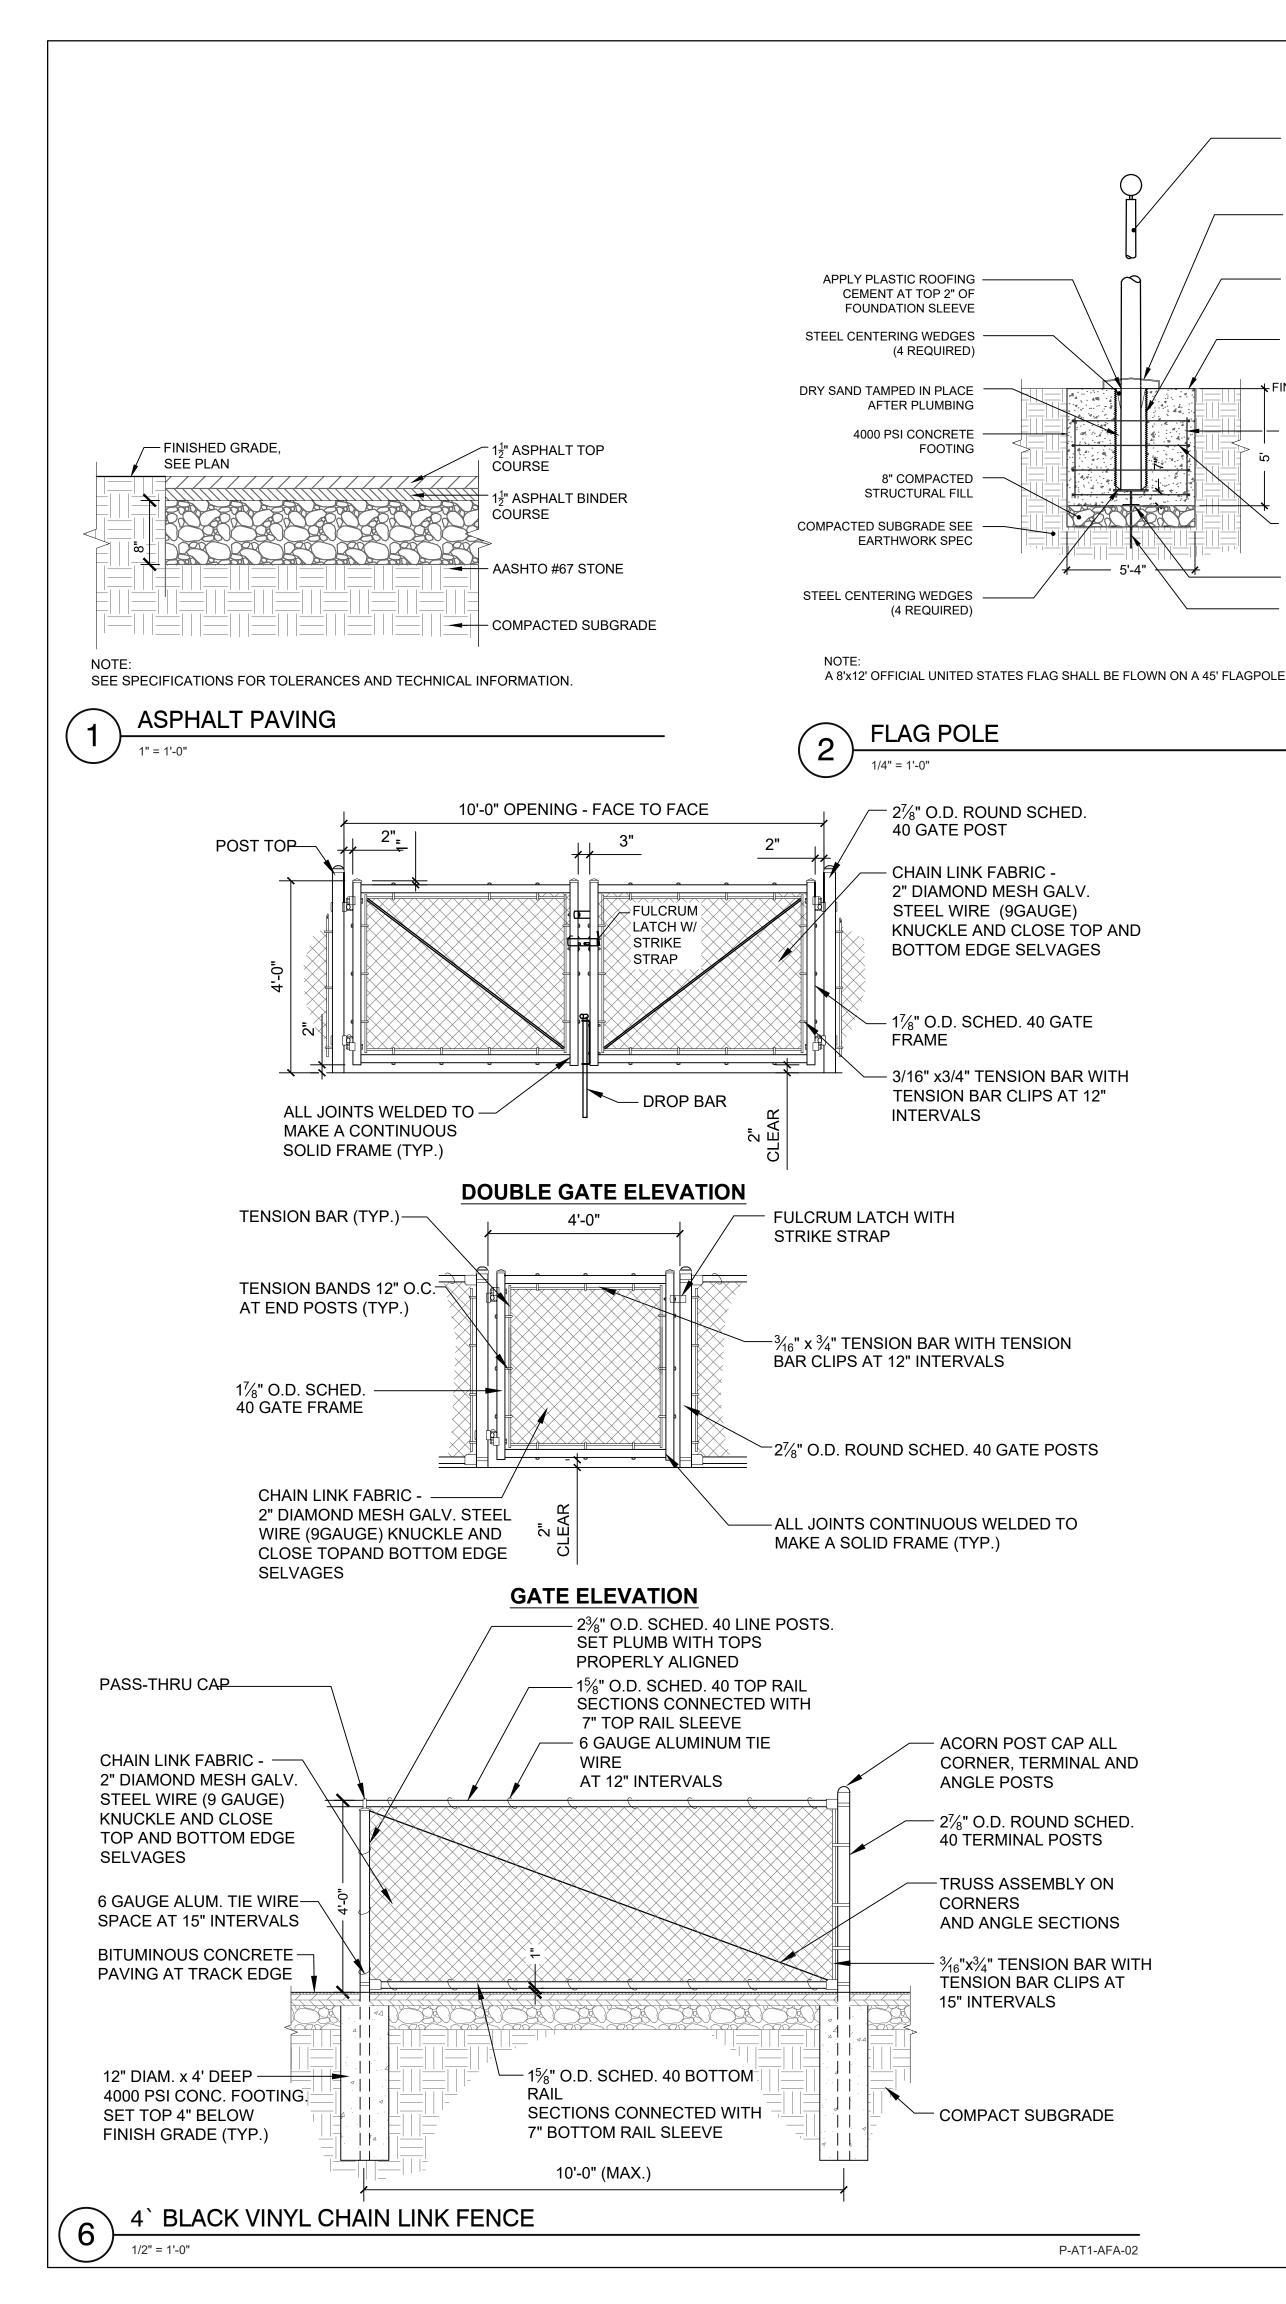
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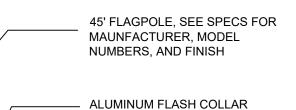






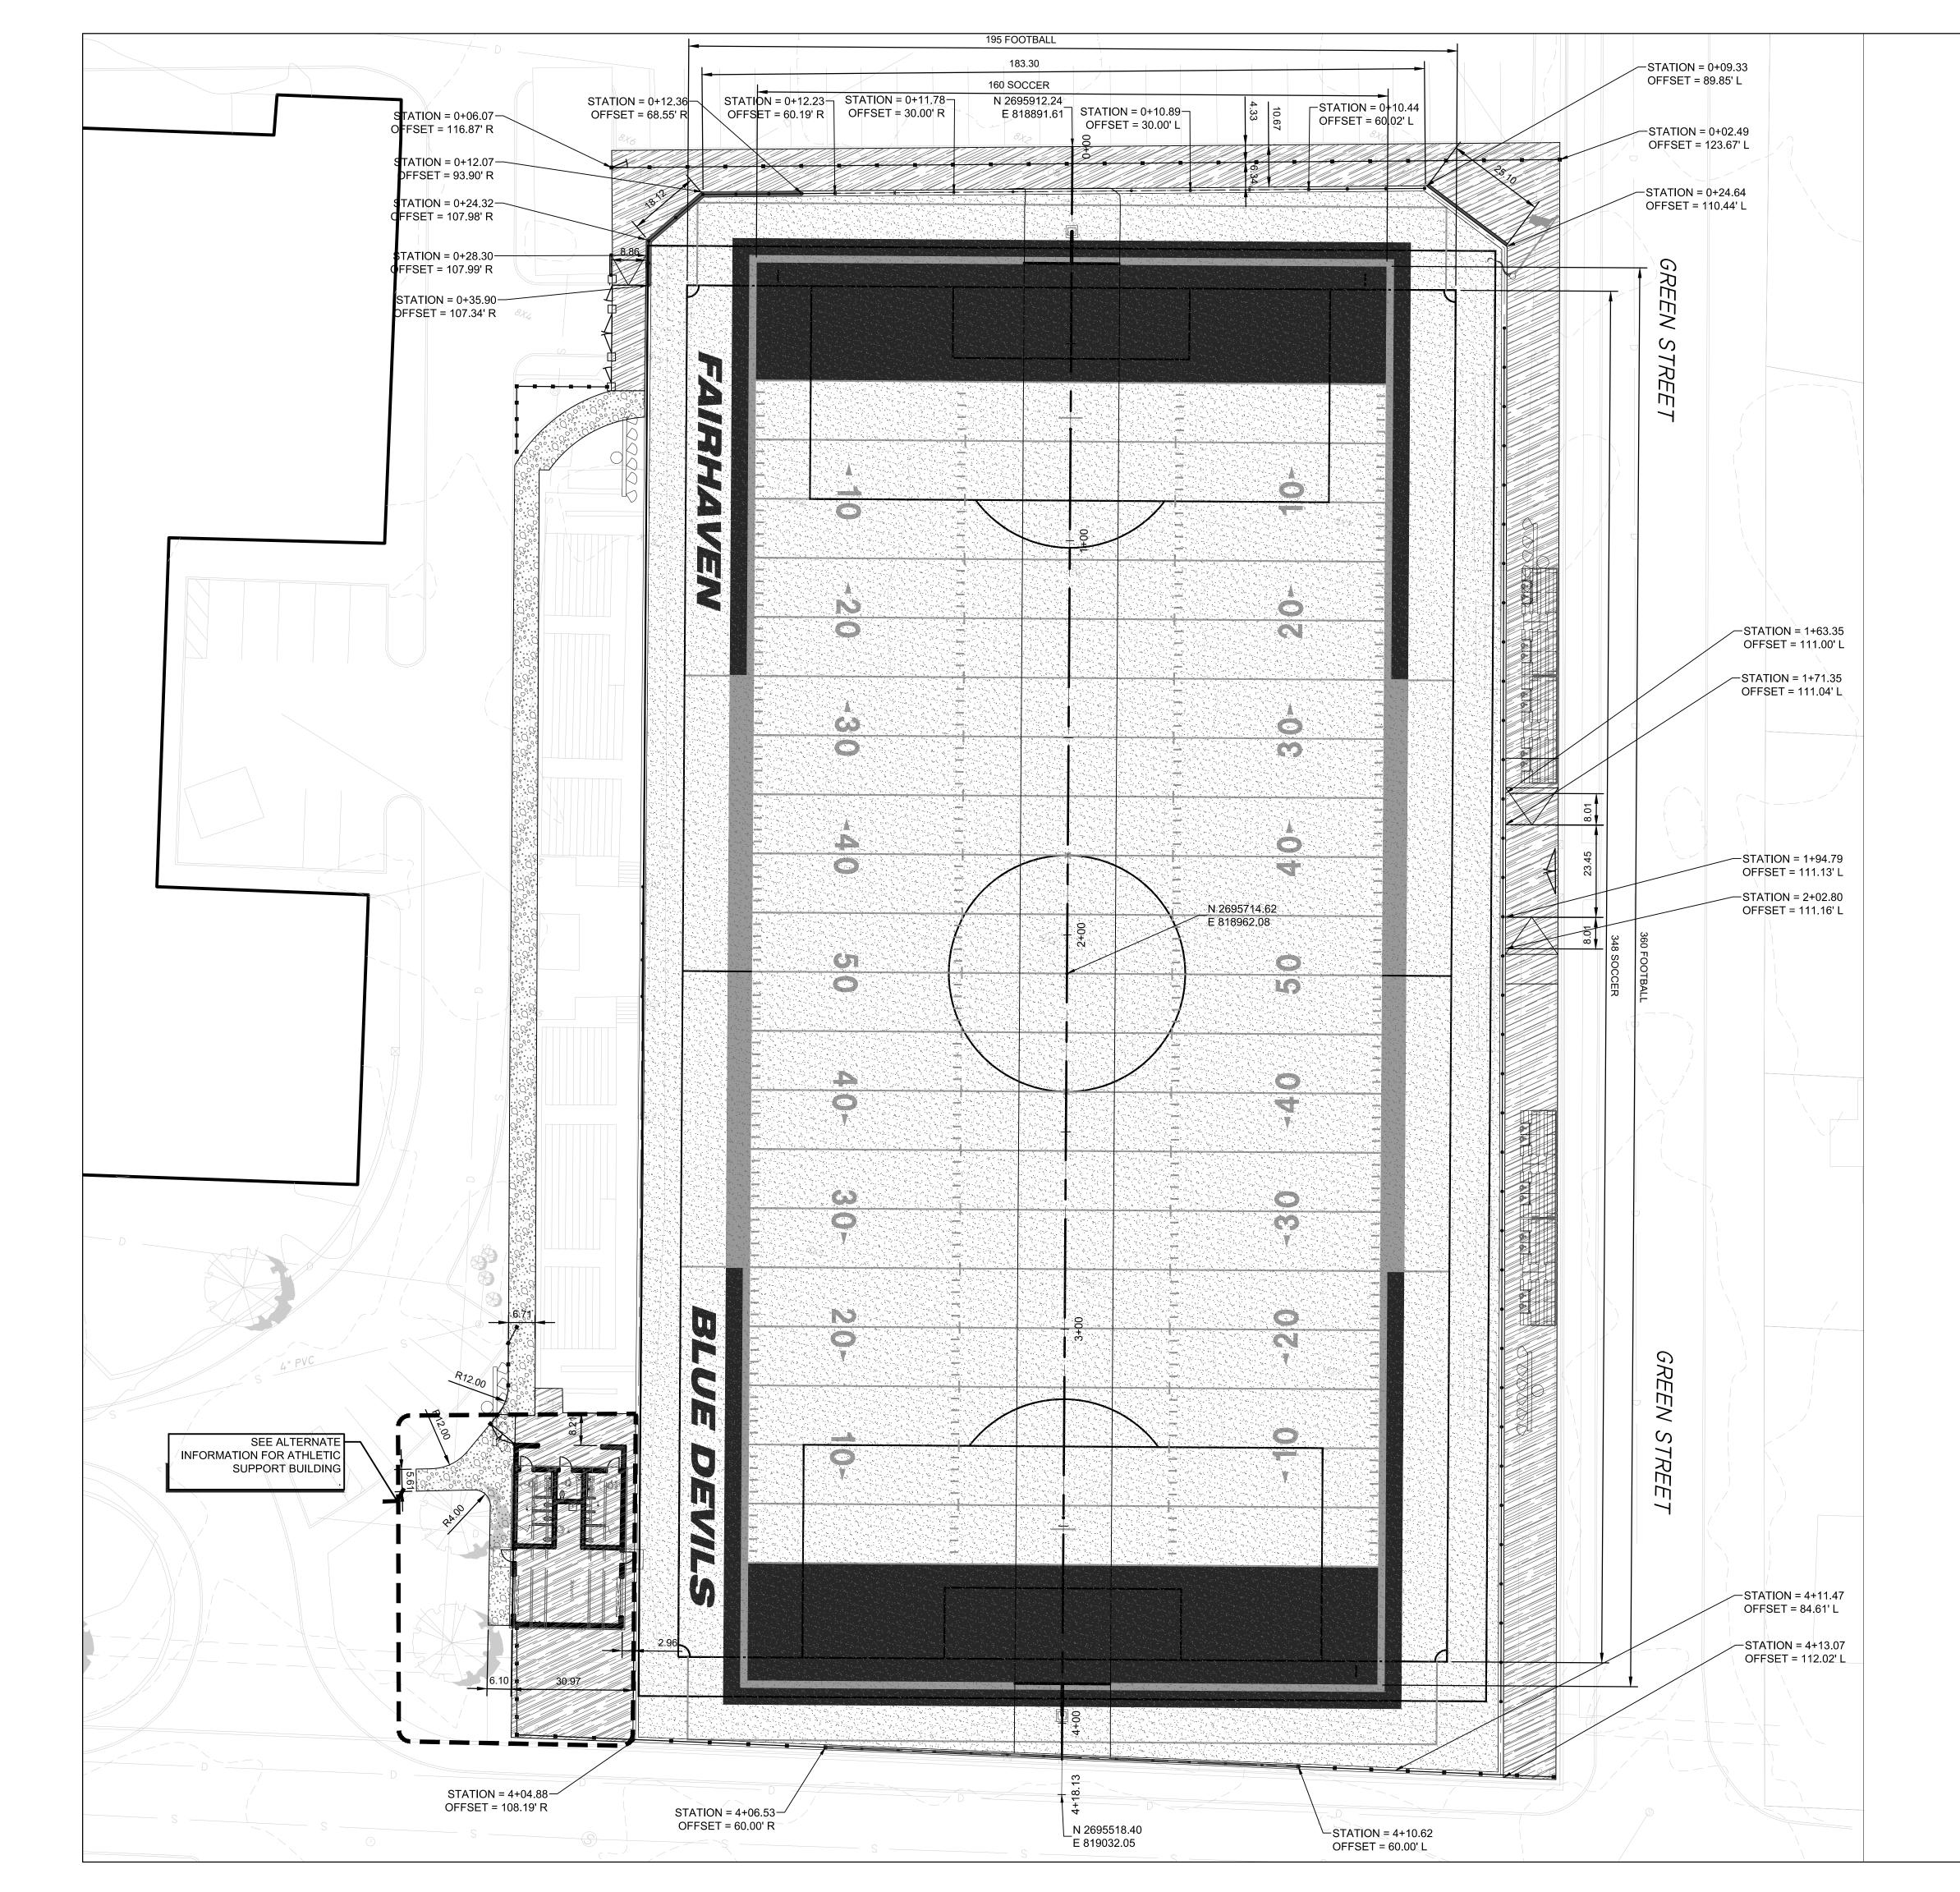

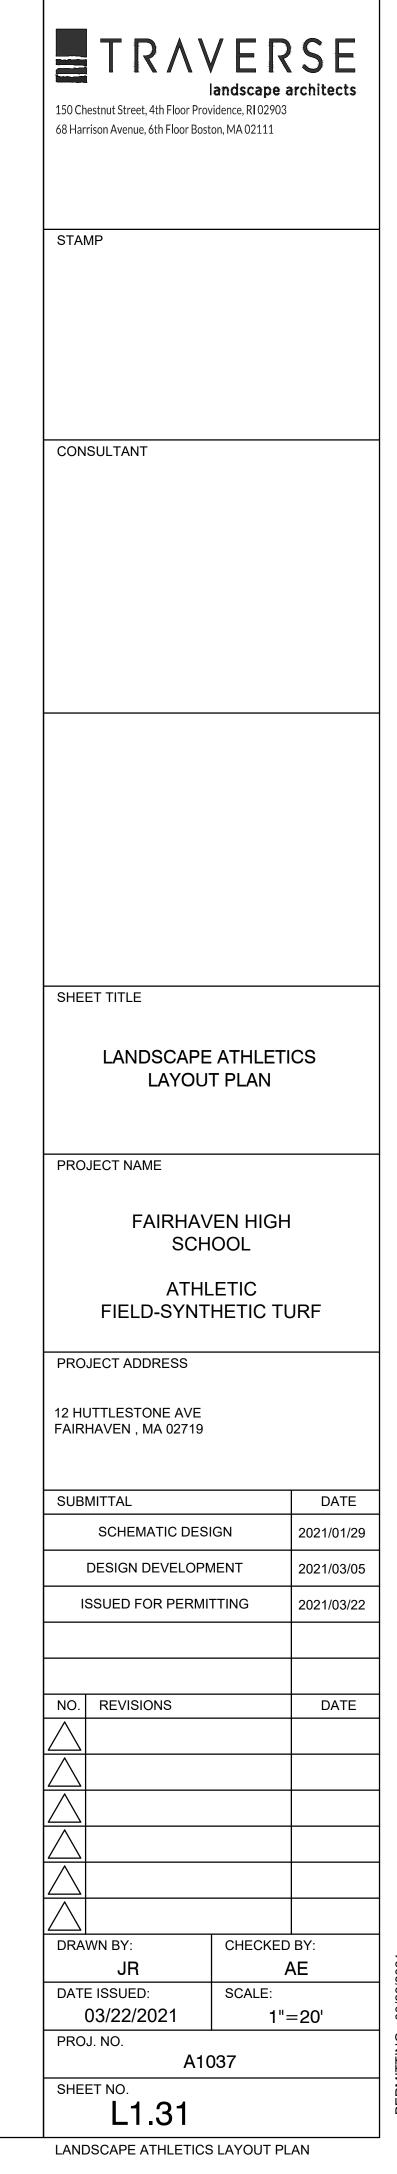

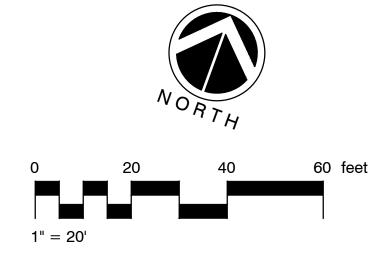


12"Øx53"± LONG METAL FOUNDATION SLEEVE BY FLAGPOLE MANUFACTURER CONCRETE FLUSH WITH FINISHED GRADE, SLOPED TO DRAIN FINISHED GRADE

(8)-#5 VERTICAL EQ. SPACED (TYP.)

#4 TIES @ 12" O.C. (TYP.)


STEEL BASE PLATE STEEL SUPPORT PLATE WELD TO GROUND SPIKE

P-AT1-AFA-324013-05

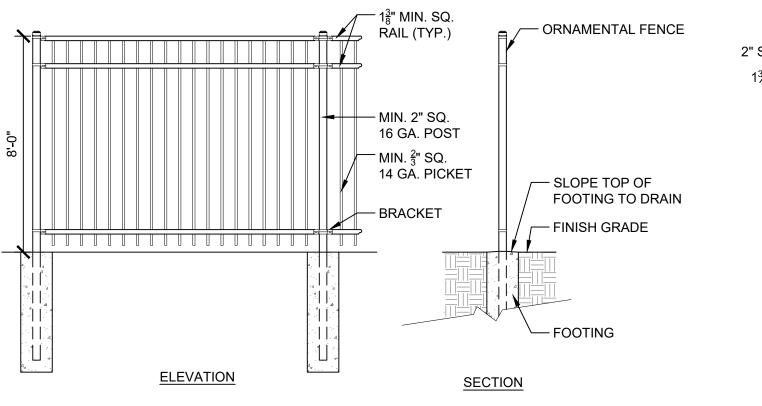

NOTES:

1. ORNAMENTAL FENCE SHALL BE INSTALLED AT LOCATIONS SHOWN ON THE PLANS. 2. INSTALLATION TO BE COMPLETED IN ACCORDANCE WITH MANUFACTURER'S SPECIFICATIONS.

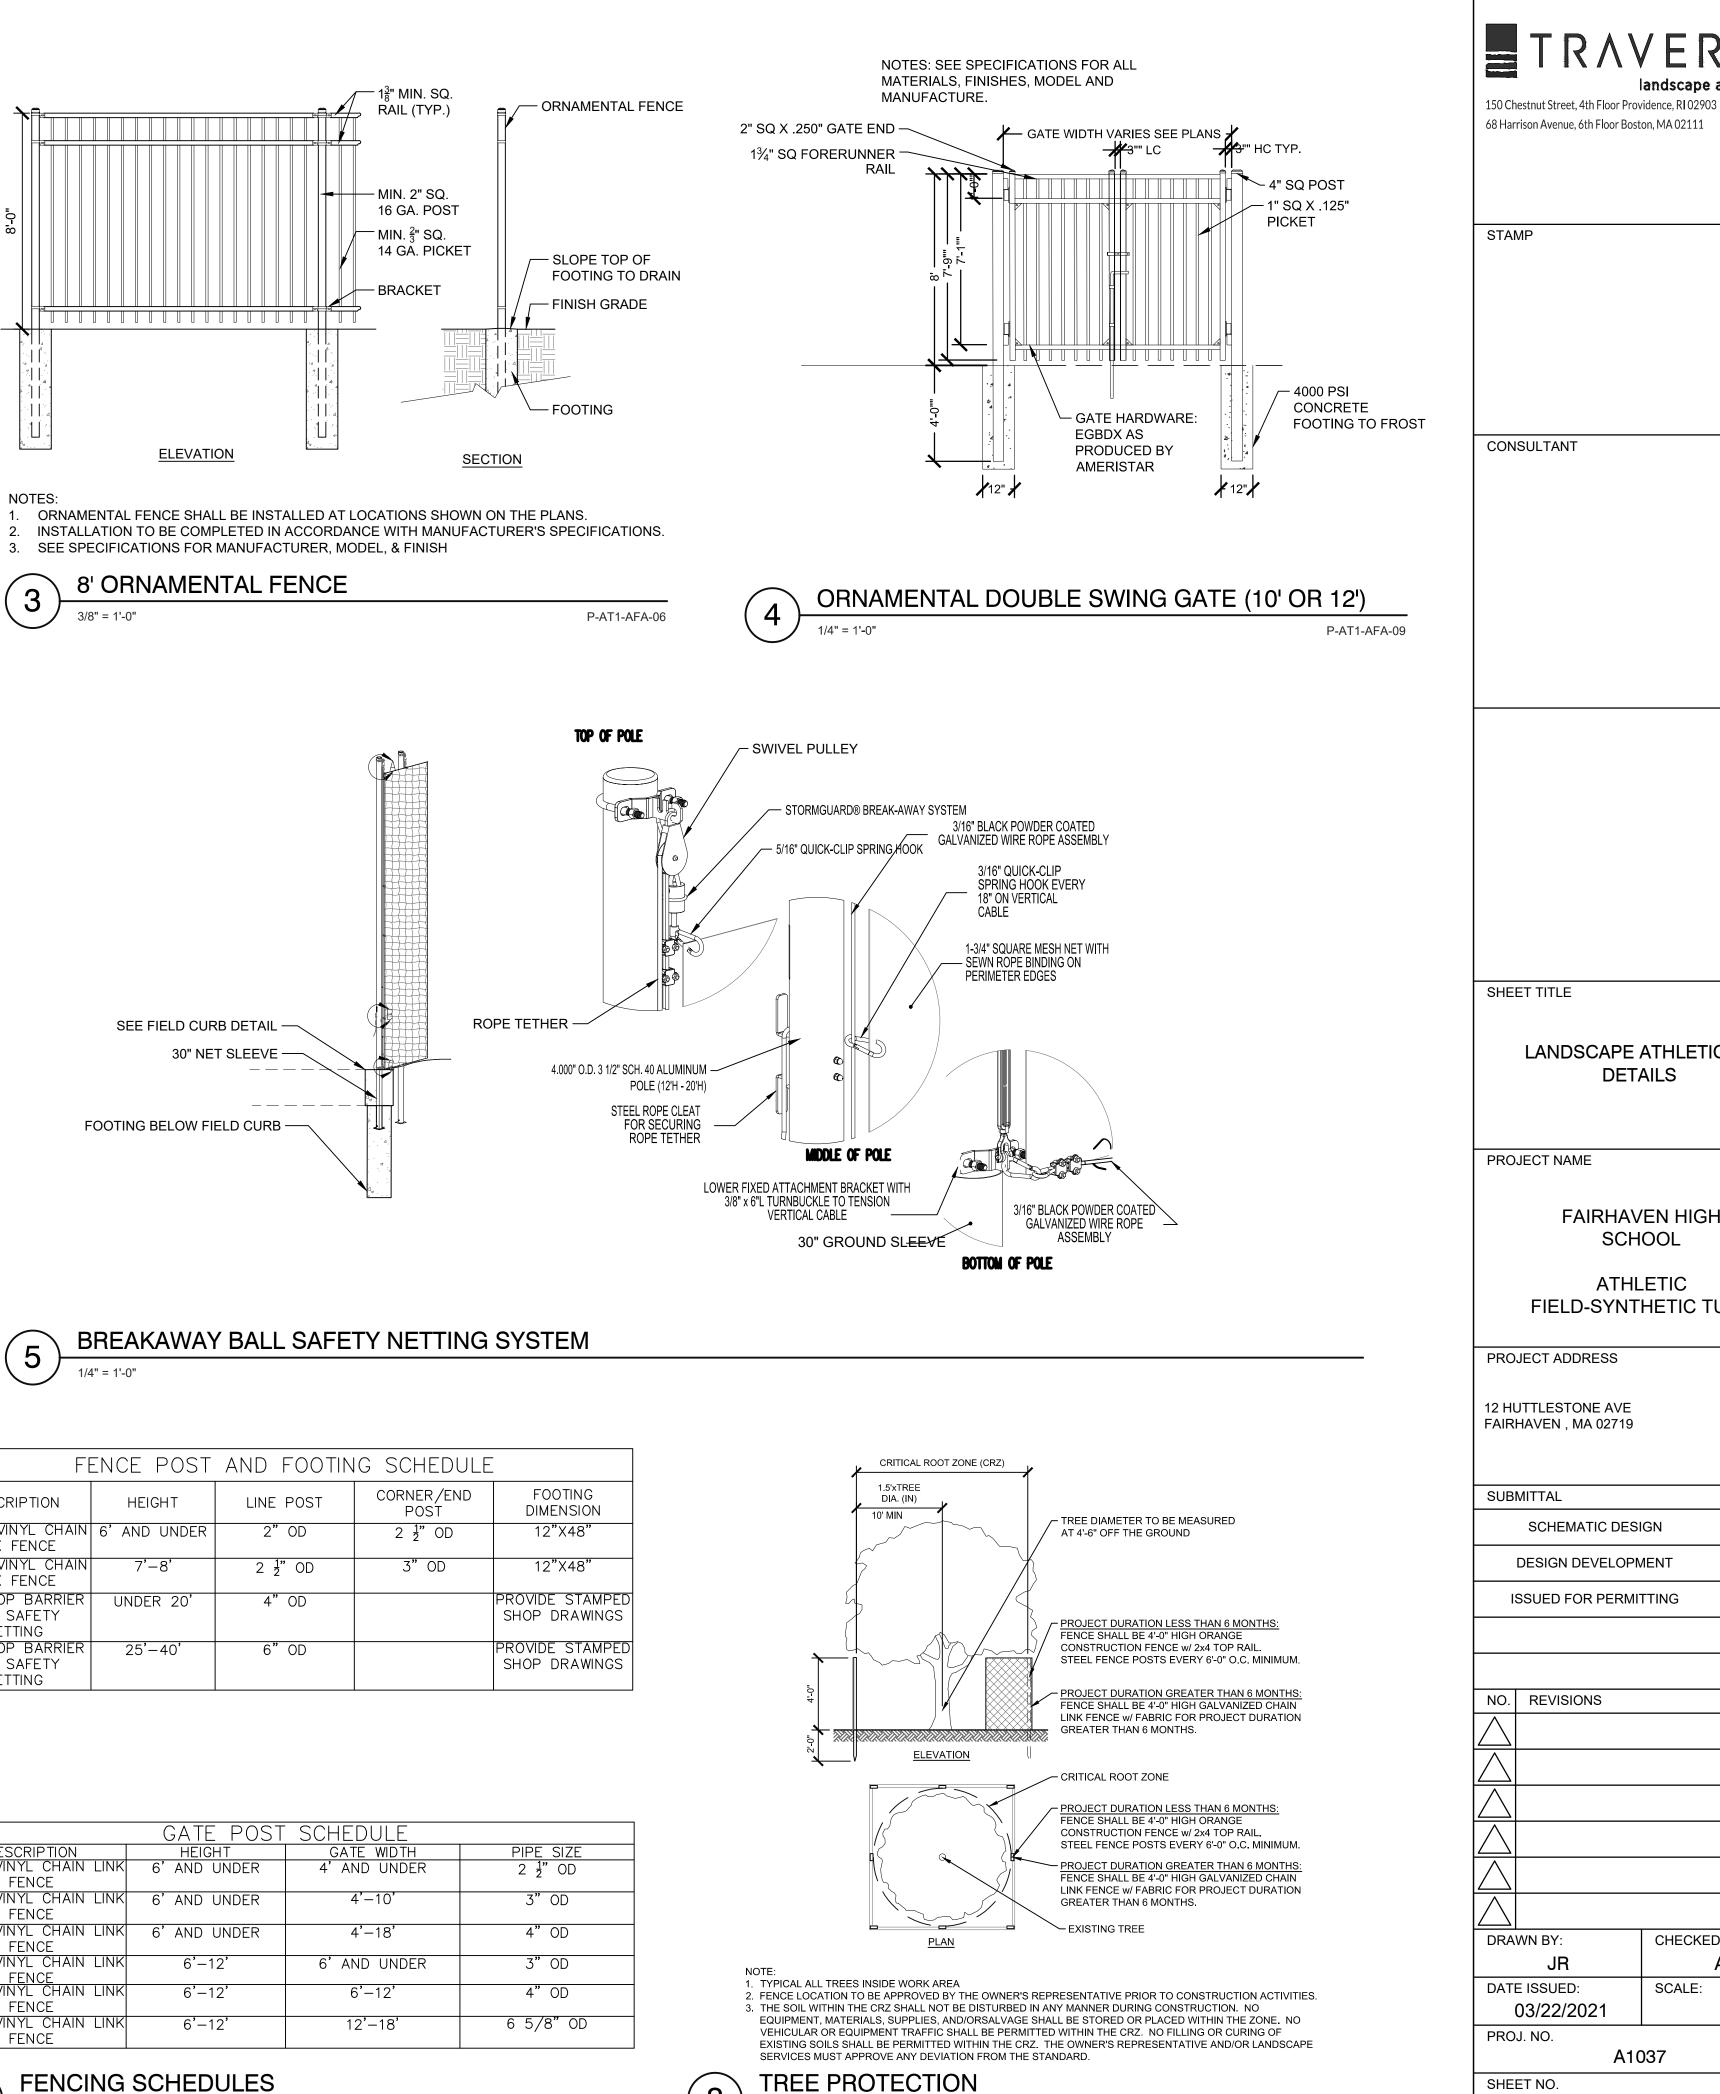



| F   | FENCE POST AND FOOTING SCHEDULE |                 |                    |                                  |  |  |  |
|---|---------------------------------|-----------------|--------------------|----------------------------------|--|--|--|
| DESCRIPTION                               | HEIGHT                          | LINE POST       | CORNER/END<br>POST | FOOTING<br>DIMENSION             |  |  |  |
| BLACK VINYL CHAIN<br>LINK FENCE           | 6' AND UNDER                    | 2" OD           | 2 <u>1</u> " OD    | 12"X48"                          |  |  |  |
| BLACK VINYL CHAIN<br>LINK FENCE           | 7'–8'                           | 2 <u>1</u> " OD | 3" OD              | 12"X48"                          |  |  |  |
| BALLSTOP BARRIER<br>AND SAFETY<br>NETTING | UNDER 20'                       | 4" OD           |                    | PROVIDE STAMPED<br>SHOP DRAWINGS |  |  |  |
| BALLSTOP BARRIER<br>AND SAFETY<br>NETTING | 25'-40'                         | 6" OD           |                    | PROVIDE STAMPED<br>SHOP DRAWINGS |  |  |  |

| GATE POST SCHEDULE              |              |              |                 |  |  |  |  |
|---------------------------------|--------------|--------------|-----------------|--|--|--|--|
| DESCRIPTION                     | HEIGHT       | GATE WIDTH   | PIPE SIZE       |  |  |  |  |
| BLACK VINYL CHAIN LINK<br>FENCE | 6' AND UNDER | 4' AND UNDER | 2 <u>1</u> " OD |  |  |  |  |
| BLACK VINYL CHAIN LINK<br>FENCE | 6' AND UNDER | 4'-10'       | 3" OD           |  |  |  |  |
| BLACK VINYL CHAIN LINK<br>FENCE |              | 4'-18'       | 4" OD           |  |  |  |  |
| BLACK VINYL CHAIN LINK<br>FENCE | 5 12         | 6' AND UNDER | 3" OD           |  |  |  |  |
| BLACK VINYL CHAIN LINK<br>FENCE | 0 12         | 6'–12'       | 4" OD           |  |  |  |  |
| BLACK VINYL CHAIN LINK<br>FENCE | 6'–12'       | 12'–18'      | 6 5/8"OD        |  |  |  |  |



FENCING SCHEDULES

8

3/16" = 1'-0"

RAVERSE

landscape architects

L3.12 LANDSCAPE ATHLETIC DETAILS

A1037

JR

CHECKED BY:

SCALE:

AE

LANDSCAPE ATHLETIC

DETAILS

FAIRHAVEN HIGH

SCHOOL

ATHLETIC FIELD-SYNTHETIC TURF

SCHEMATIC DESIGN


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2021/01/29


2021/03/05

2021/03/22


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3

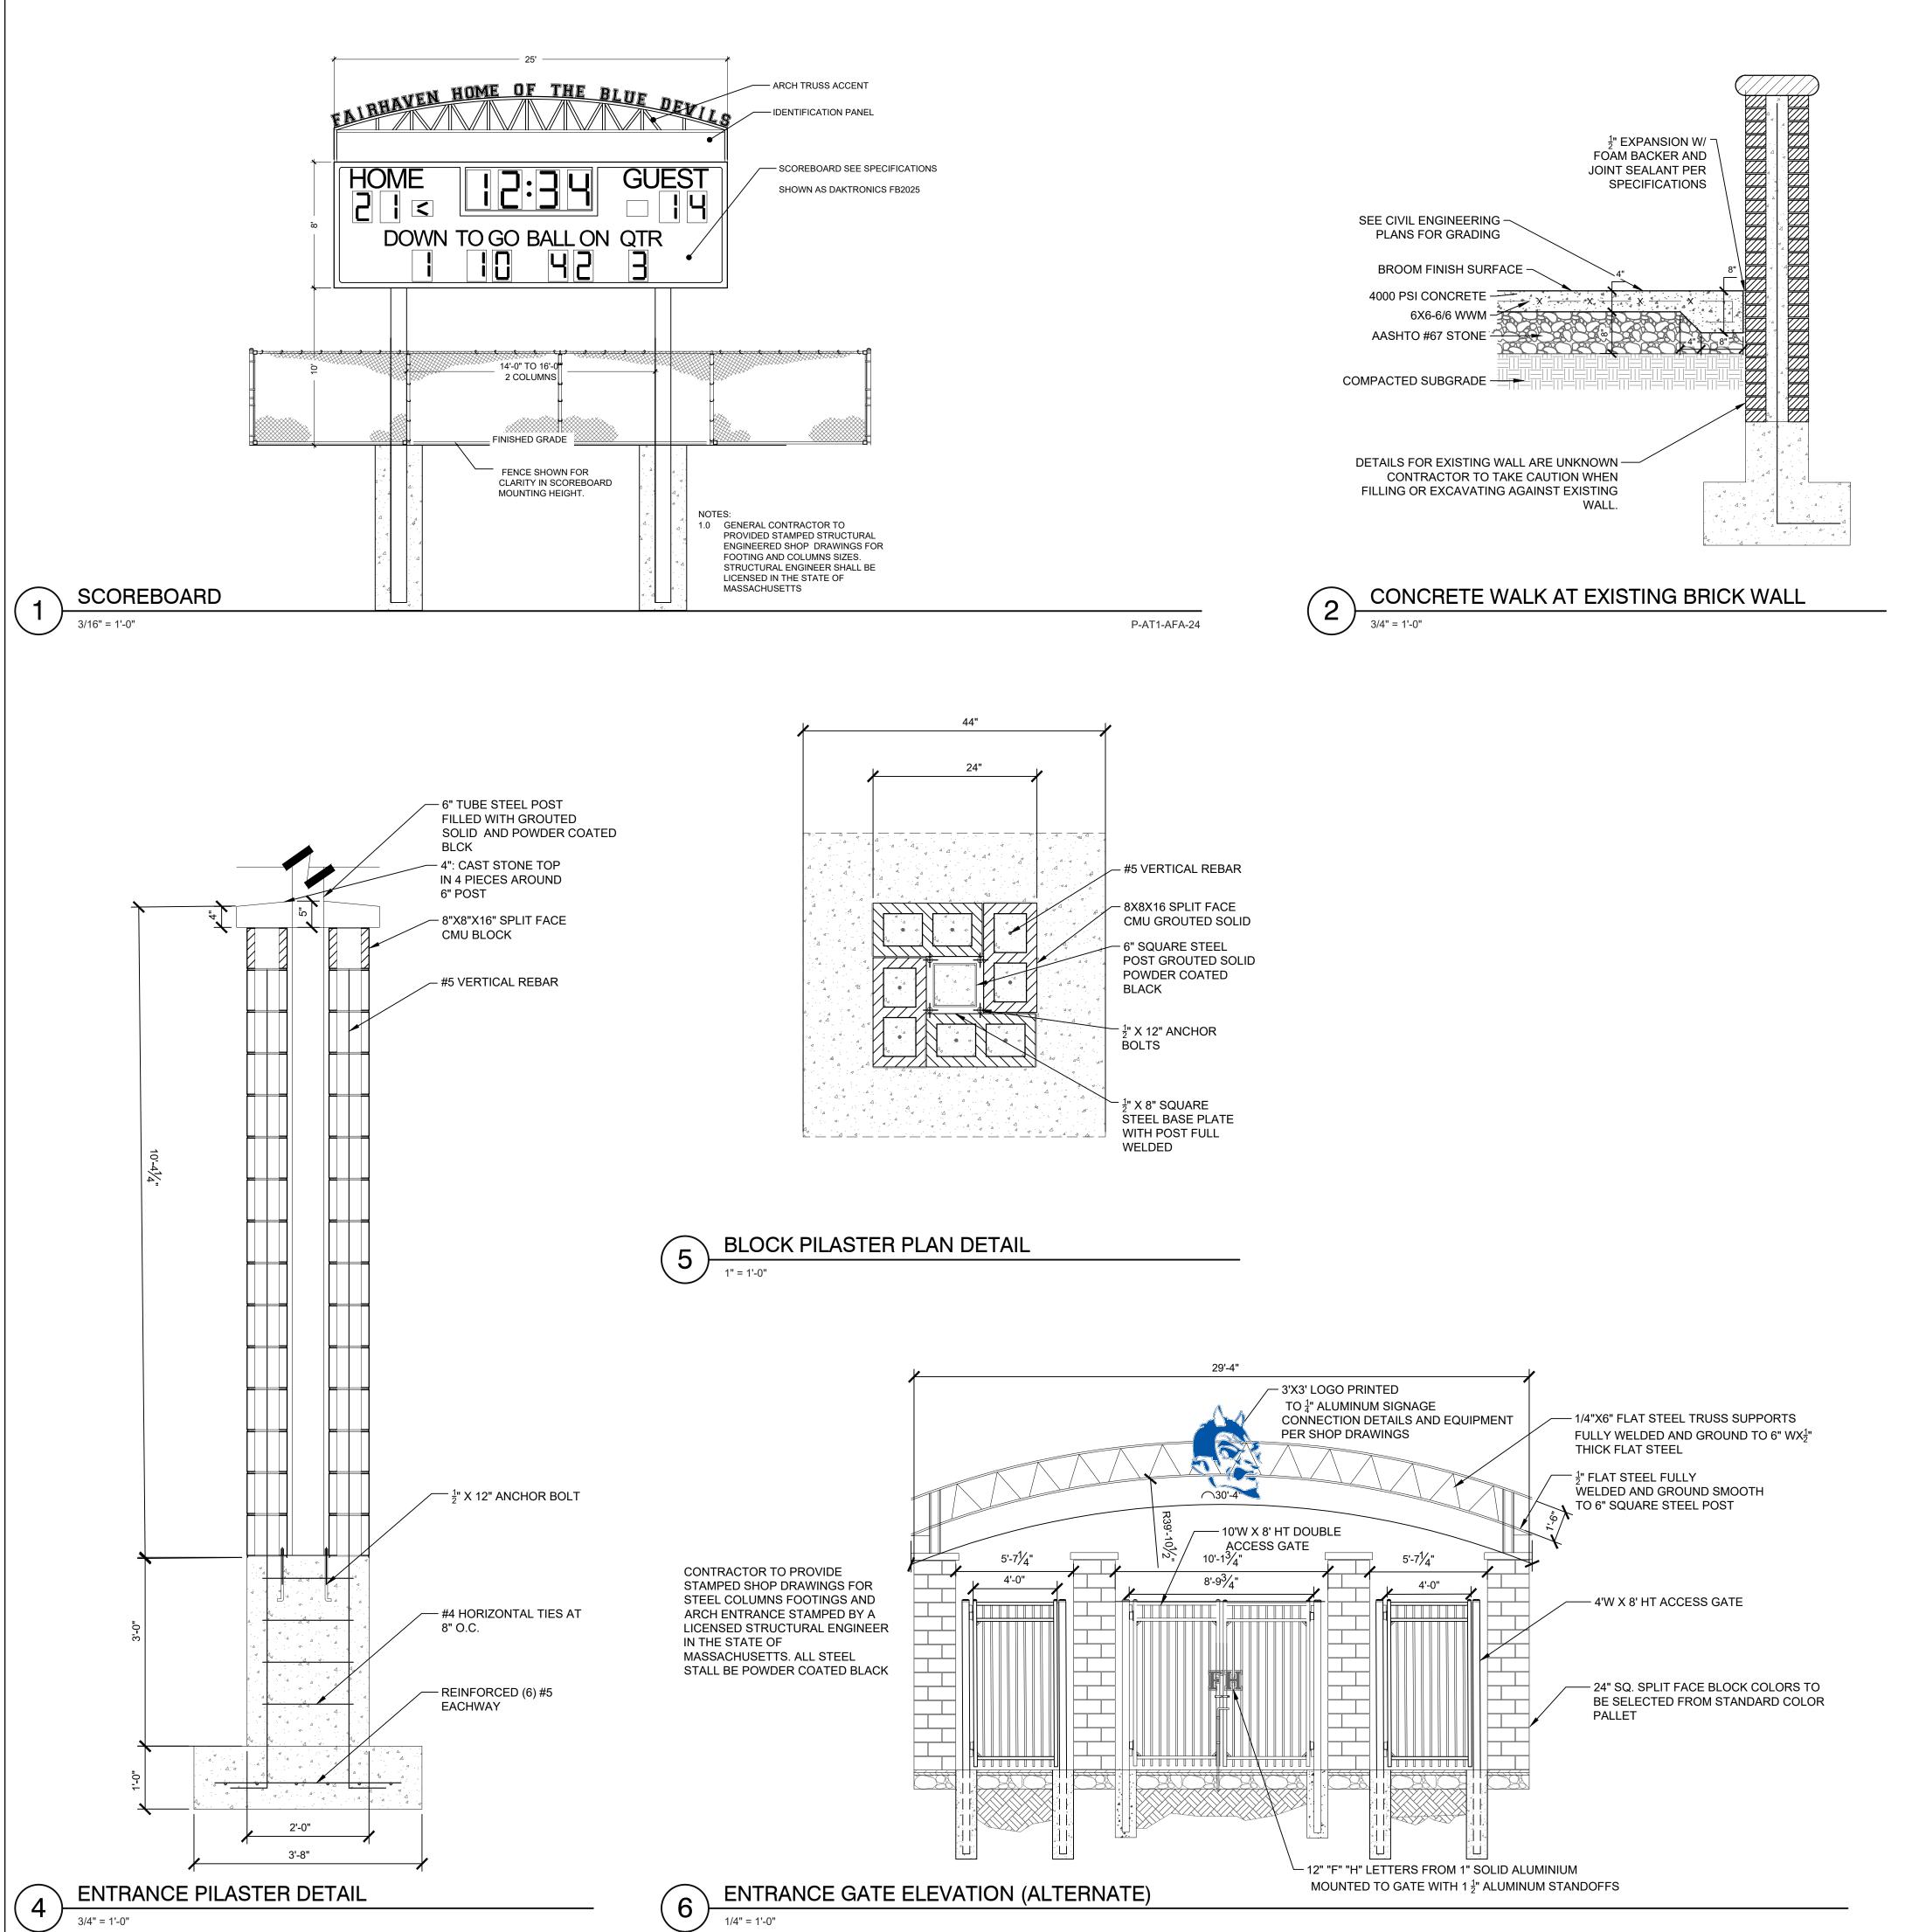

LANDSCAPE ATHLETIC DETAILS

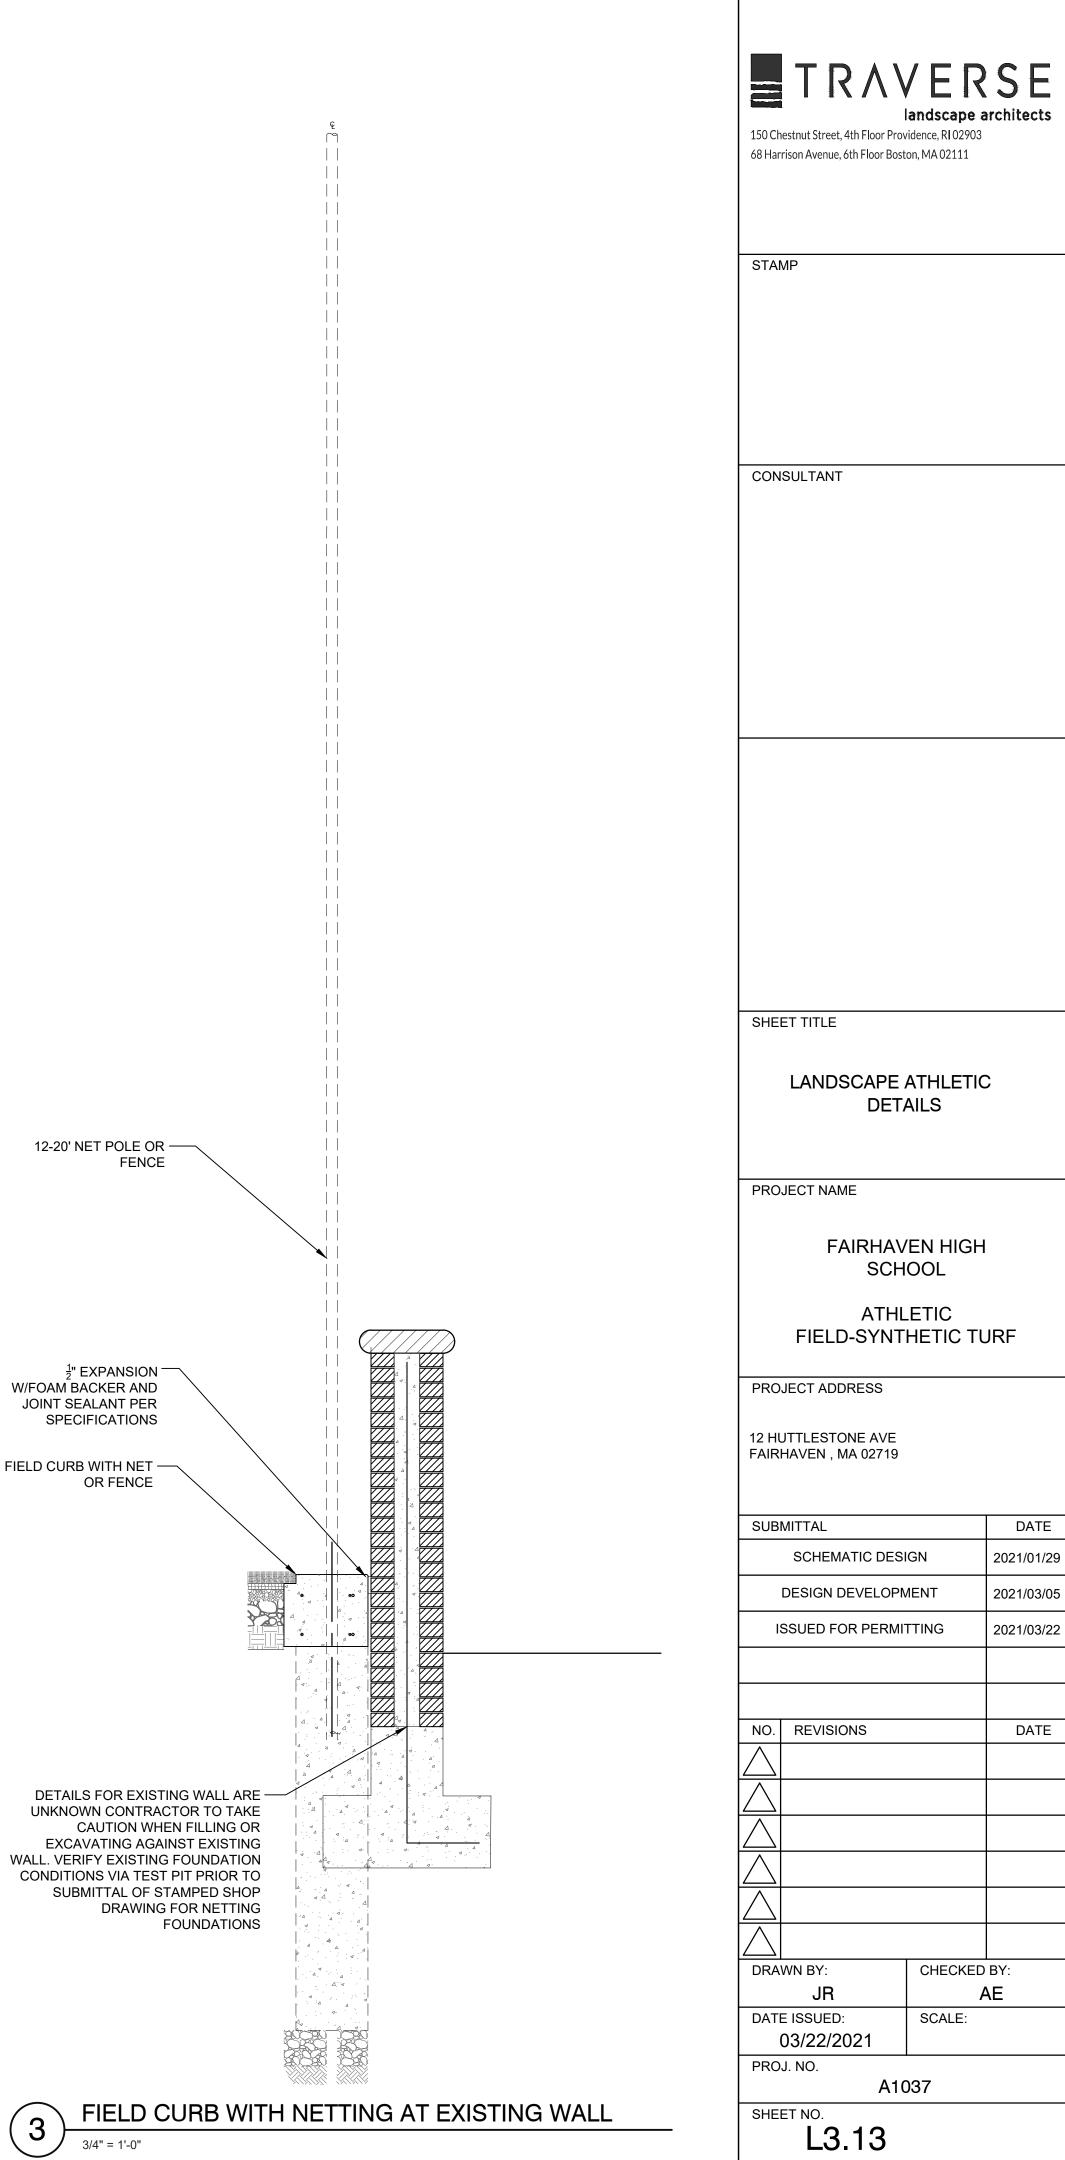

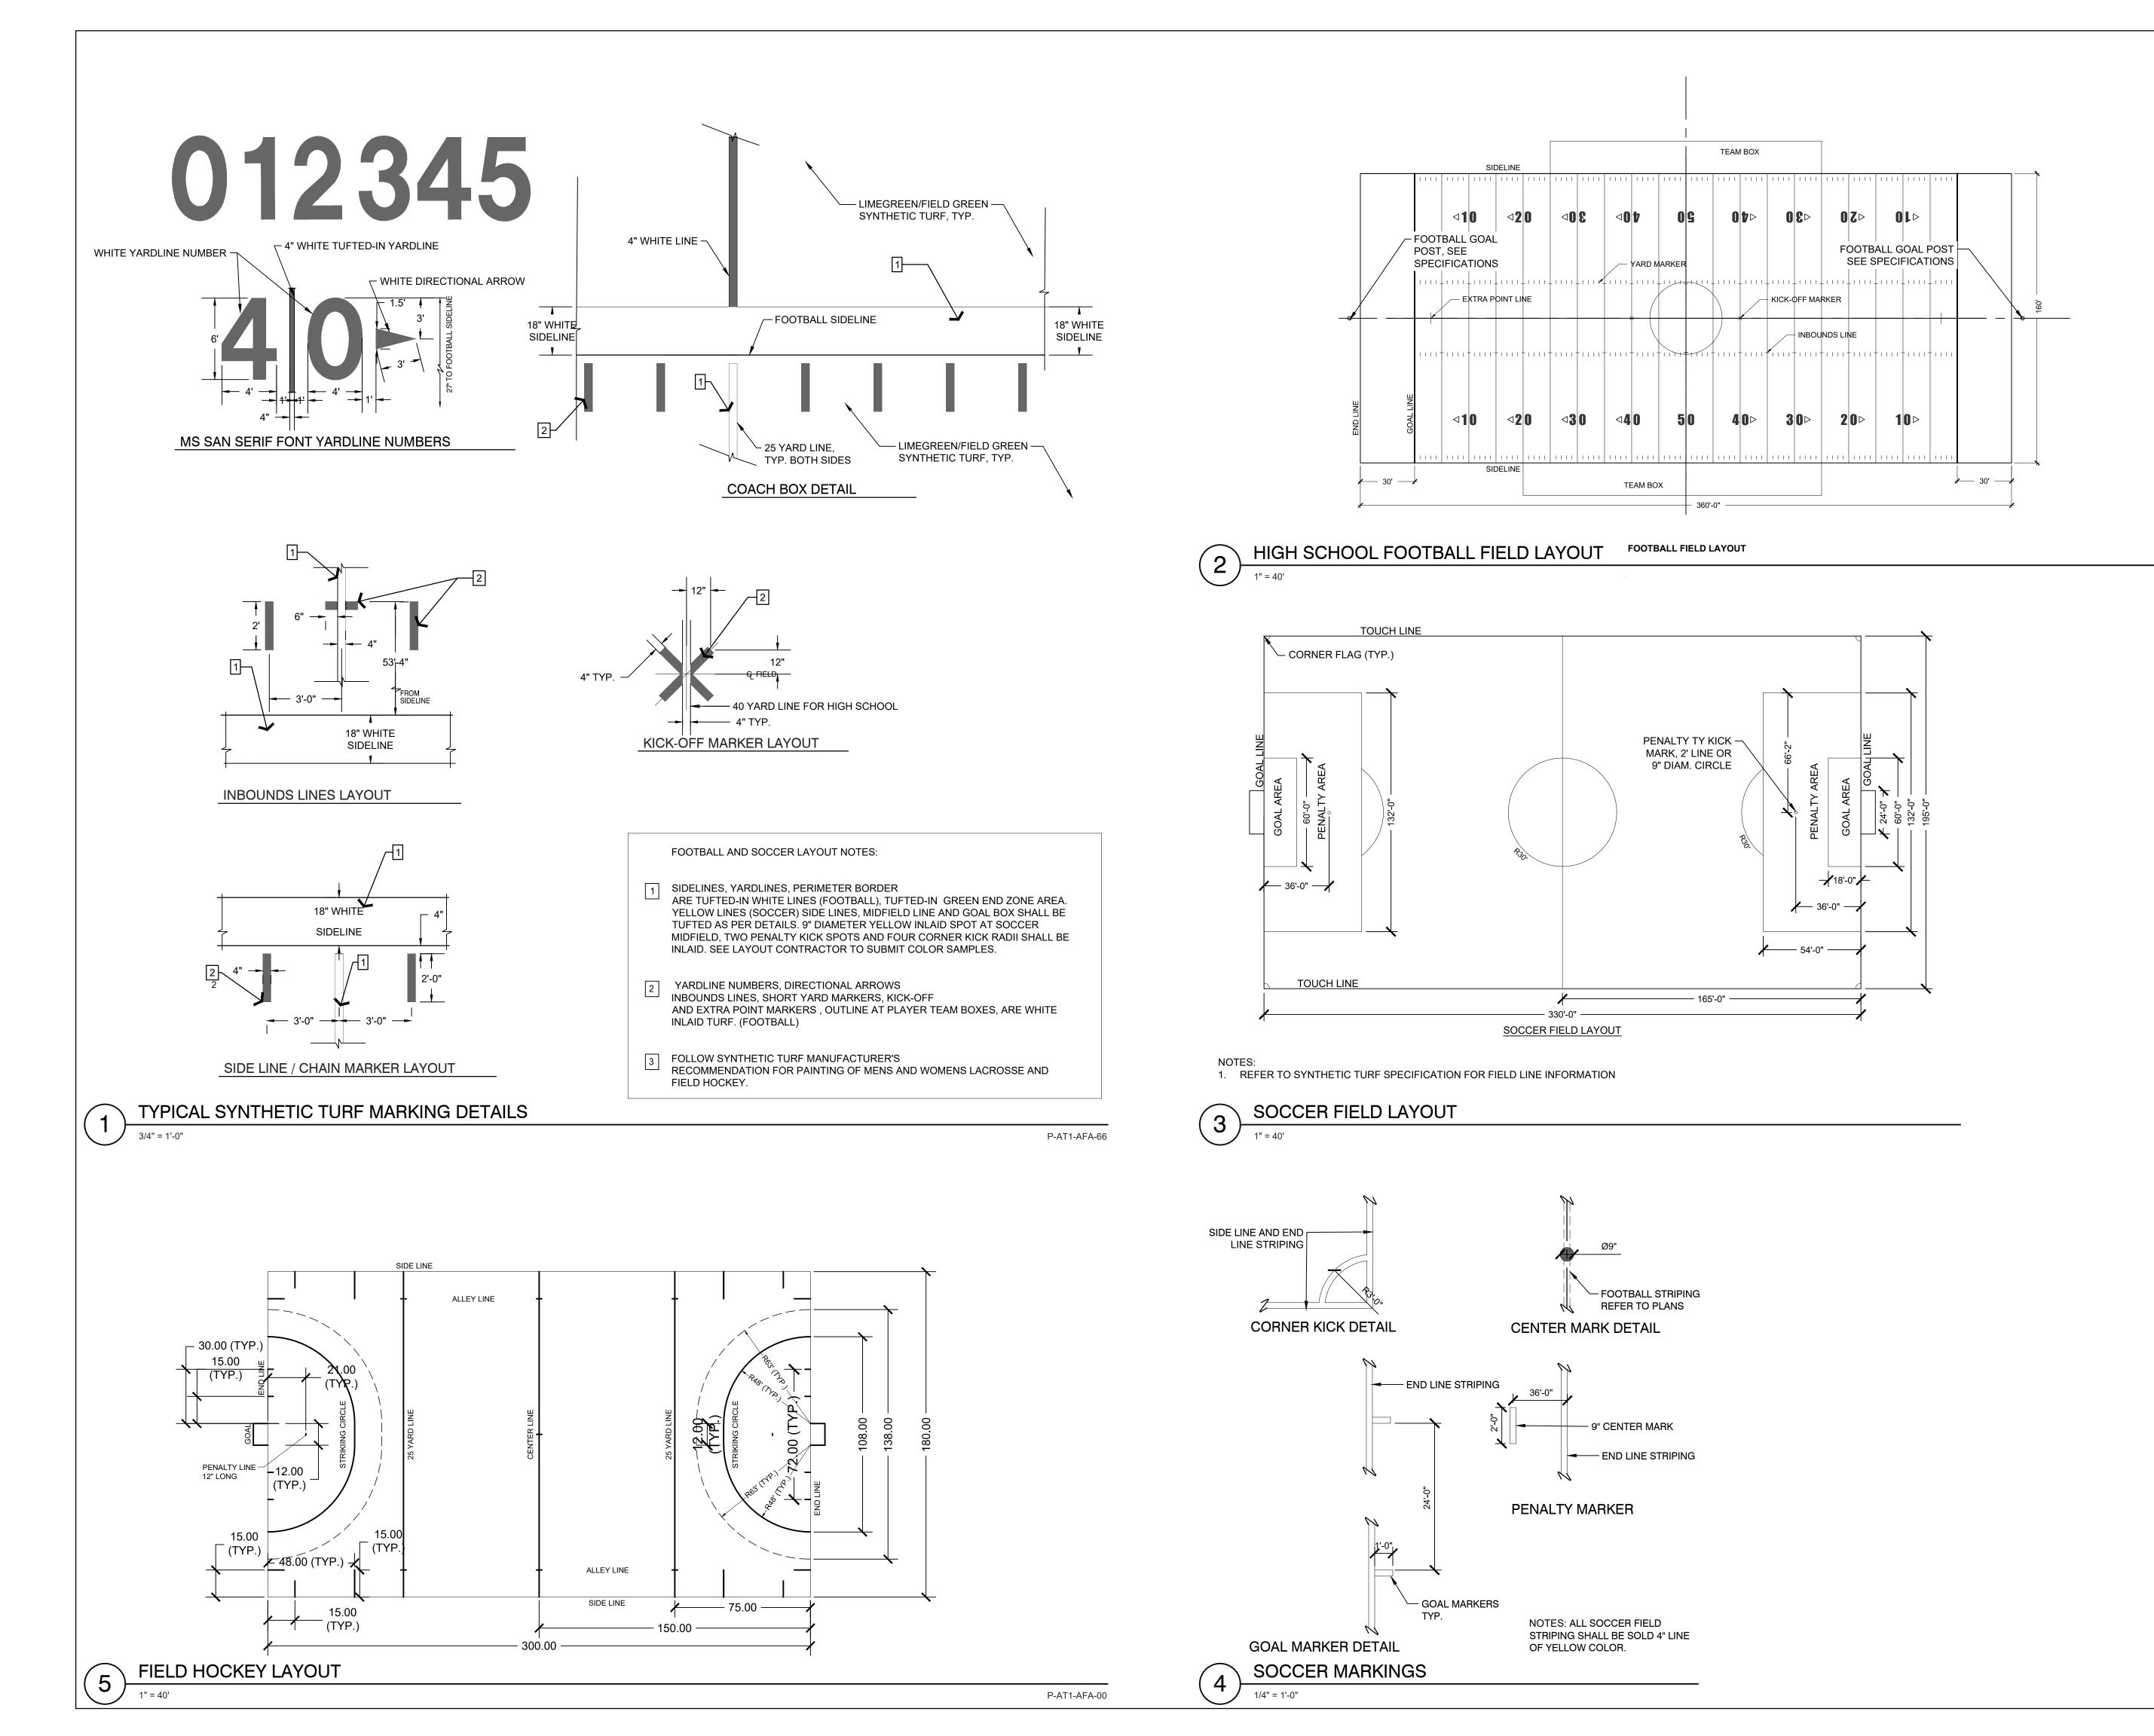

P-AT1-AFA-94

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|---|---|----------|-----|------|------|-------|------|
|   |   |          | lan | dsca | pe a | rchit | ects |

150 Chestnut Street, 4th Floor Providence, RI 02903 68 Harrison Avenue, 6th Floor Boston, MA 02111

STAMP

CONSULTANT

SHEET TITLE

### LANDSCAPE ATHLETIC DETAILS

PROJECT NAME

FAIRHAVEN HIGH SCHOOL


ATHLETIC FIELD-SYNTHETIC TURF


PROJECT ADDRESS

12 HUTTLESTONE AVE FAIRHAVEN , MA 02719

SUBMITTAL

DATE SCHEMATIC DESIGN 2021/01/29 DESIGN DEVELOPMENT 2021/03/05

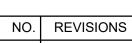

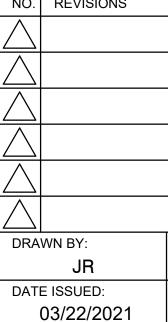

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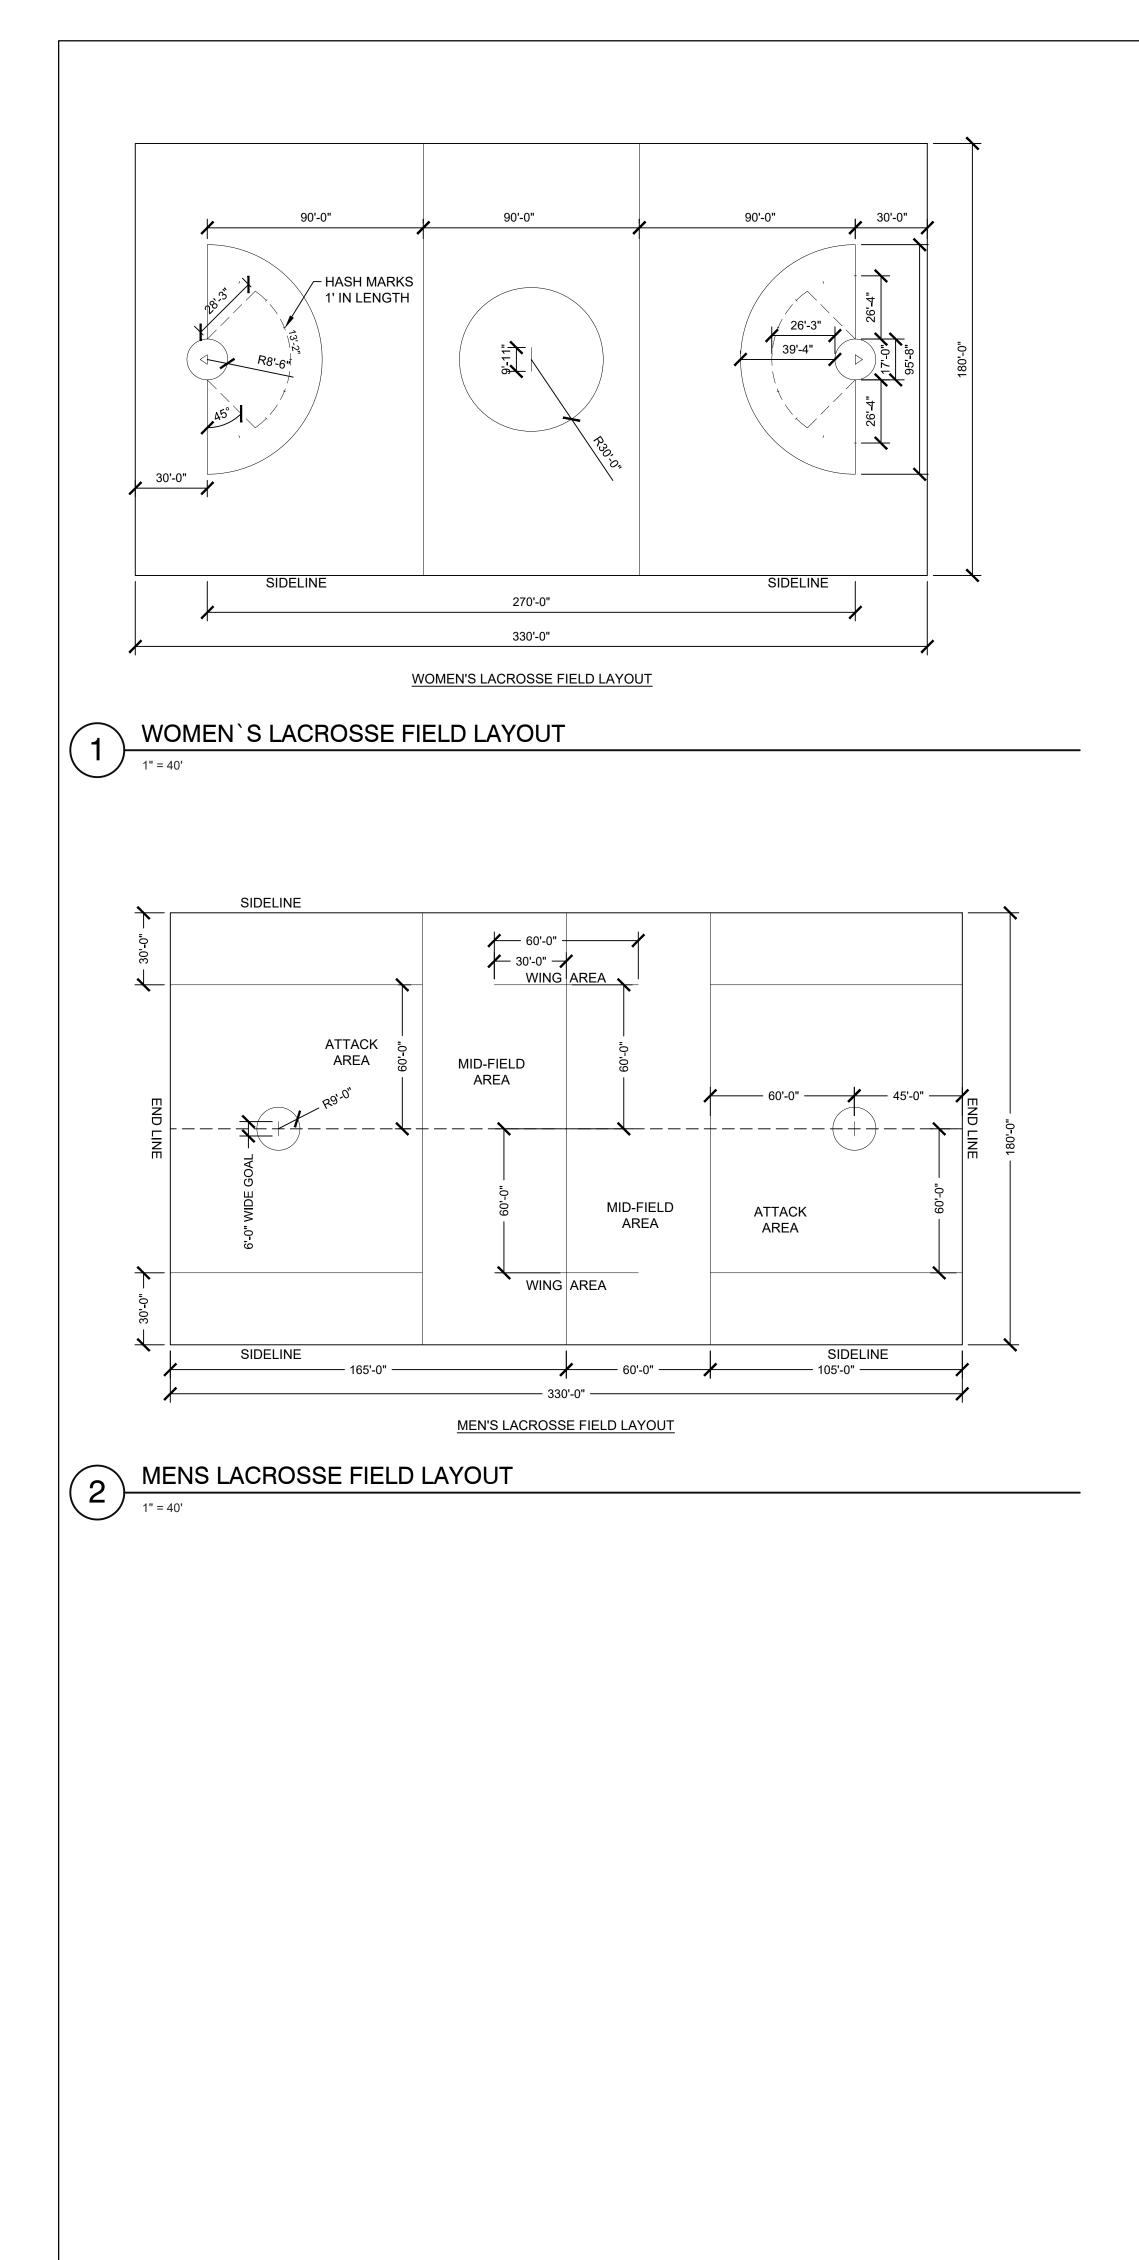
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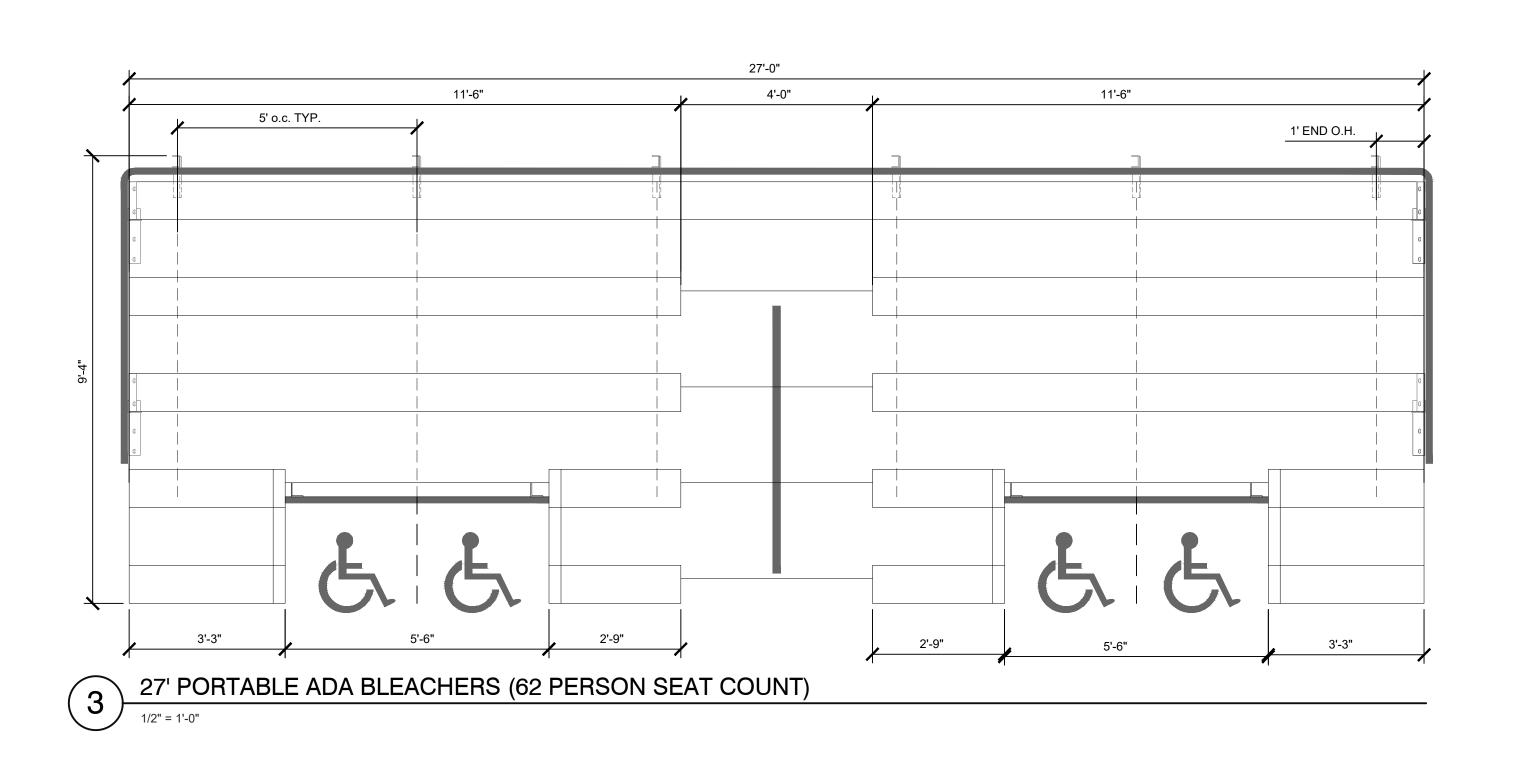
A1037

DATE


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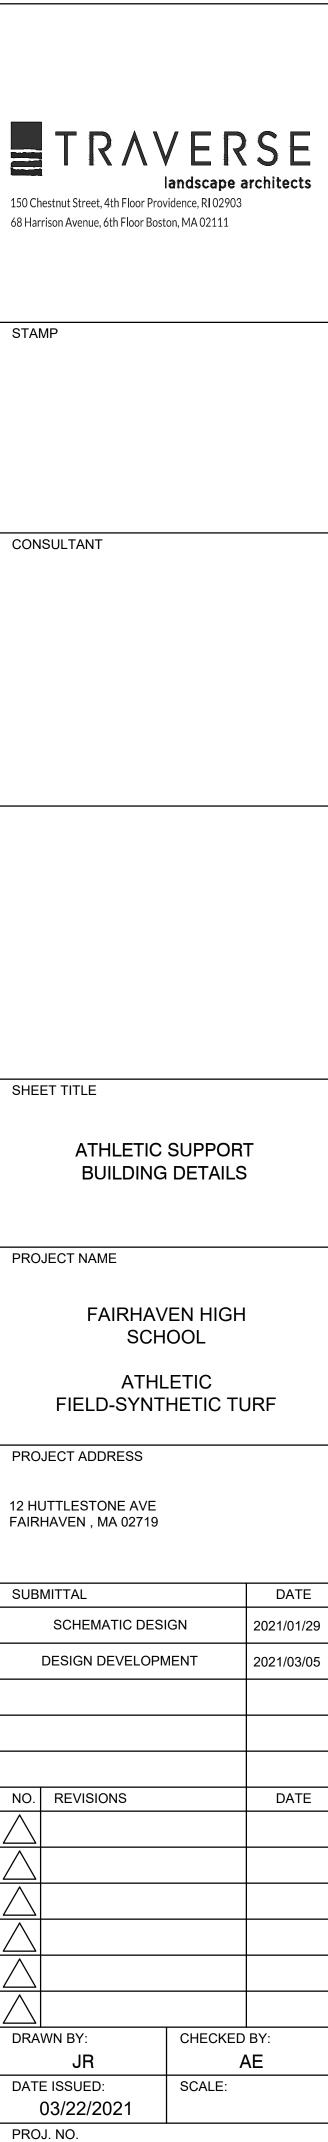
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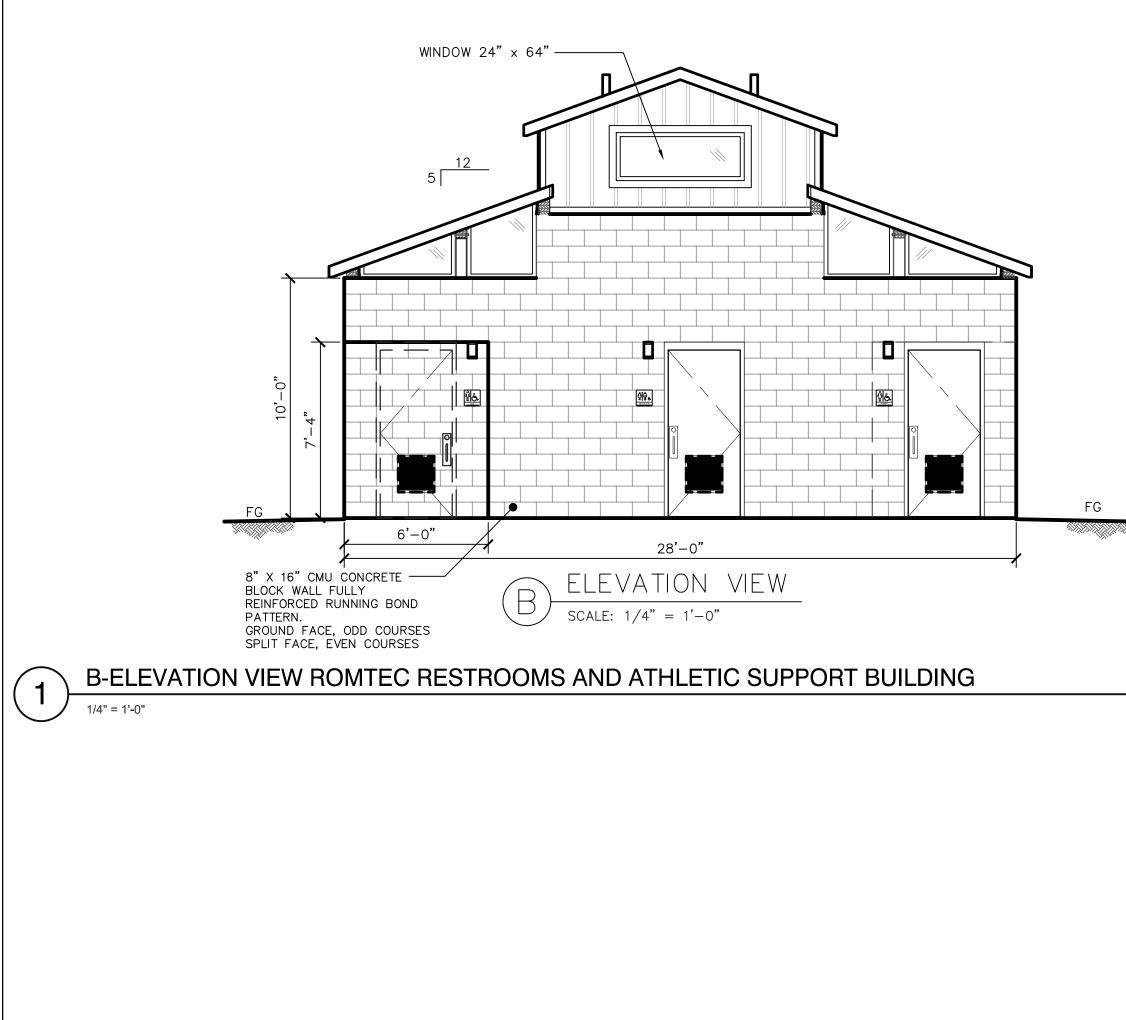





L3.21 ATHLETIC SUPPORT BUILDING DETAILS

A1037

SHEET NO.

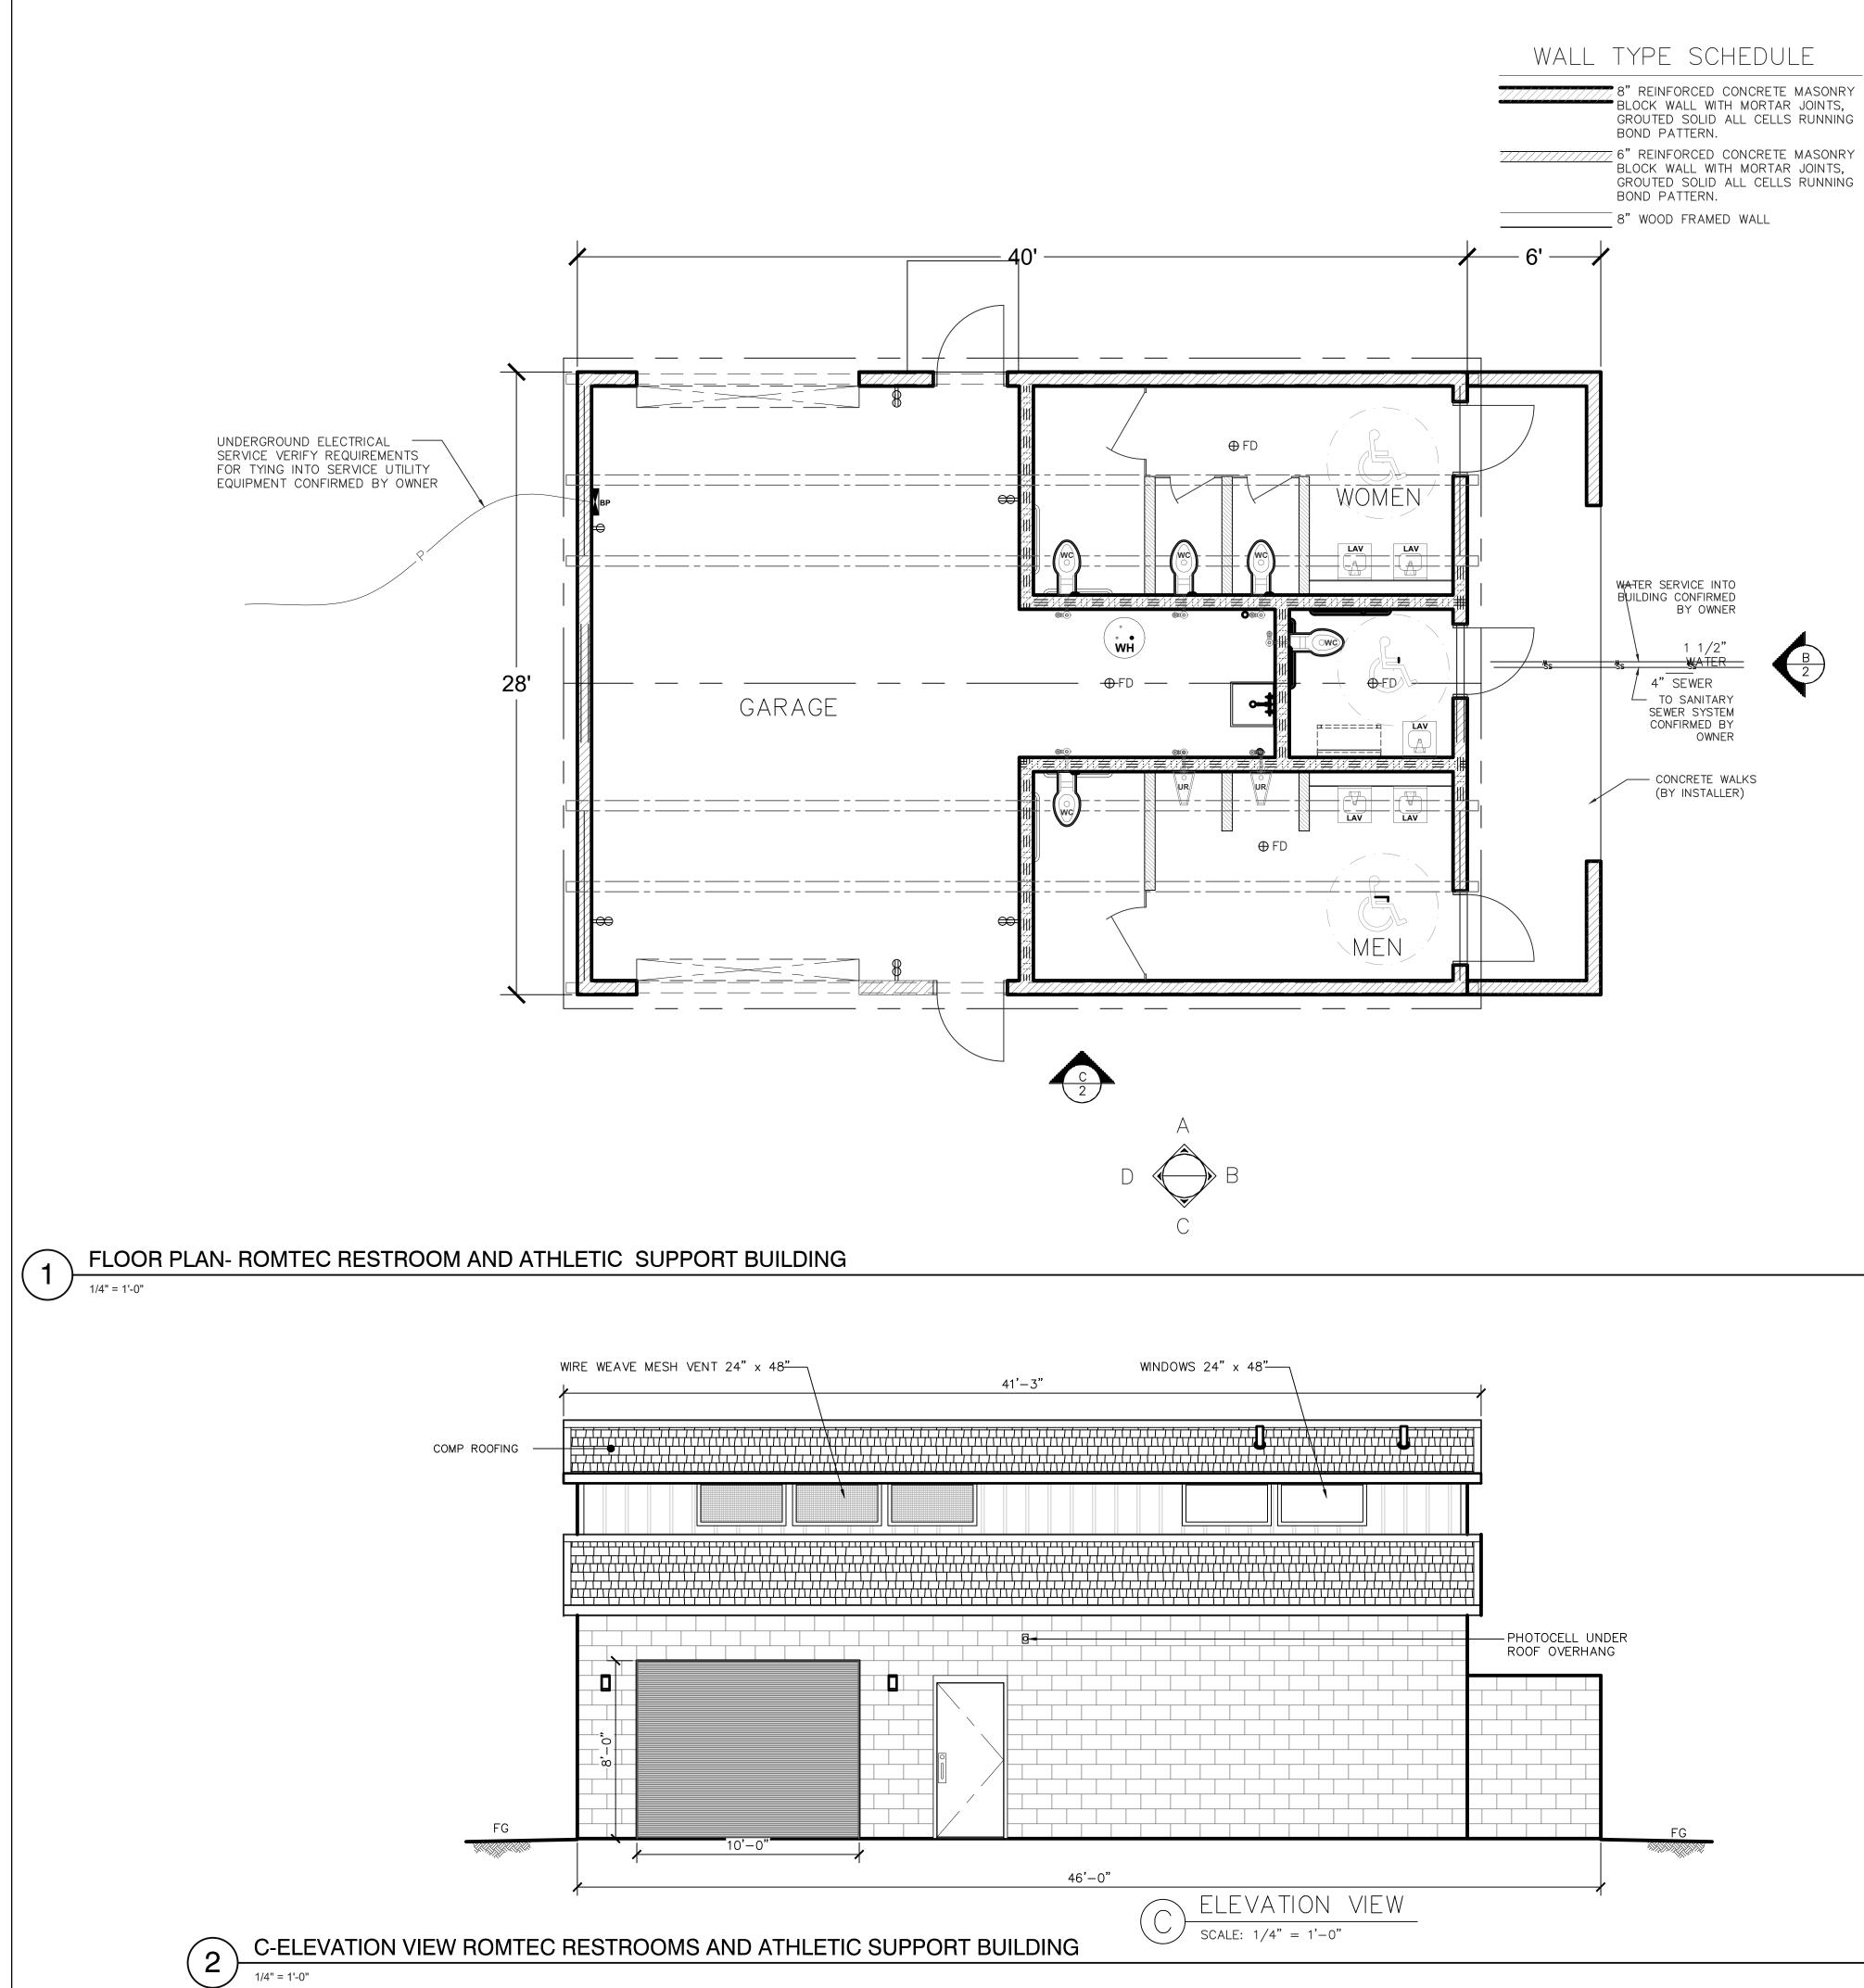

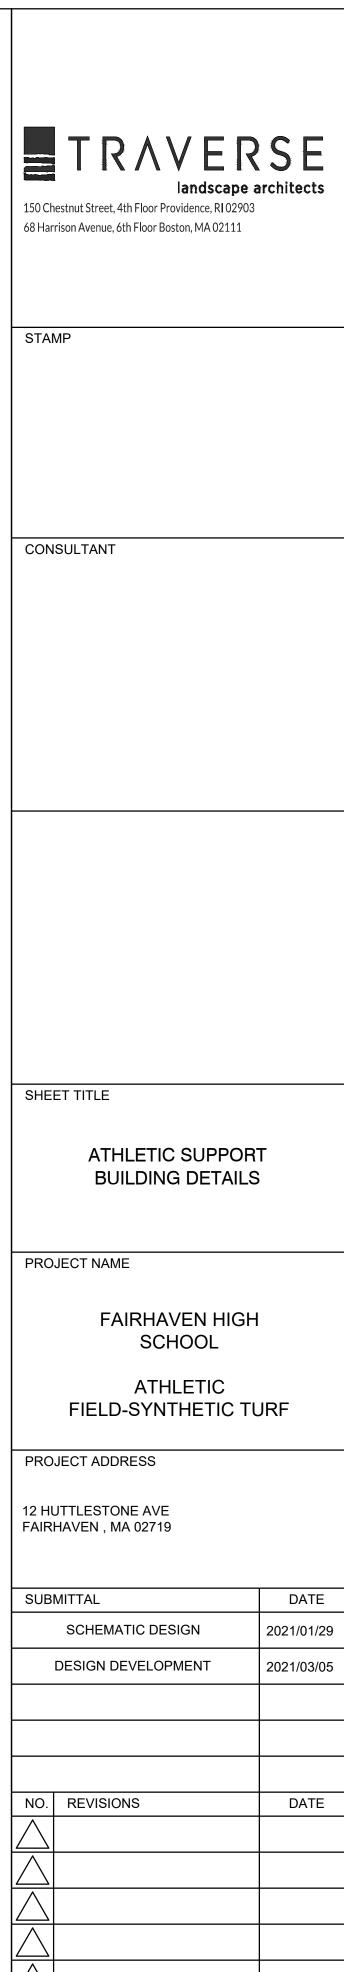

SHEET TITLE

PROJECT NAME

PROJECT ADDRESS

12 HUTTLESTONE AVE FAIRHAVEN , MA 02719

SUBMITTAL

SCHEMATIC DESIGN DESIGN DEVELOPMENT


NO. REVISIONS

 $\wedge$  $\wedge$  $\wedge$  $\wedge$  $\wedge$ DRAWN BY: JR DATE ISSUED: 03/22/2021 PROJ. NO. A1037

SHEET NO.

ATHLETIC SUPPORT BUILDING DETAILS


L3.22

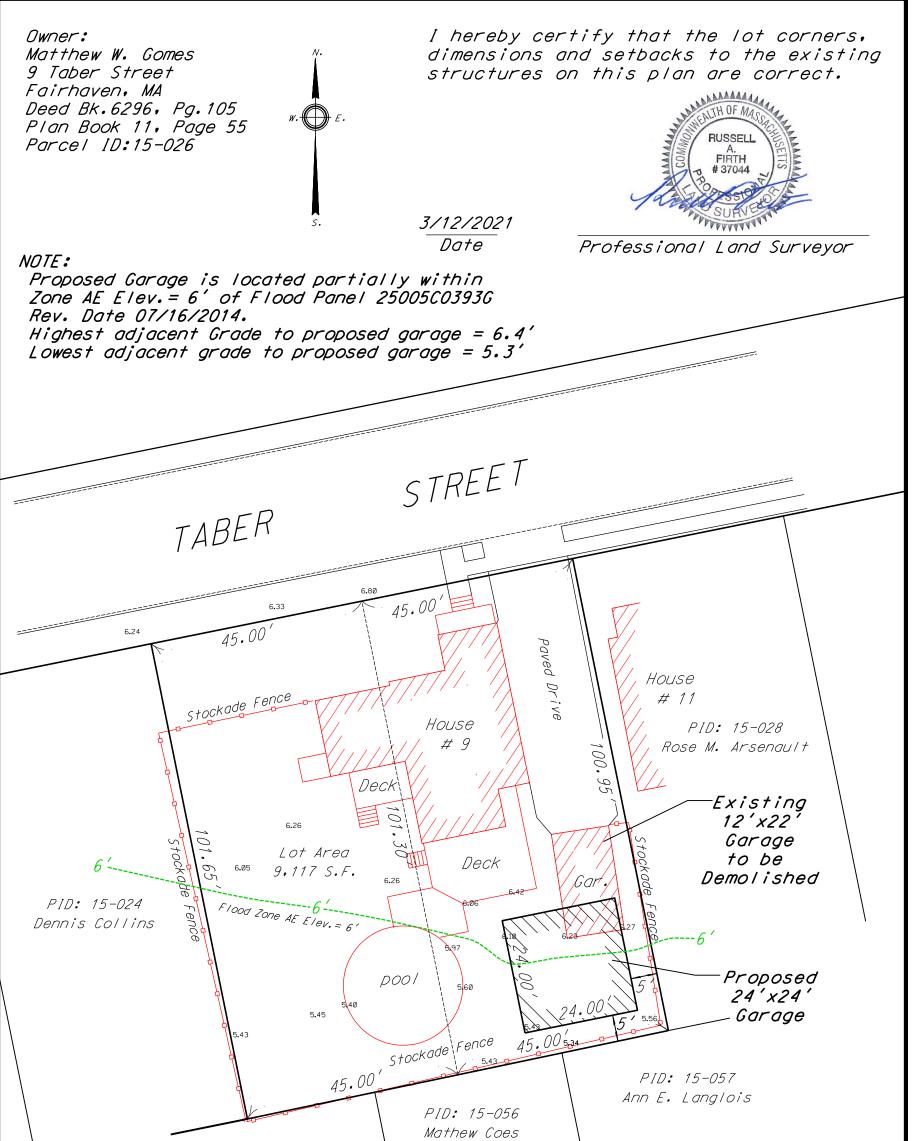


PID: 15-054 John L. Fournier and Sara T. Salem

SITE PLAN IN FAIRHAVEN, MASSACHUSETTS PREPARED FOR Motthew W. Gomes SCALE: 20 feet to an inch March 12, 2021 American Land Surveys 3 Sunset Lane Fairhaven, Massachusetts Zone: Single Residence District (RA) Setbacks: Front 20' Side 10' Rear 30' Accessory Structure 5' setback




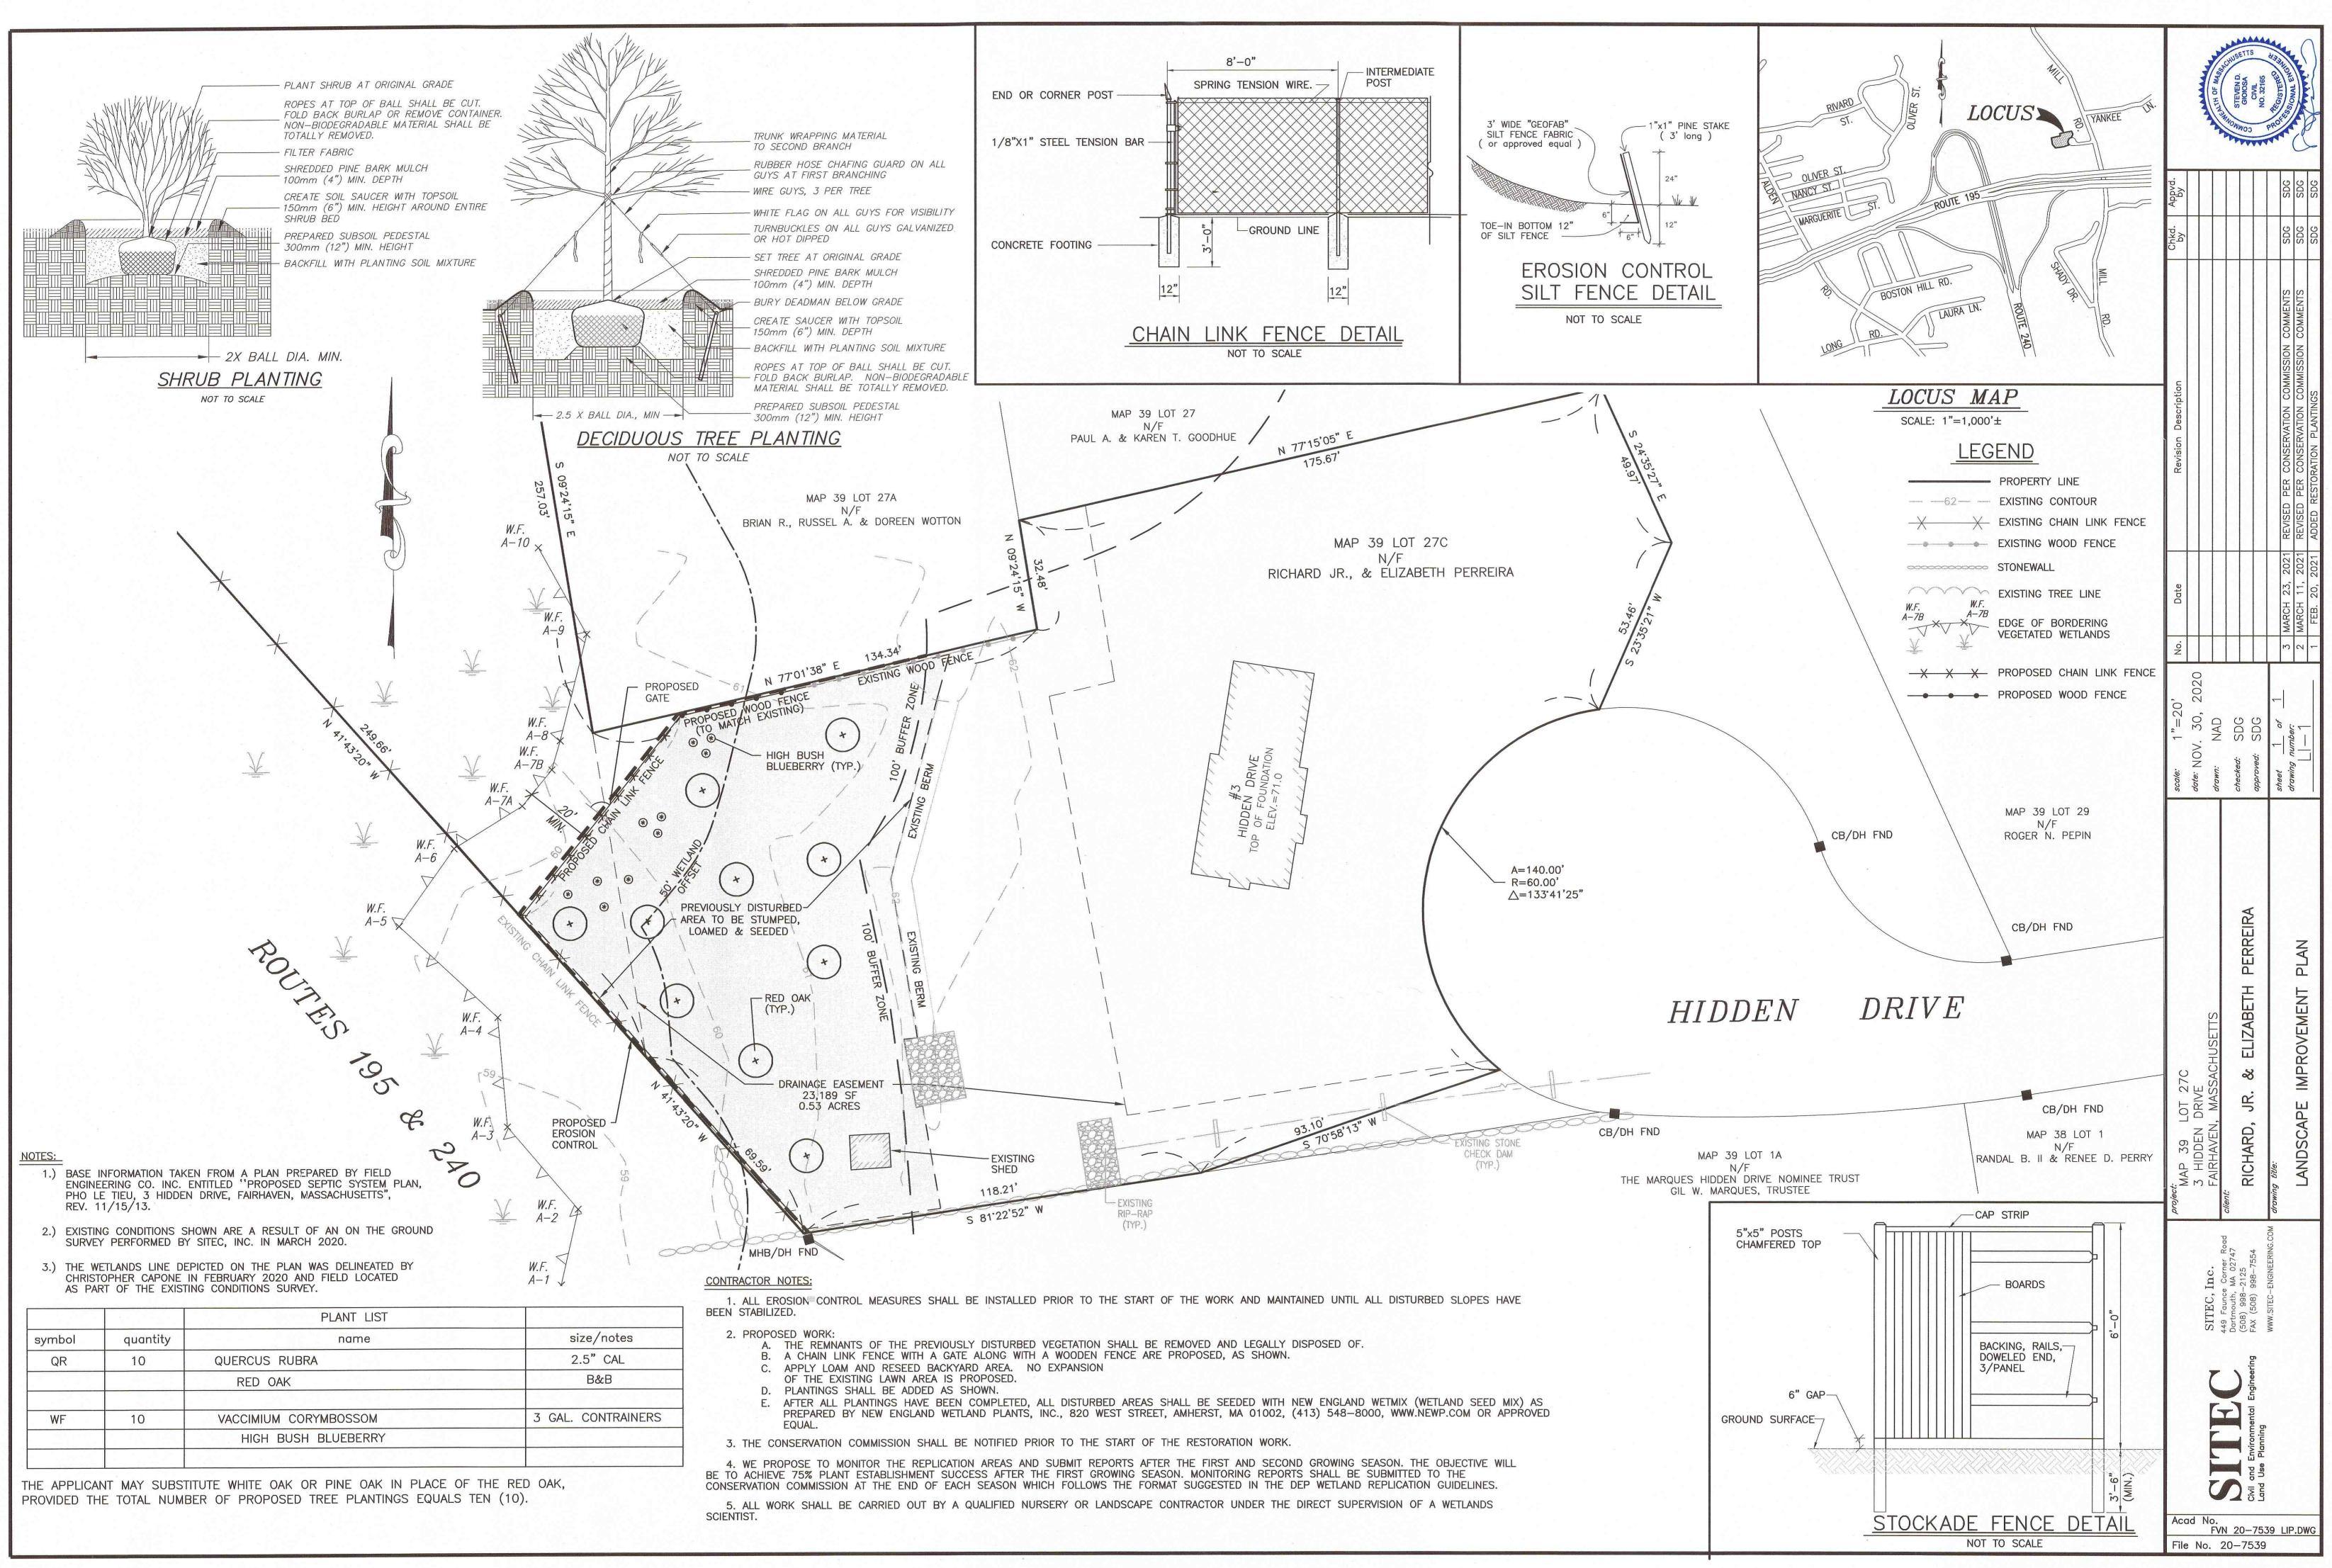

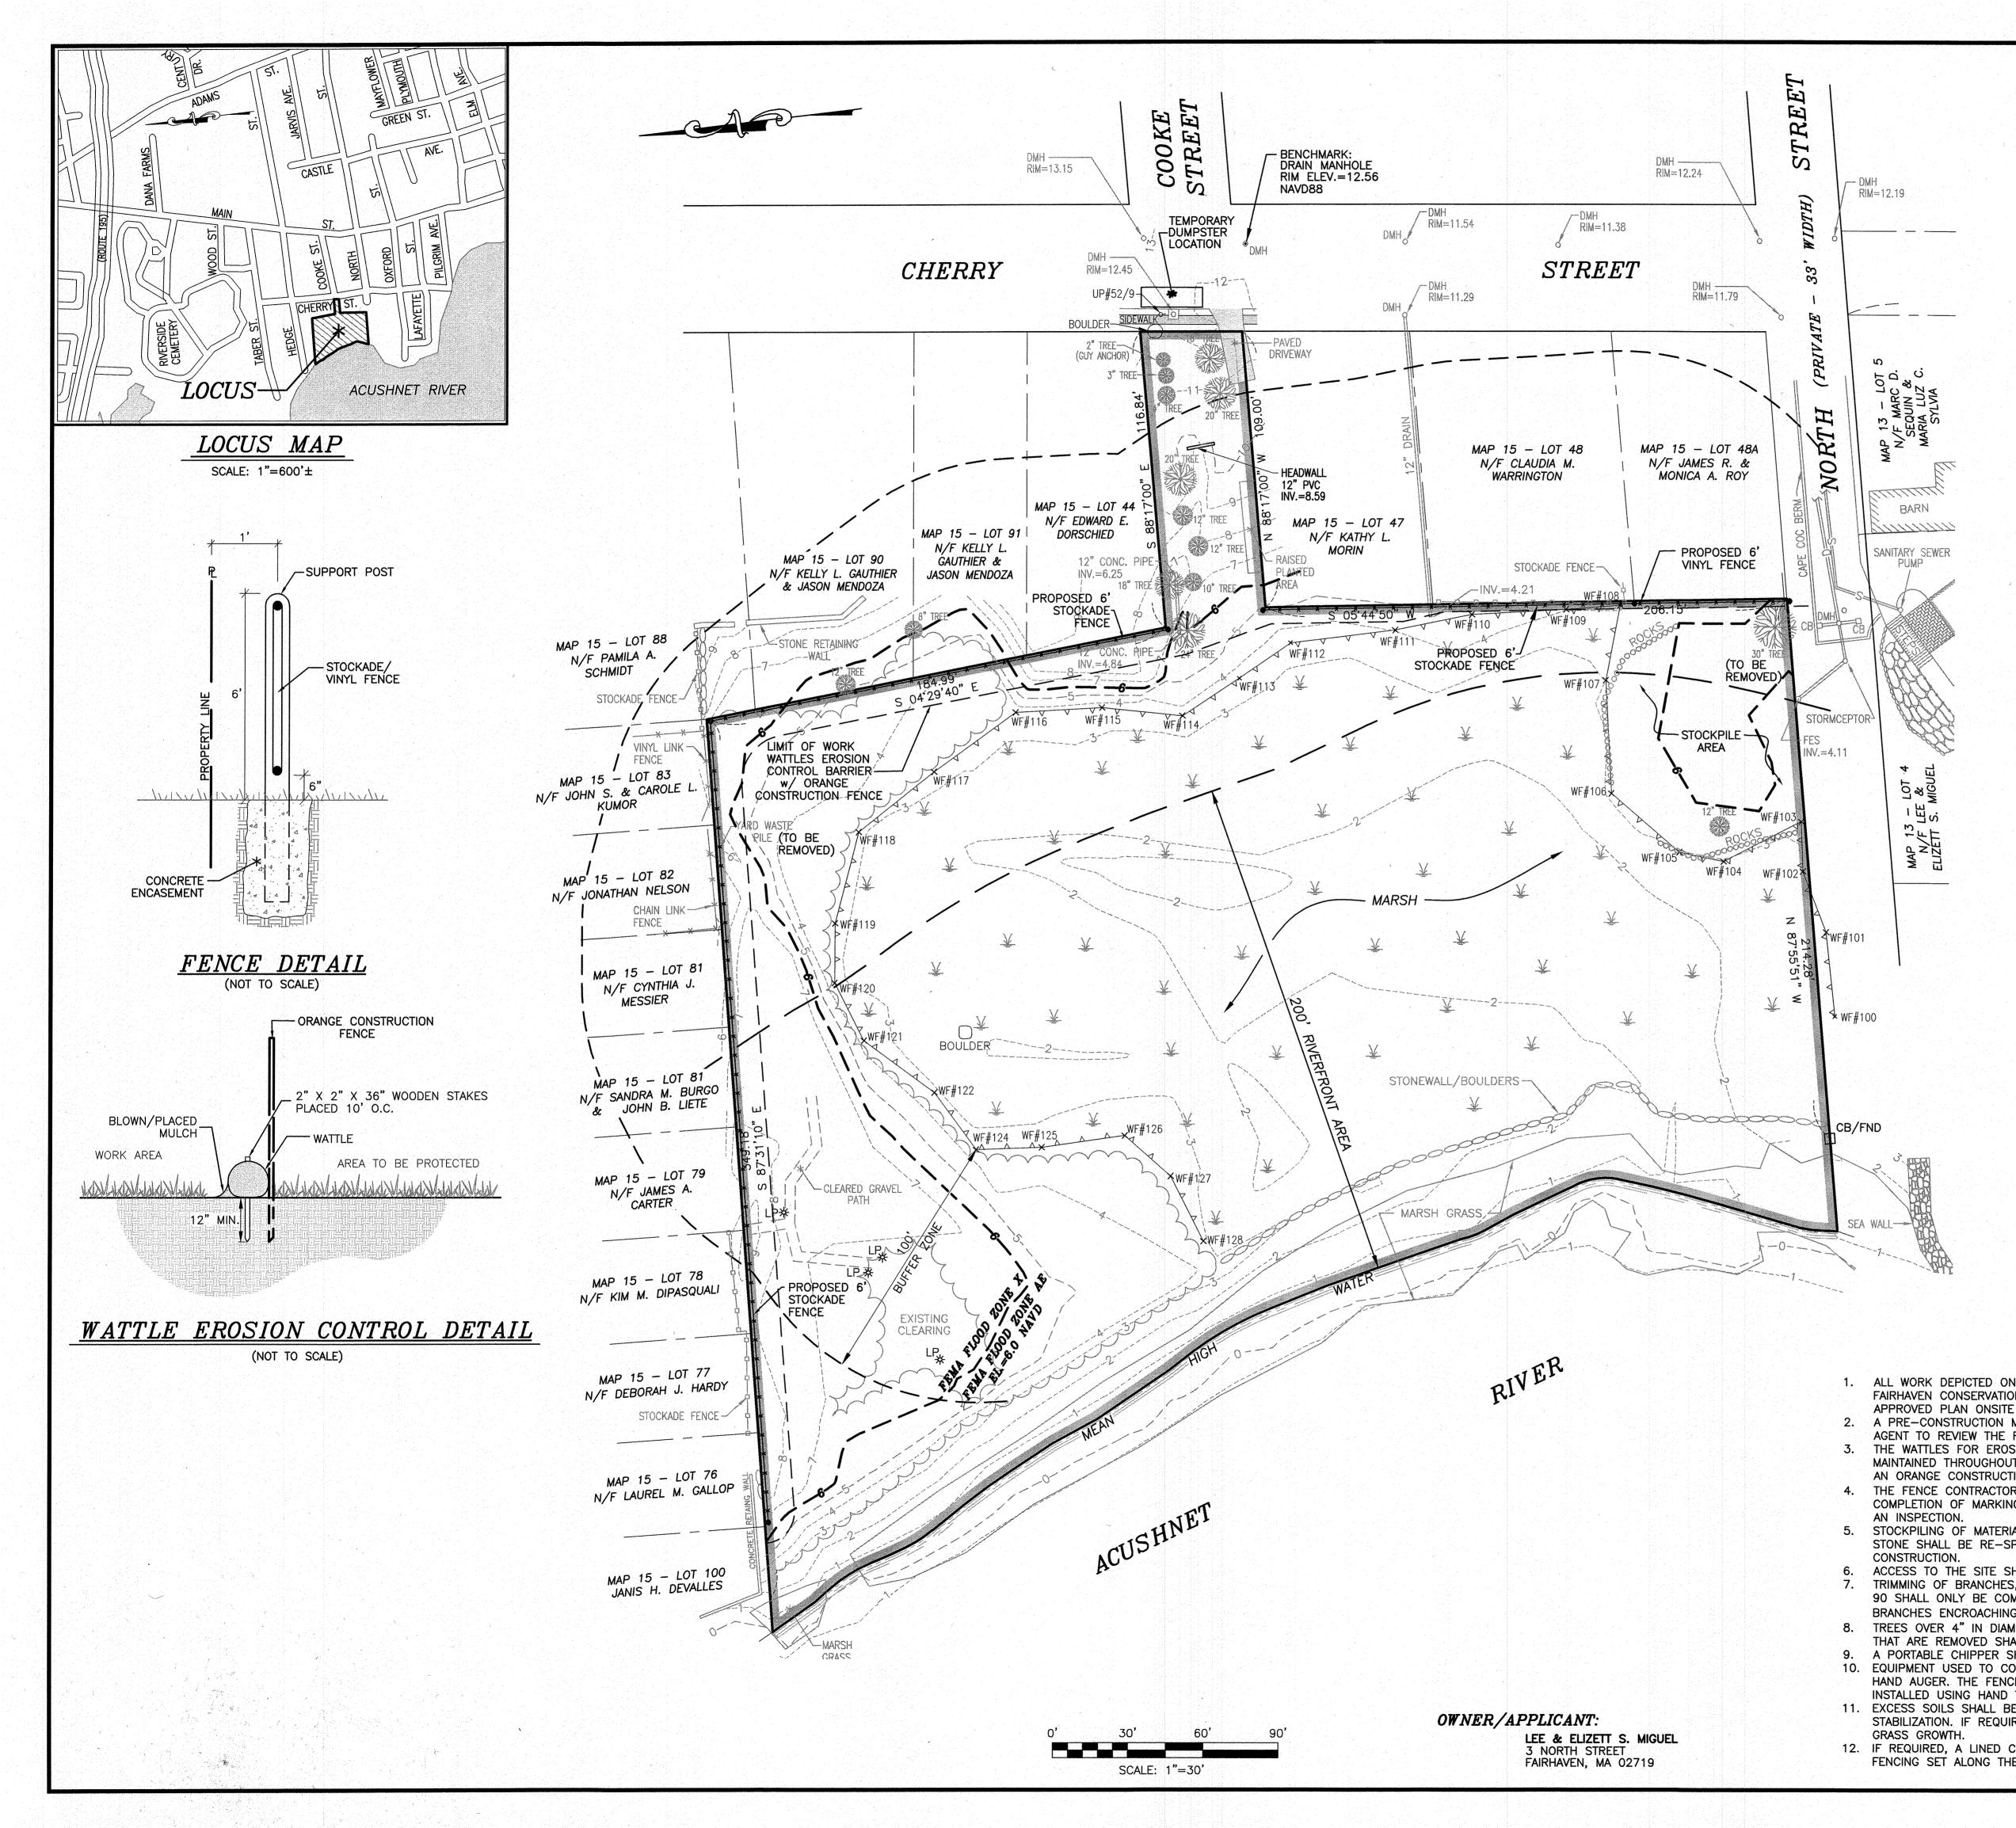

|  |                       |   |                         |  |                       |                    | H         | 2                          |
|--|-----------------------|---|-------------------------|--|-----------------------|--------------------|-----------|----------------------------|
|  | 6                     | PROPERTY LINE<br>EXISTING CONTOUR   | Appvd.<br>by            |  |                       | SDC                | SDC       | SDG                        |
|  |                       | STONEWALL<br>SEWER LINE   | Chkd.<br>by             |  |                       | SDG                | SDC       | SDG                        |
|  | D<br>CB               | DRAINAGE LINE<br>CATCH BASIN  |                         |  |                       |                    |           | _                          |
|  | DMH <sub>o</sub>      | DRAIN MANHOLE   |                         |  |                       |                    | ULIN      | NIS                        |
|  | SMHo                  | SEWER MANHOLE   |                         |  |                       |                    |           | COMMISSION COMMENTS        |
|  | UP_0-                 | UTILITY POLE  | c                       |  |                       |                    |           | N<br>N                     |
|  | LP<br>*               | LAMP POST   | Description             |  |                       |                    |           | MISSIC                     |
|  | <del>-x x x x x</del> | CHAIN LINK FENCE  | Desc                    |  |                       |                    |           | COM                        |
|  | ·DDDD-                | STOCKADE FENCE  | sion                    |  |                       | DTES               | INCE      | VIION                      |
|  |                       | TREE LINE/BRUSH LINE  | Revision                |  |                       | CONSTRUCTION NOTES | OF FENCE  | REVISIONS PER CONSERVATION |
|  |                       | TREE  |                         |  |                       | RUCTION            | NOL       | CUN                        |
|  | WF#111 WF#112         | EDGE OF BORDERING   |                         |  |                       | FY CONSTRUCTION    | PORTION   | 꾸                          |
|  | XXXX                  | VEGETATED WETLANDS  |                         |  |                       | FY C               | ELIMINATE | SIUNS                      |
|  |                       |   |                         |  |                       | ADD CO             | ELIM      | KEVI                       |
|  |                       |   |                         |  |                       | 1                  | 000       | 20                         |
|  |                       |   |                         |  |                       |                    | 2020      |                            |
|  |                       |   |                         |  |                       | 15,<br>26          | 28,       |                            |
|  |                       |   | Date                    |  |                       | MARCH<br>FEBRUARY  | DECEMBER  | DECEMBER                   |
|  |                       |   |                         |  |                       | MA                 | DECE      | UELE                       |
|  |                       |   |                         |  |                       |                    |           |                            |
|  |                       |   | °.<br>S                 |  |                       | 4 M                |           | _                          |
|  |                       |   | Ő                       |  |                       |                    |           |                            |
|  |                       |   | 30'<br>2020             |  |                       | <b>-</b>           |           |                            |
|  |                       |   | 1"=30'<br>2, 20         | KJ<br>SDG  | SDG                   | of                 |           |                            |
|  |                       |   |                         |  |                       | -                  |           |                            |
|  |                       |   | scale:<br>dote: JULY    | drawn:<br>checked:                                   | approved:             |                    |           |                            |
|  |                       |   | scale:<br>date:         | drawn.<br>checke                                     | dda                   | sheet              | 20        |                            |
|  |                       |   |                         |  |                       |                    | an Asy    |                            |
|  |                       |   |                         |  |                       |                    |           |                            |
|  |                       |   |                         |  |                       |                    |           |                            |
|  |                       |   |                         |  |                       | a<br>Ar a          |           |                            |
|  |                       |   |                         |  |                       |                    |           |                            |
|  |                       |   |                         |  |                       |                    |           |                            |
|  |                       |   |                         |  |                       |                    |           |                            |
|  |                       |   |                         |  |                       |                    |           |                            |
|  |                       |   | 3<br>STREE              | Ī  |                       |                    |           |                            |
|  |                       |   | 4 () (                  | n c  | 5                     |                    |           |                            |
|  |                       |   | LOT                     |  | าวาพ                  |                    |           |                            |
|  |                       |   |                         |  |                       |                    |           |                            |
|  |                       |   | P 15, LOT<br>/ CHERRY   |  | ц<br>Ц                |                    |           |                            |
|  |                       |   | MAP<br>ET /             |  |                       |                    |           |                            |
|  |                       |   | SR                      | ∑lī  | มี                    |                    | Z         |                            |
|  |                       |   | A La                    |  | ช                     |                    | PLAN      |                            |
|  |                       |   | SSESS<br>ORTH           | I IA   | 1                     |                    |           | I                          |
| and a start of the second s<br>Second second |                       |   | $\cdot \triangleleft Z$ |  |                       | r title            | SITE      | I                          |
|  | ICTION NOTE           | <b>'S</b><br>R of conditions issued by the  | project:<br>P           | client:  | -                     | drawing title.     | ~ •       |                            |
|  | CONTRACTOR SHAL       | LL HAVE A COPY OF THE ORDER AND   | à                       | 72   | 5 6 5<br>1 1 1        |                    |           | _                          |
| MEETING WILL BE SCH  | EDULED BY THE         | CONTRACTOR WITH THE CONSERVATION  |                         | Road<br>47   |                       | -ENGINEEKING.COM   |           |                            |
| REQUIREMENTS OUTLIN  |                       | R OF CONDITIONS.<br>D THE START OF CONSTRUCTION AND   |                         | 27   | -7554                 |                    |           |                            |
| UT THE CONSTRUCTION<br>TION FENCE SHALL BE   |                       | ALL DISTURBED AREAS ARE STABILIZED.   |                         | • Corner<br>MA 027<br>2125                           | 998-                  | -ENGIN             |           |                            |
| OR SHALL MARK ANY T  | REES OVER 4" DI       | AMETER PRIOR TO CLEARING. UPON  | С<br>F                  | -aunco<br>-aunco<br>nouth,<br>998,                   | (508)                 |                    |           |                            |
|  |                       | CONSERVATION OFFICE TO SCHEDULE   | STRO                    | 449 Faunce Corr<br>Dartmouth, MA 0<br>(508) 998-2125 | FAX (                 | WWW.SHEC           |           |                            |
|  |                       | ATED UPLAND AREA. CLEAN CRUSHED<br>THE CONCLUSION OF THE  |                         |  |                       |                    |           |                            |
| SHALL BE THROUGH TH  |                       | · 문화 전에 가지 않는 것 같은 것 같이 많이 많다.  |                         | <b>r</b> .   | sering                |                    |           | 1                          |
| S, AS NEEDED, FROM   | THE TREE LOCATE       | ED ON THE BOUNDARY AT MAP 15-LOT<br>RIMMING SHALL BE LIMITED TO   |                         | J  | Engineering           |                    |           | l                          |
| IG ON APPLICANT'S PR   | OPERTY TO THE I       | EXTENT NEEDED TO INSTALL THE FENCE.   |                         | $\overline{G}$                                       | ntal E                |                    |           | I                          |
| METER SHALL NOT BE   | REMOVED UNLESS        | S DIRECTLY ON FENCE LINE. ANY TREES<br>ESS OR APPROVED EQUAL.   |                         |  |                       |                    |           |                            |
| SHALL BE USED TO CR  | REATE MULCH FRO       | DM MATERIAL CUT IN THE WORK ZONE.   |                         |  | Environme<br>Planning |                    |           | I                          |
| CE ALONG THE WEST I  | LINE OF LOTS 47,      | , 48, 48A, AS SHOWN, SHALL BE   |                         |  | and<br>Use            |                    |           | l                          |
|  | FENCE POSTS, AN       | ND THE AREA SEEDED FOR  |                         | 5  | Civil                 |                    |           | l                          |
|  |                       | H ORGANIC TOPSOIL TO FACILITATE   |                         |  |                       |                    |           |                            |
| CONCRETE WASHOUT P   |                       | IN THE STOCKPILE AREA WITH SILT   | Acad N                  |  |                       | 10 0-              |           |                            |
|  | INCIEN OF INE F       |   | File No.                | FVN 18   |                       | ⊻ SF               | .DWG      | 1                          |
| and the second   |                       | n - Andrew Charles and a start of the start of |                         |  |                       |                    | 1.6.1.211 |                            |

<u>LEGEND</u>

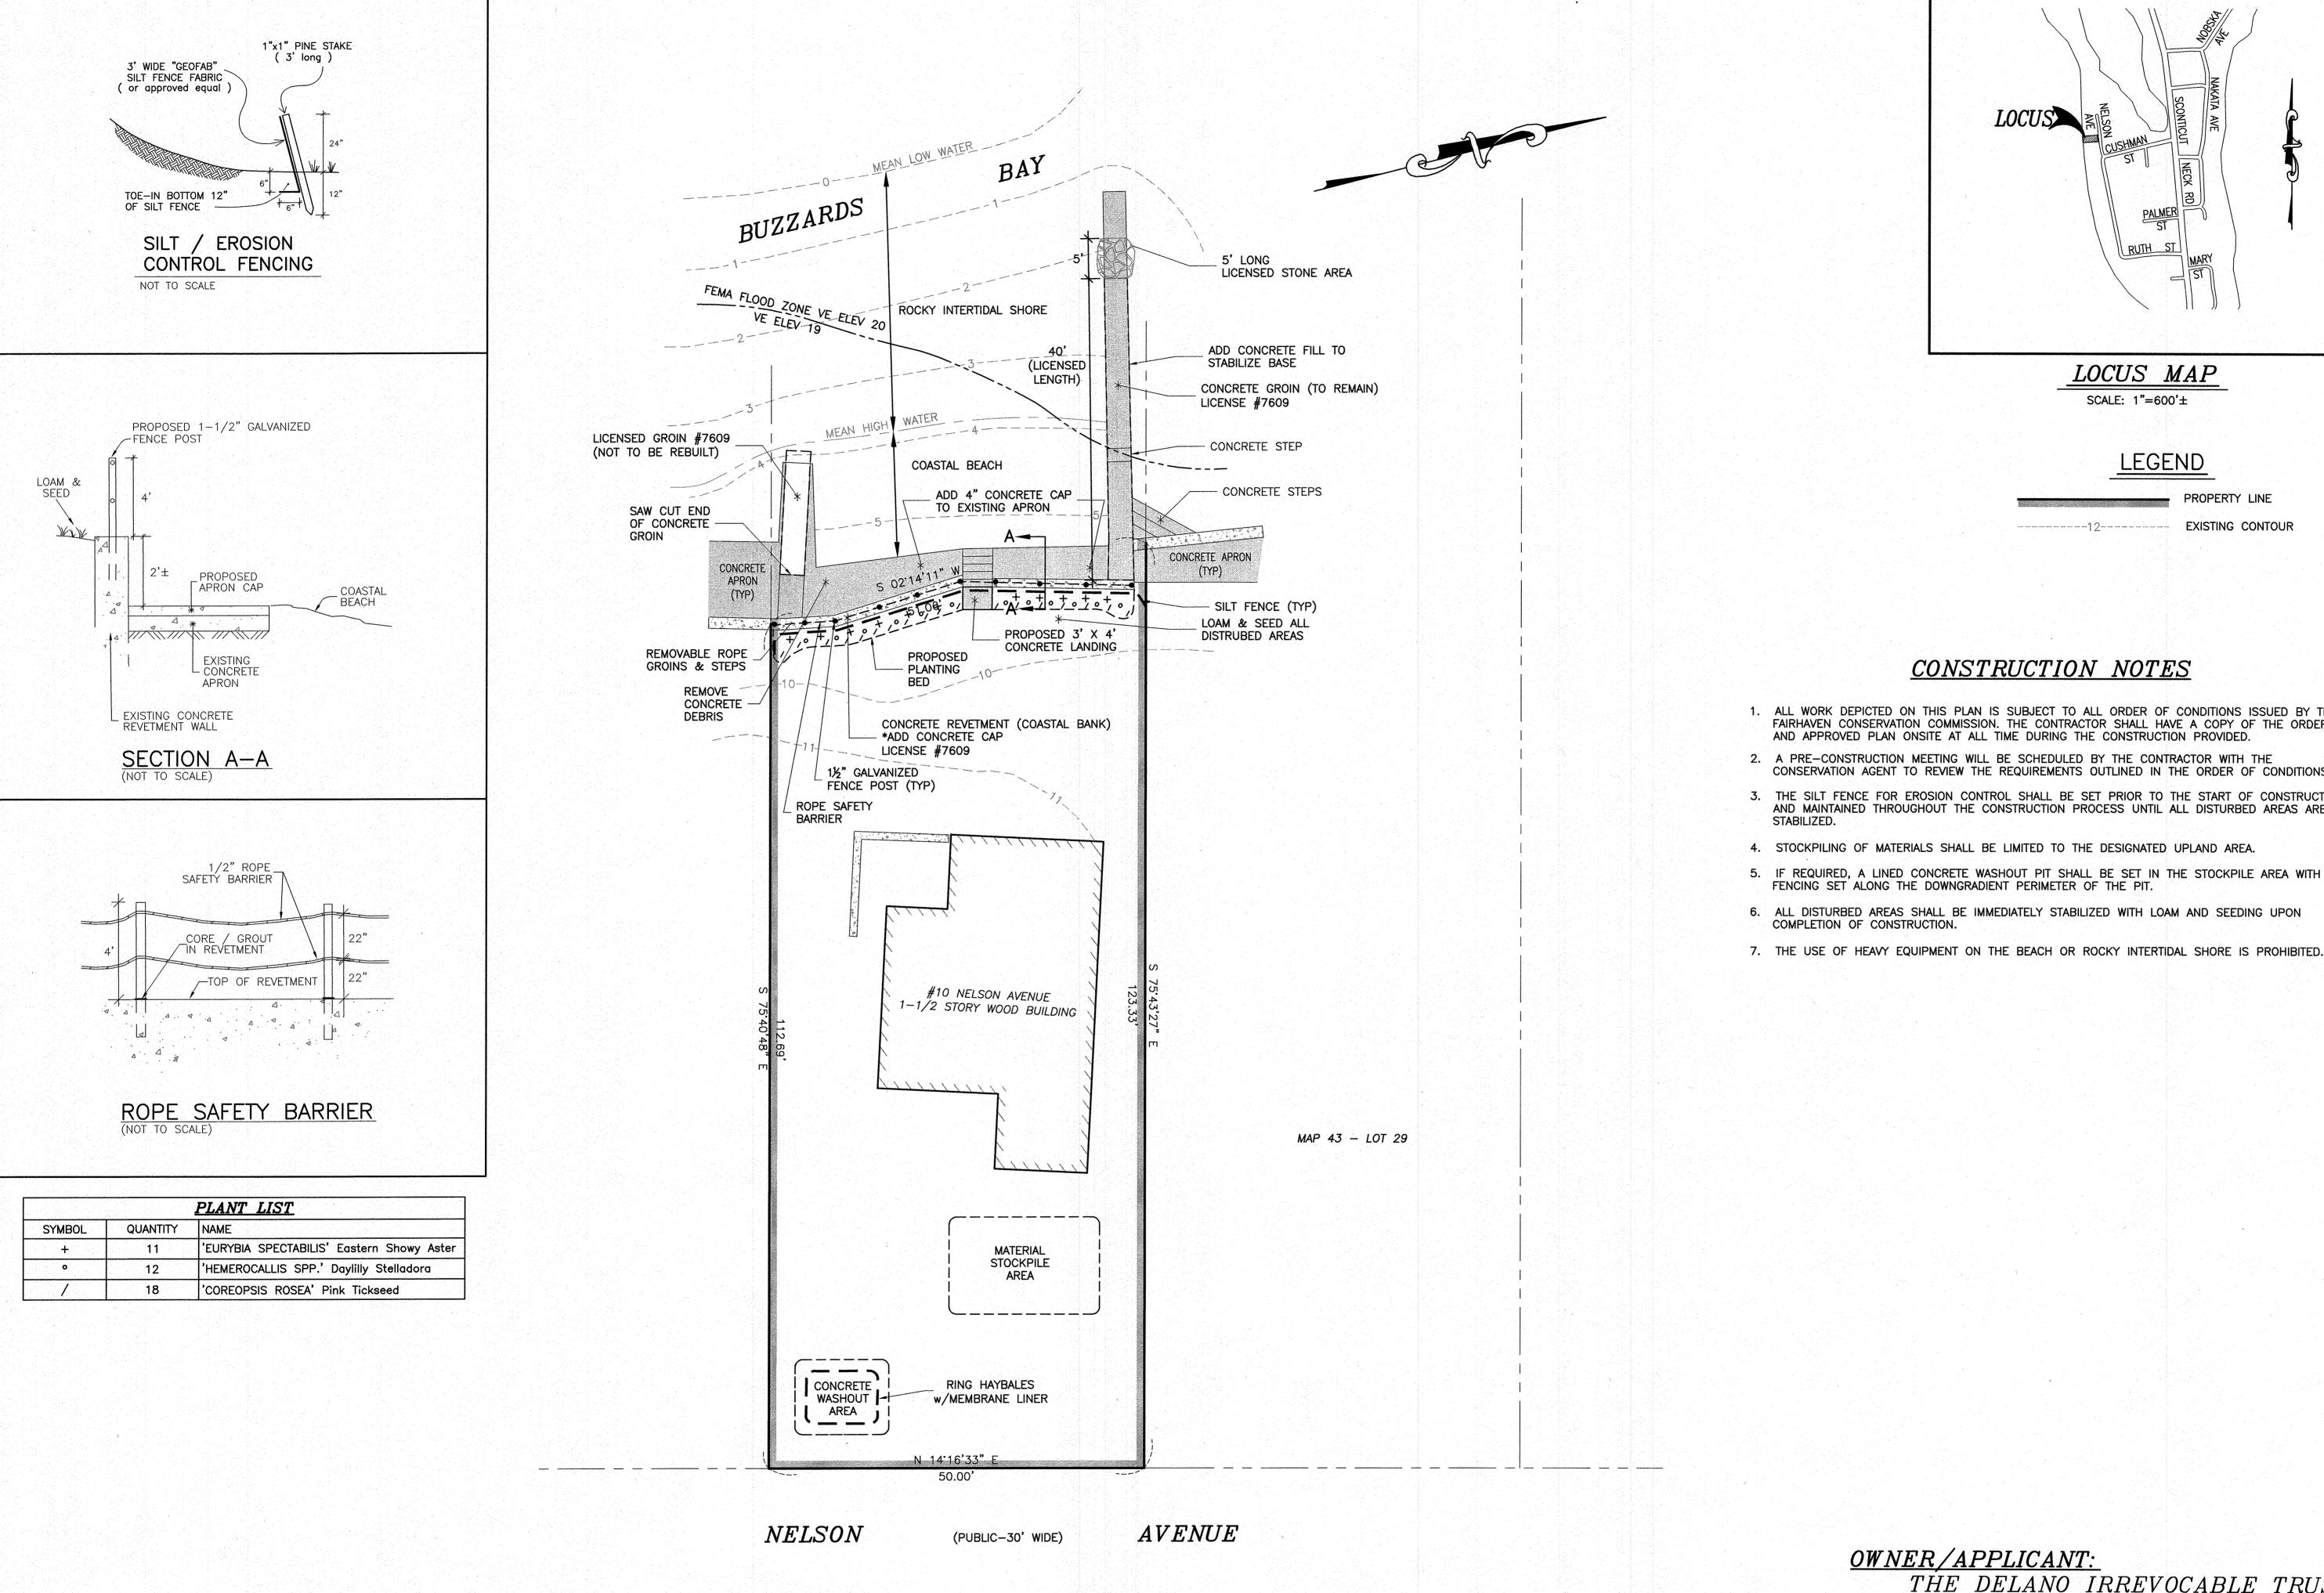

| LOCUS | NELSON CUSHINATION RECONTINUEL INFORMATION AVE<br>NELSON CUSHINATION INFORMATION AVE<br>PALMEER<br>ST<br>RUTH ST<br>RUTH ST<br>ST |          |
|-------|---|----------|
|       | LOCUS MAP<br>SCALE: 1"=600'±  |          |
|       | LEGEND<br>PROPERTY LIN  | <b>F</b> |

EXISTING CONTOUR

CONSTRUCTION NOTES

1. ALL WORK DEPICTED ON THIS PLAN IS SUBJECT TO ALL ORDER OF CONDITIONS ISSUED BY THE FAIRHAVEN CONSERVATION COMMISSION. THE CONTRACTOR SHALL HAVE A COPY OF THE ORDER AND APPROVED PLAN ONSITE AT ALL TIME DURING THE CONSTRUCTION PROVIDED. 2. A PRE-CONSTRUCTION MEETING WILL BE SCHEDULED BY THE CONTRACTOR WITH THE

CONSERVATION AGENT TO REVIEW THE REQUIREMENTS OUTLINED IN THE ORDER OF CONDITIONS. 3. THE SILT FENCE FOR EROSION CONTROL SHALL BE SET PRIOR TO THE START OF CONSTRUCTION AND MAINTAINED THROUGHOUT THE CONSTRUCTION PROCESS UNTIL ALL DISTURBED AREAS ARE


4. STOCKPILING OF MATERIALS SHALL BE LIMITED TO THE DESIGNATED UPLAND AREA. 5. IF REQUIRED, A LINED CONCRETE WASHOUT PIT SHALL BE SET IN THE STOCKPILE AREA WITH SILT FENCING SET ALONG THE DOWNGRADIENT PERIMETER OF THE PIT.


6. ALL DISTURBED AREAS SHALL BE IMMEDIATELY STABILIZED WITH LOAM AND SEEDING UPON COMPLETION OF CONSTRUCTION.


|                                    |                        | ~  | CHUS         | ETTS         |                                | 2/27          | L'              |                 |                               |  |
|------------------------------------|------------------------|--|--------------|--------------|--------------------------------|---------------|-----------------|-----------------|-------------------------------|--|
|                                    |                        | CALTH OF MASSA   | OV CTENEND 6 | GIOIOSA      | CIVIL<br>NO. 32165             | COT AN R      | ESCIENCE ANGINE | CIUNAL C        |                               | 0  |
|                                    |                        | <b>&gt;</b>  | -or          | WWO:         | 5<br>•••                       | PR            | 1               | 1               | 0                             |  |
| Appvd.<br>by                       |                        |  |              |              |                                |               |                 |                 |                               | SDG  |
| Chkd.<br>by                        |                        | and the second   |              |              |                                |               |                 |                 |                               | SDG  |
|                                    |                        | server an terrestation of the server and the server of the |              |              |                                |               |                 |                 |                               |  |
|                                    |                        | ad sporte area ranks received in the constraints   |              |              |                                |               |                 |                 |                               |  |
| ų                                  |                        | as to Strain to a figure of a strain of the  |              |              |                                |               |                 |                 |                               |  |
| Description                        |                        | armachan draammaraar   |              |              |                                |               |                 |                 |                               | NTINGS                                     |
| Revision                           |                        | and the section of the section of providence   |              |              |                                |               |                 |                 |                               | ADD PLA                                    |
|                                    |                        | germenter andre andreasers   |              |              |                                |               |                 |                 |                               | ED DESIGN                                  |
|                                    |                        | Solooo oo saada  |              |              |                                |               |                 |                 |                               | 21 REVIS                                   |
| Date                               |                        | รักษณ์เหมือนการกระบบการที่สาวารที่สาวารที่   |              |              |                                |               |                 |                 |                               | APR. 05, 2021 REVISED DESIGN/ADD PLANTINGS |
| No.                                |                        | and construction of an order of solution   |              |              |                                |               |                 |                 |                               | 1 API                                      |
|                                    | 2021                   | The second second second second second   |              |              |                                |               |                 |                 |                               | 1  |
| •                                  | ARY 11,                | An end of the second  |              |              |                                | 0             | of 1            | . <br>;;        | Ţ                             |  |
| scale: 1 "= 1 0'                   | date: FEBRUARY 11, 202 | Ċ  | drawn: BPL   | checked: SDG | JU<br>J                        | OUC :bayarddb | cheet 1         | drawing number; |                               | 200  |
| project: ASSESSORS MAP 43 - LOT 30 | 10 NELSON AVENUE       | FAIRHAVEN, MASSACHUSETTS   |              |              | THF DFI AND IRREVOCABI F TRUST |               | drawing title:  |                 | CUASIAL SIKUCIUKE KEPAIK PLAN |  |
| project: A                         | Ť                      | Augustication in the court of the other or the other of the  | client.      |              |                                |               | dra             |                 |                               |  |

File No. 20-7610

<u>OWNER/APPLICANT:</u> THE DELANO IRREVOCABLE TRUST 10 NELSON AVENUE FAIRHAVEN, MA 02719

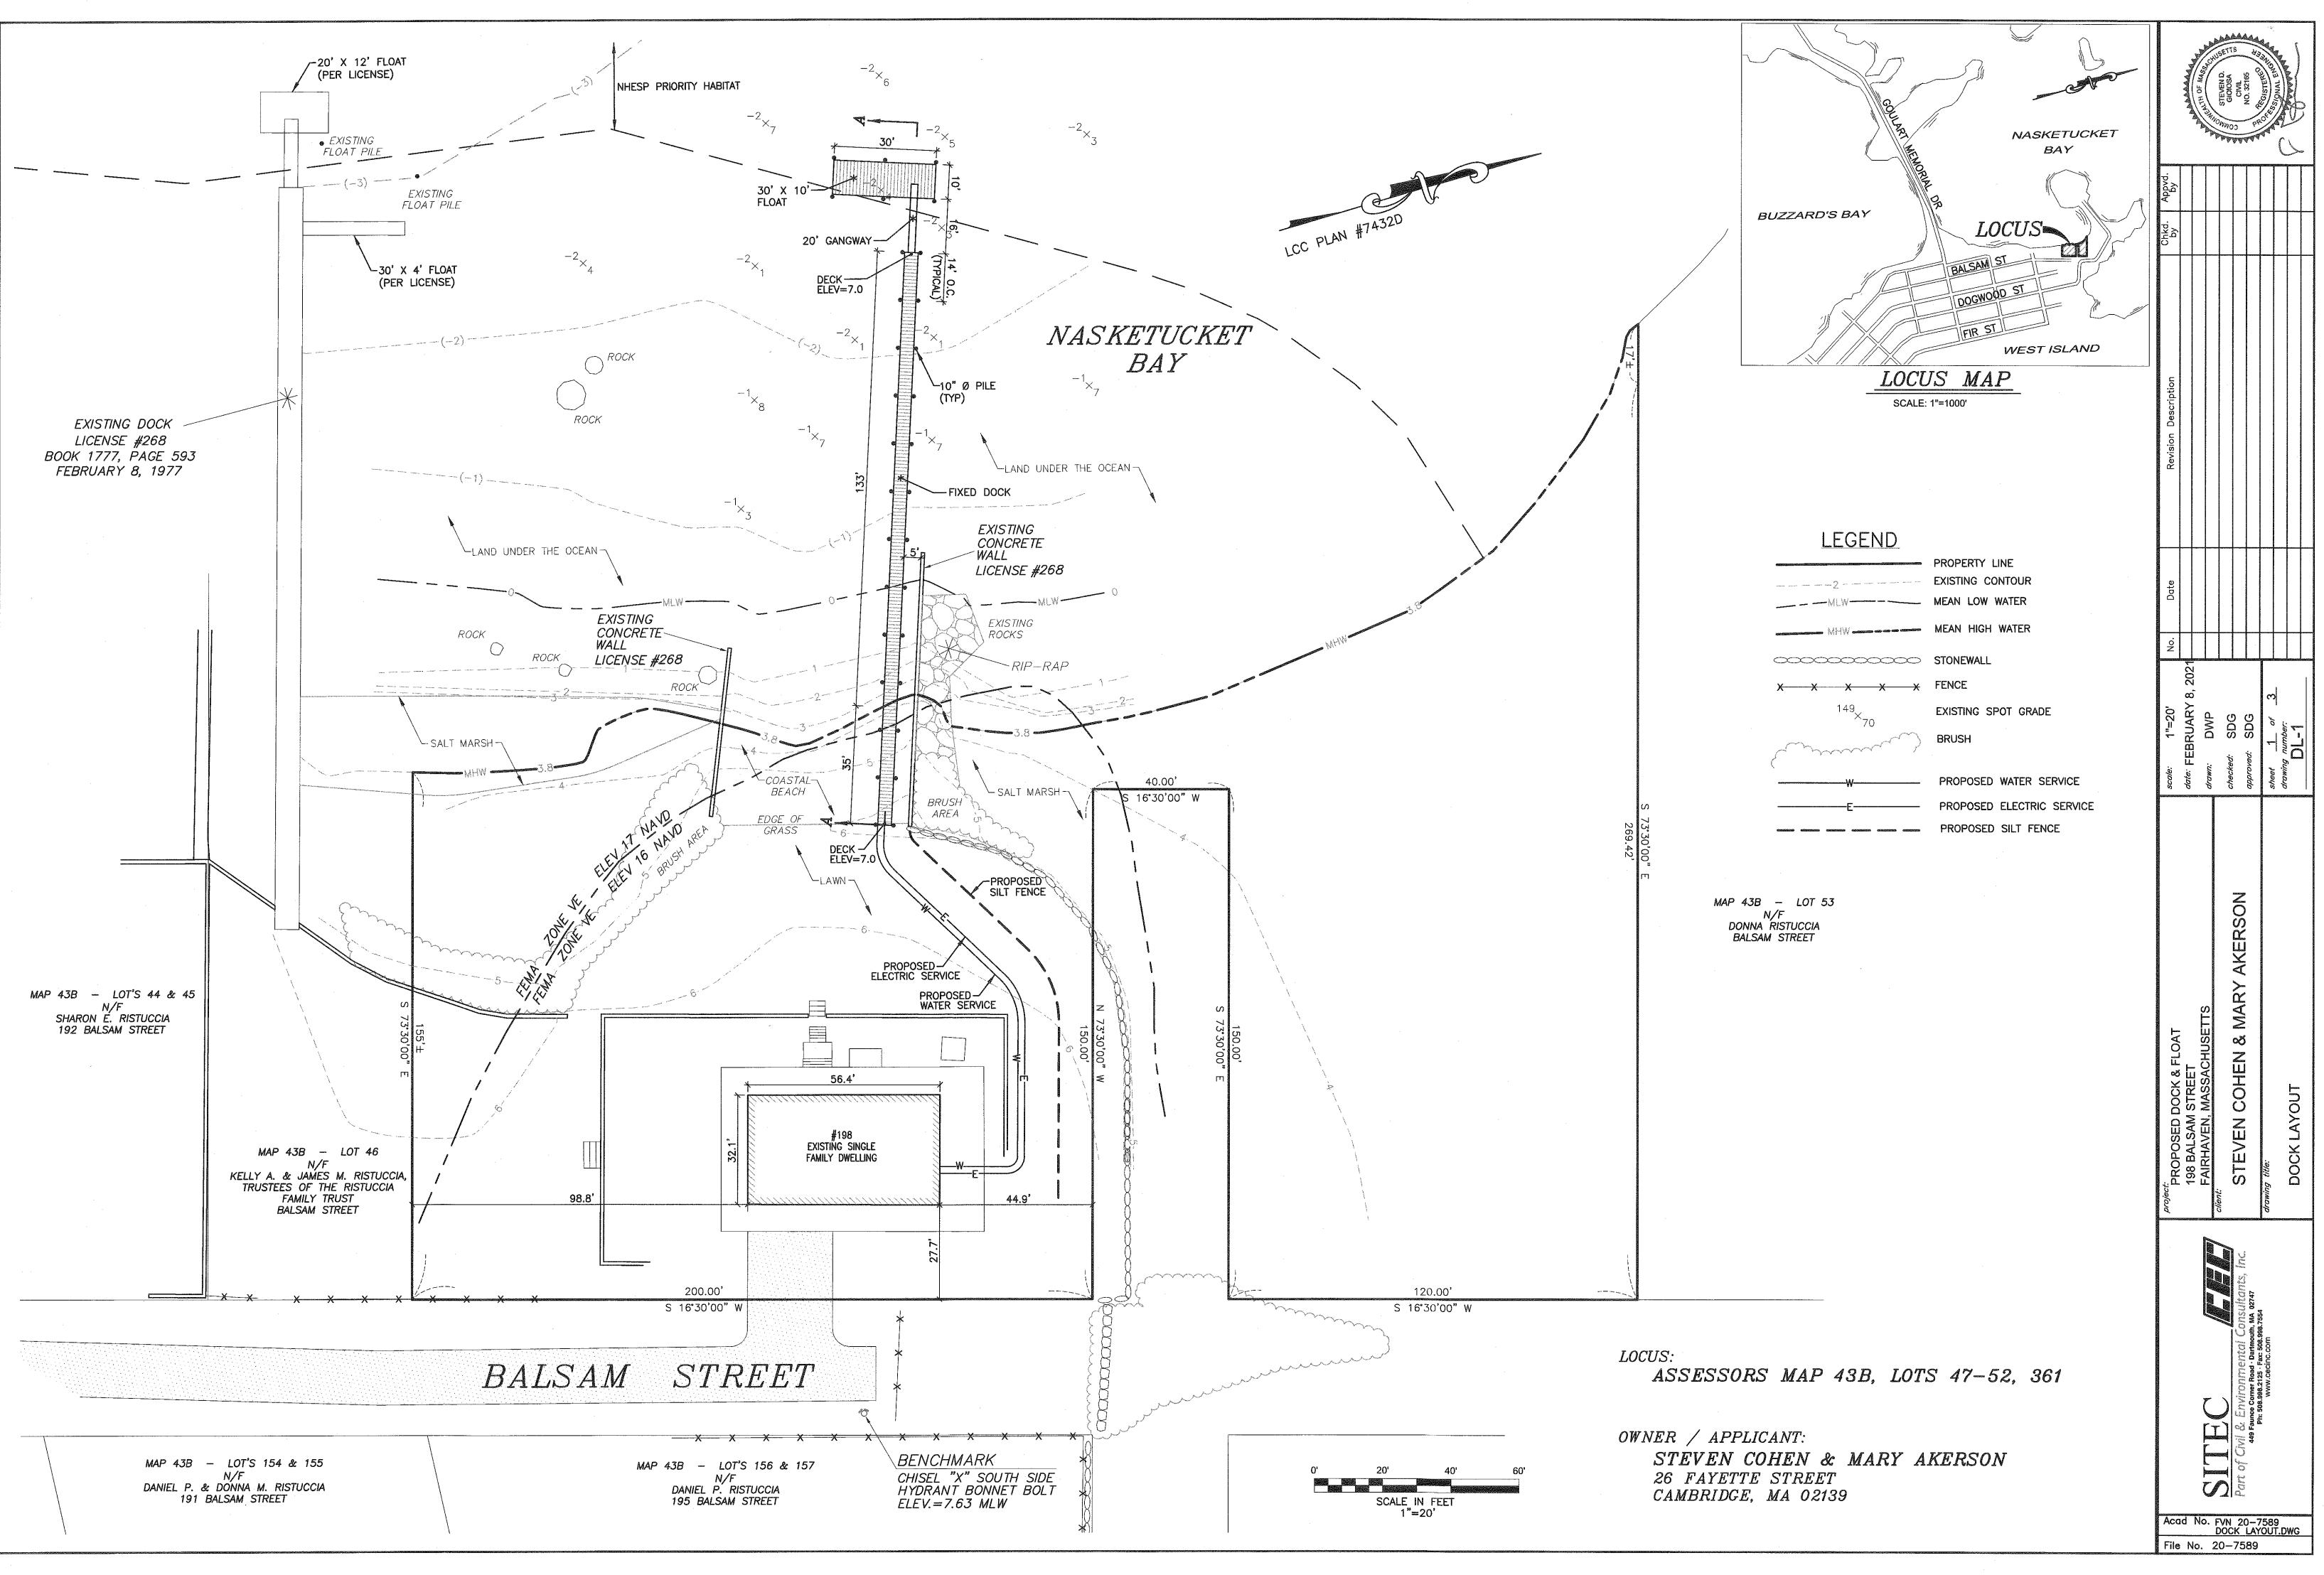


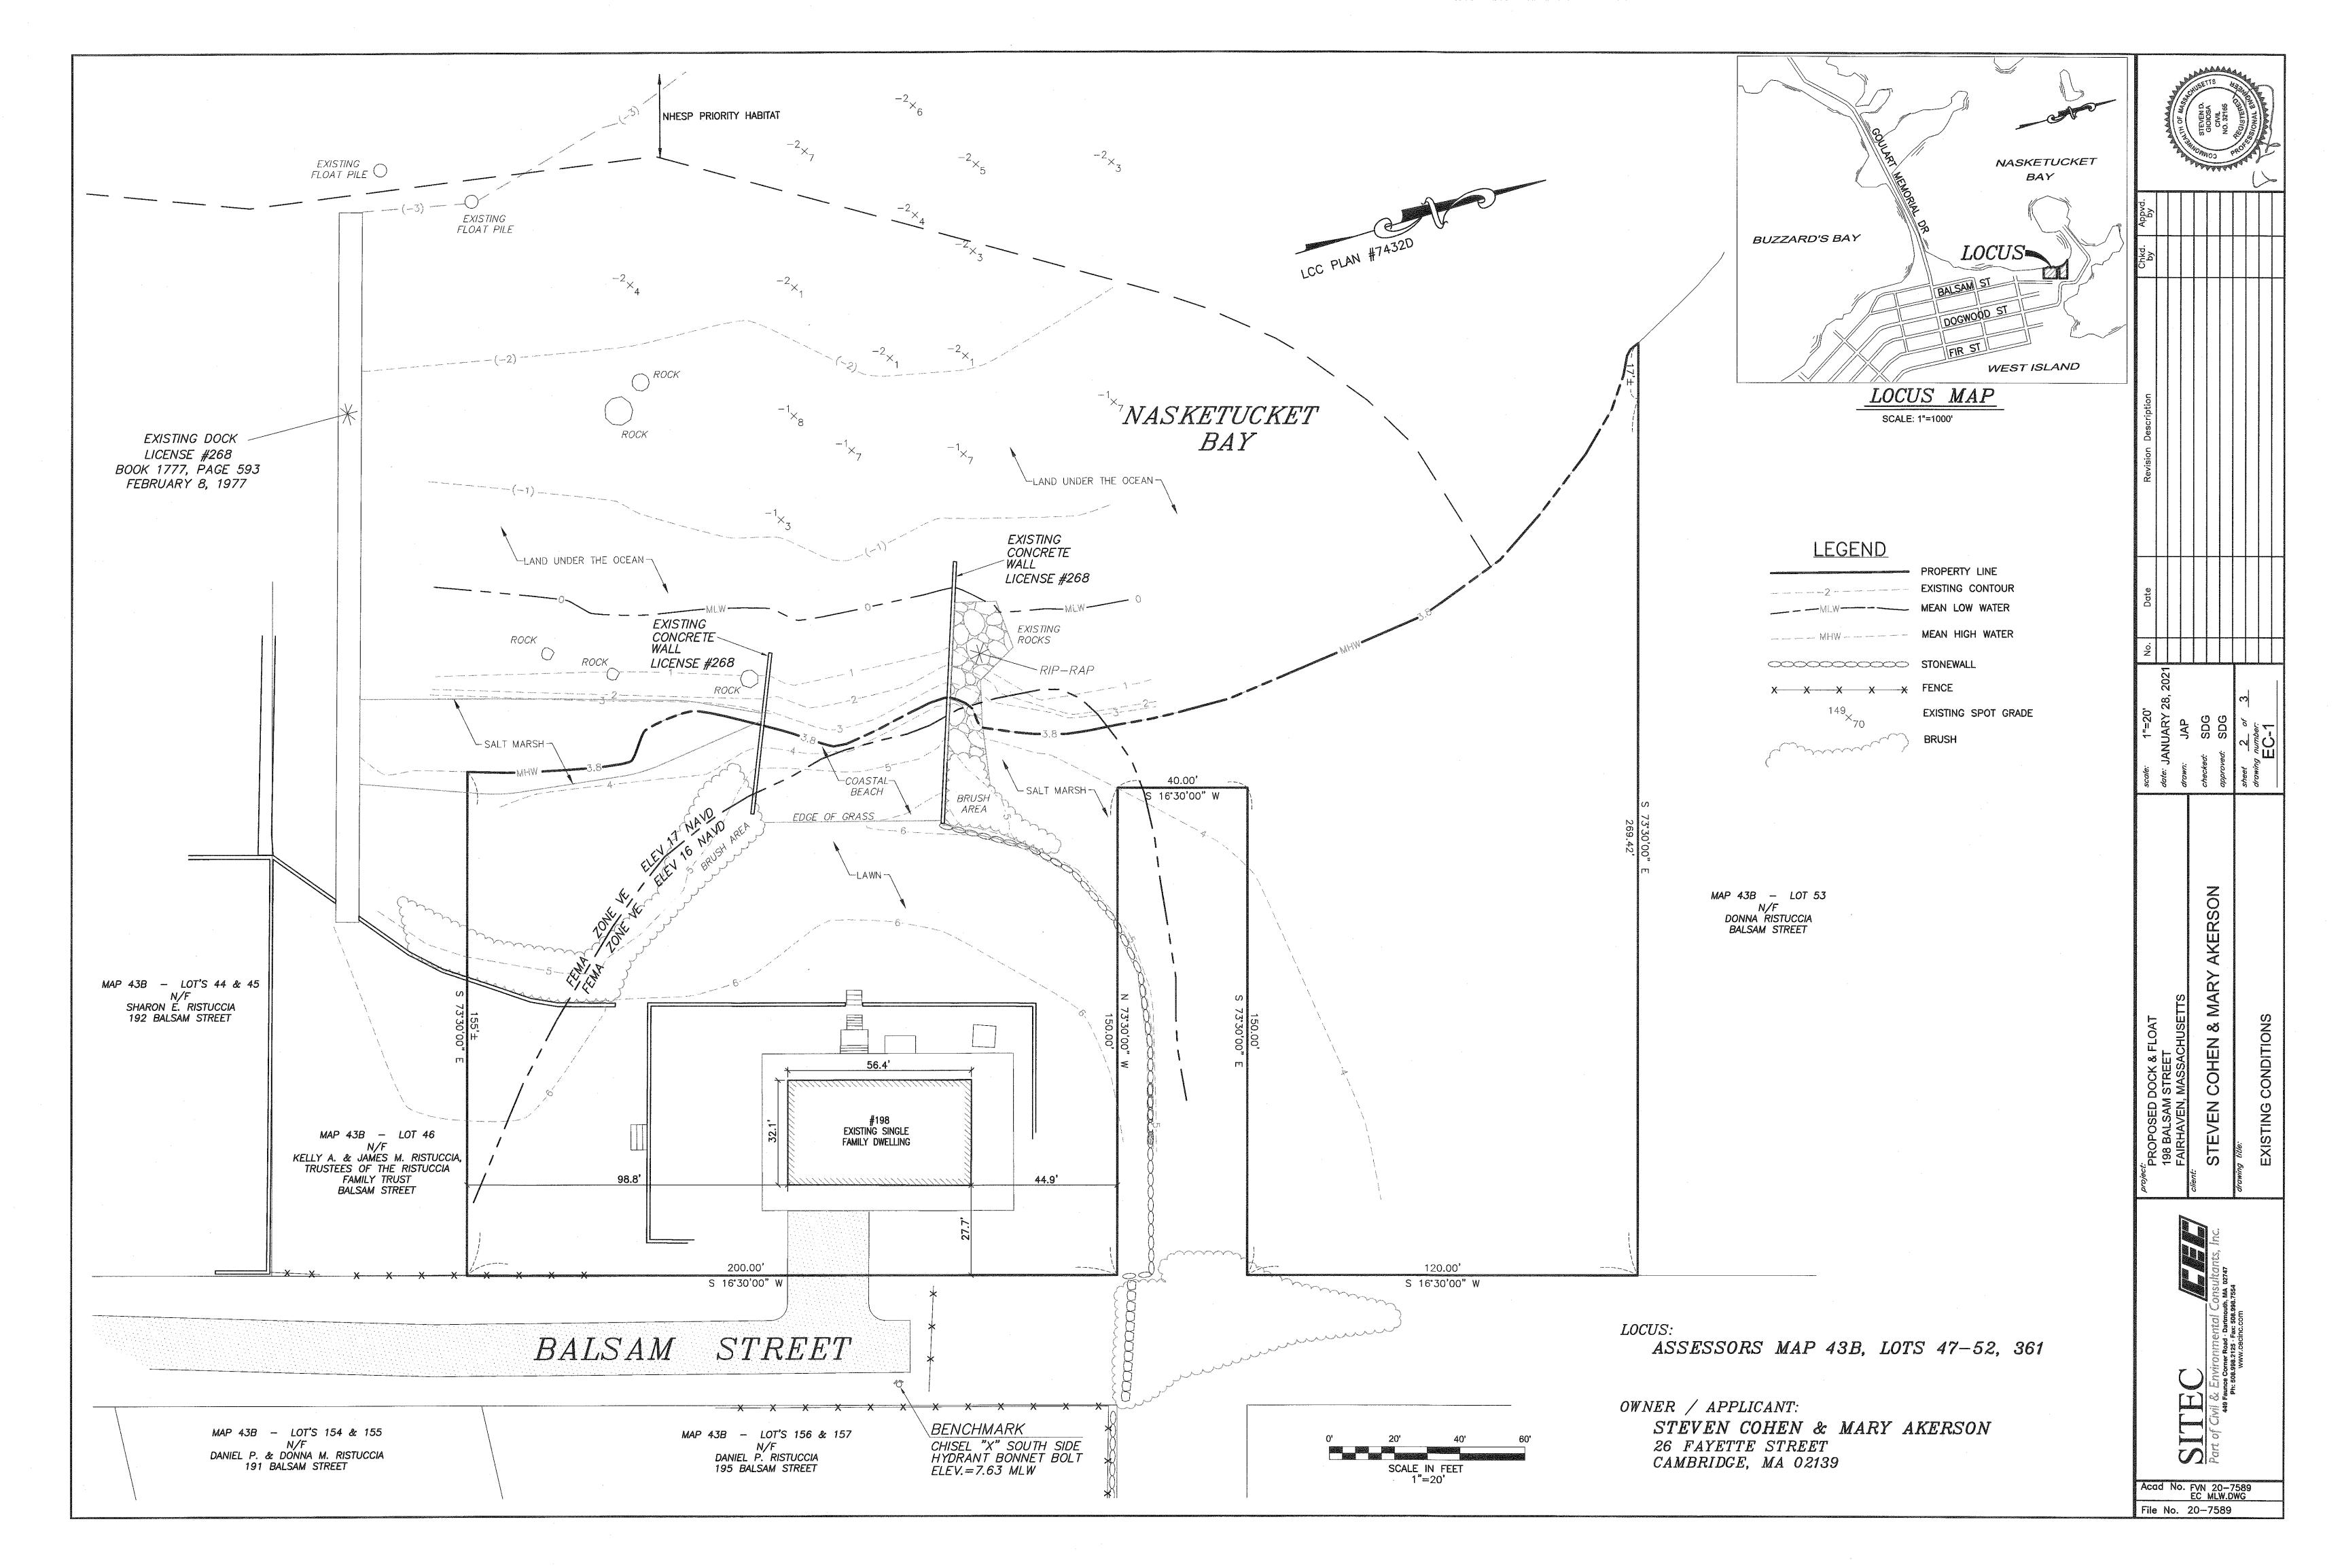


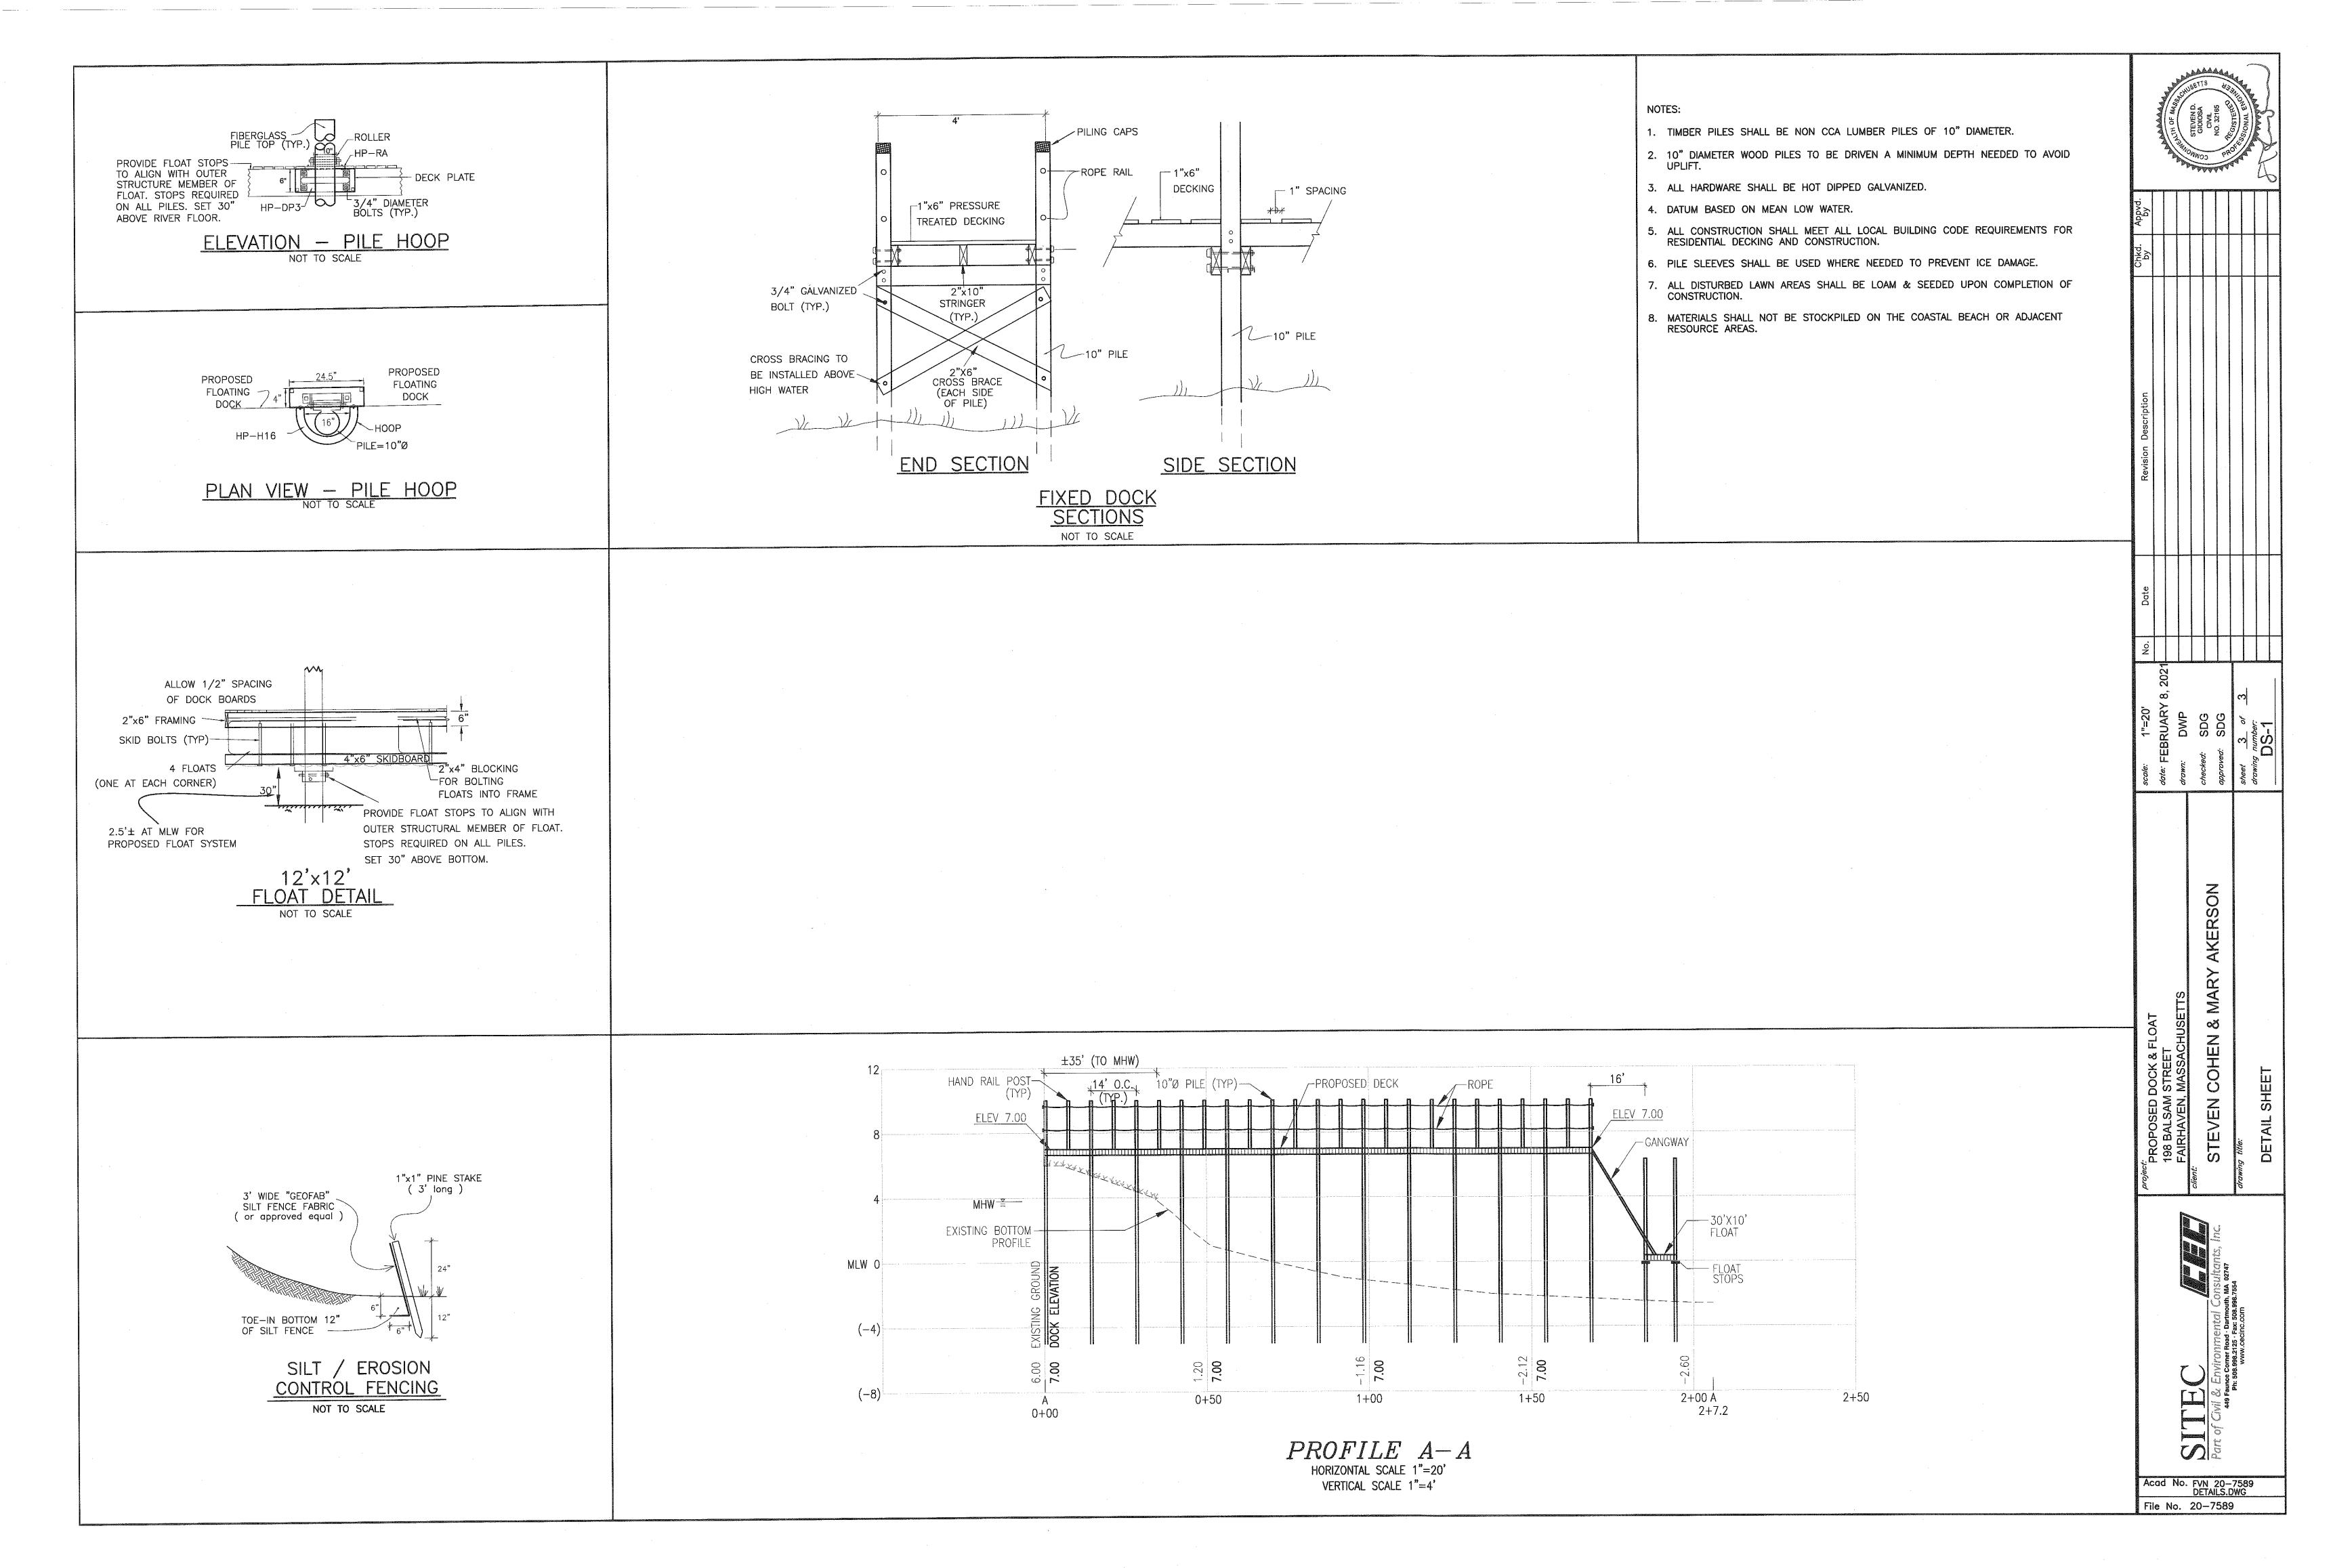






| Appvd.<br>by  |            |              |               |                |                 |             |  |
|---|------------|--------------|---------------|----------------|-----------------|-------------|--|
| Chkd. A<br>by   |            |              |               |                |                 |             |  |
| Revision Description  |            |              |               |                |                 |             |  |
| No. Date  |            |              |               |                |                 |             |  |
| <i>scale:</i> 1"=100'±<br><i>date:</i> FFBRUARY 2021  | drawn: DWP | checked: SDG | approved: SDG | sheet of       | drawina number: | ÅP-1        |  |
| Project:<br>PROPOSED DOCK & FLOAT<br>108 RAI SAM STREET   |            |              |               | drawing title: |                 | AERIAL PLAN |  |
| Acad No. 1525 MAJ .ov Poor<br>Bart of Civil & Environmental Consultants, Inc.<br>448 Faunce Corner Road - Dartmouth, MA 0274<br>Phi: 508.998.2125 : Fax: 508.998.7554<br>www.cecinc.com |            |              |               |                |                 |             |  |

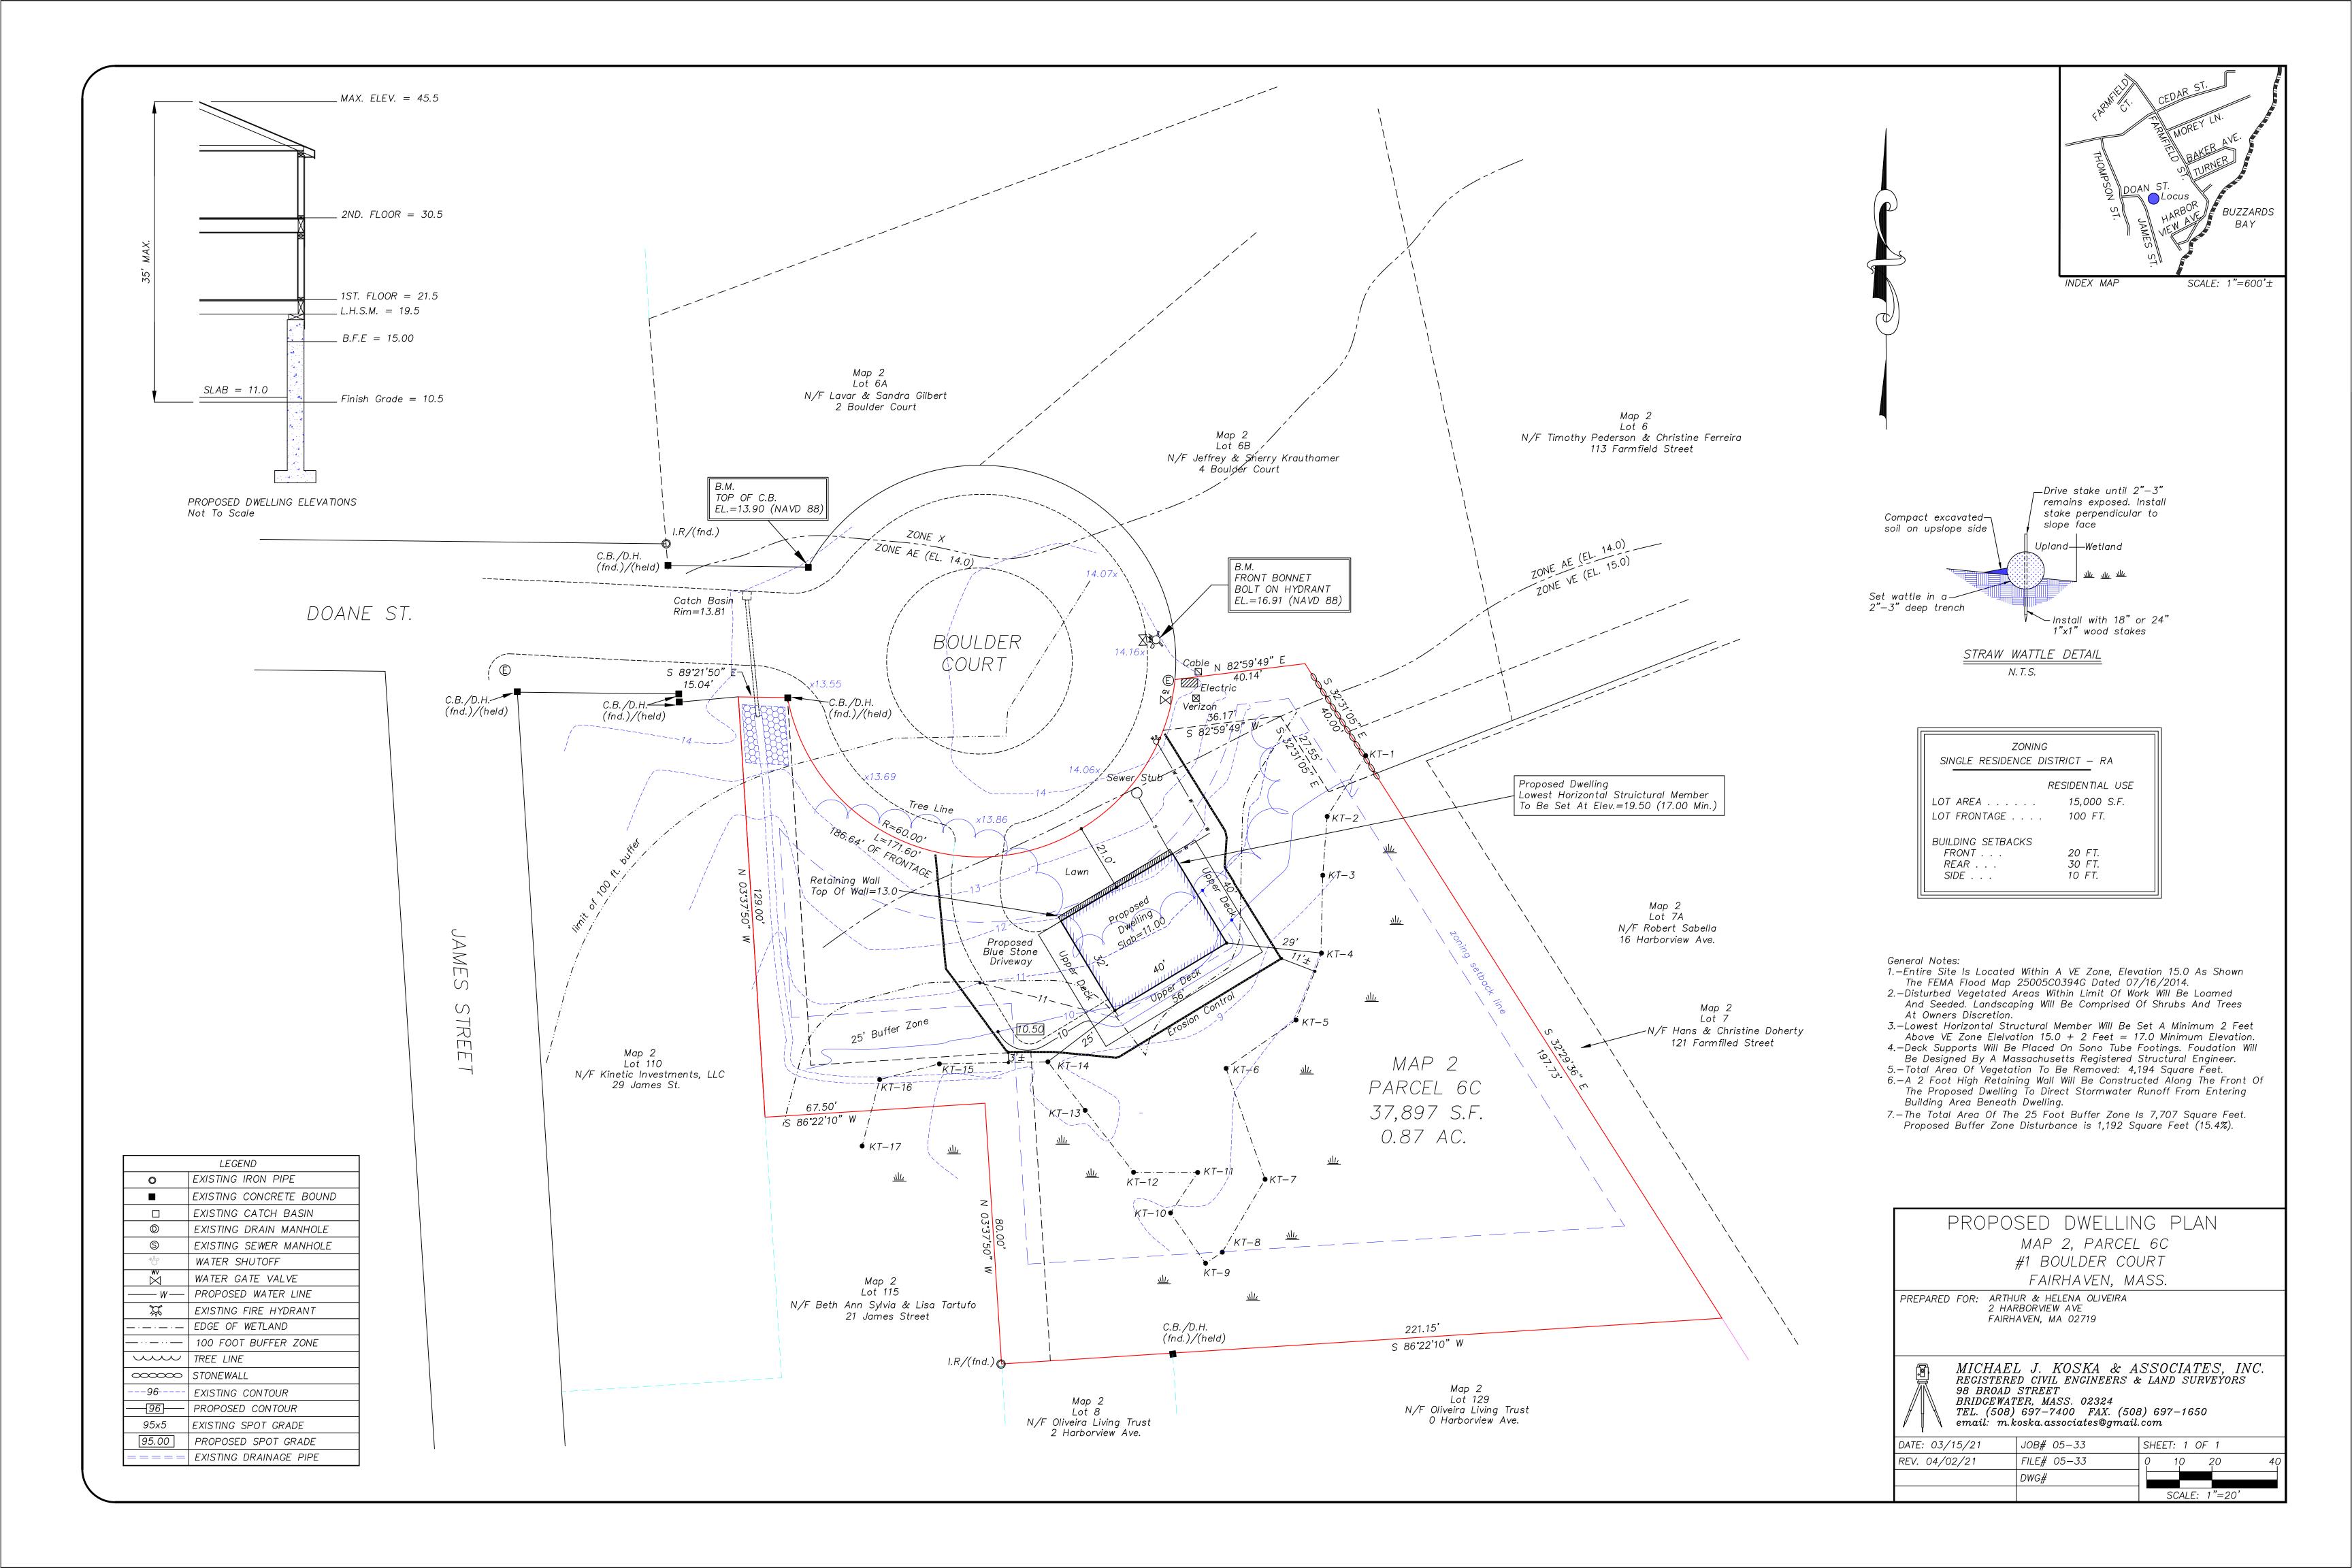

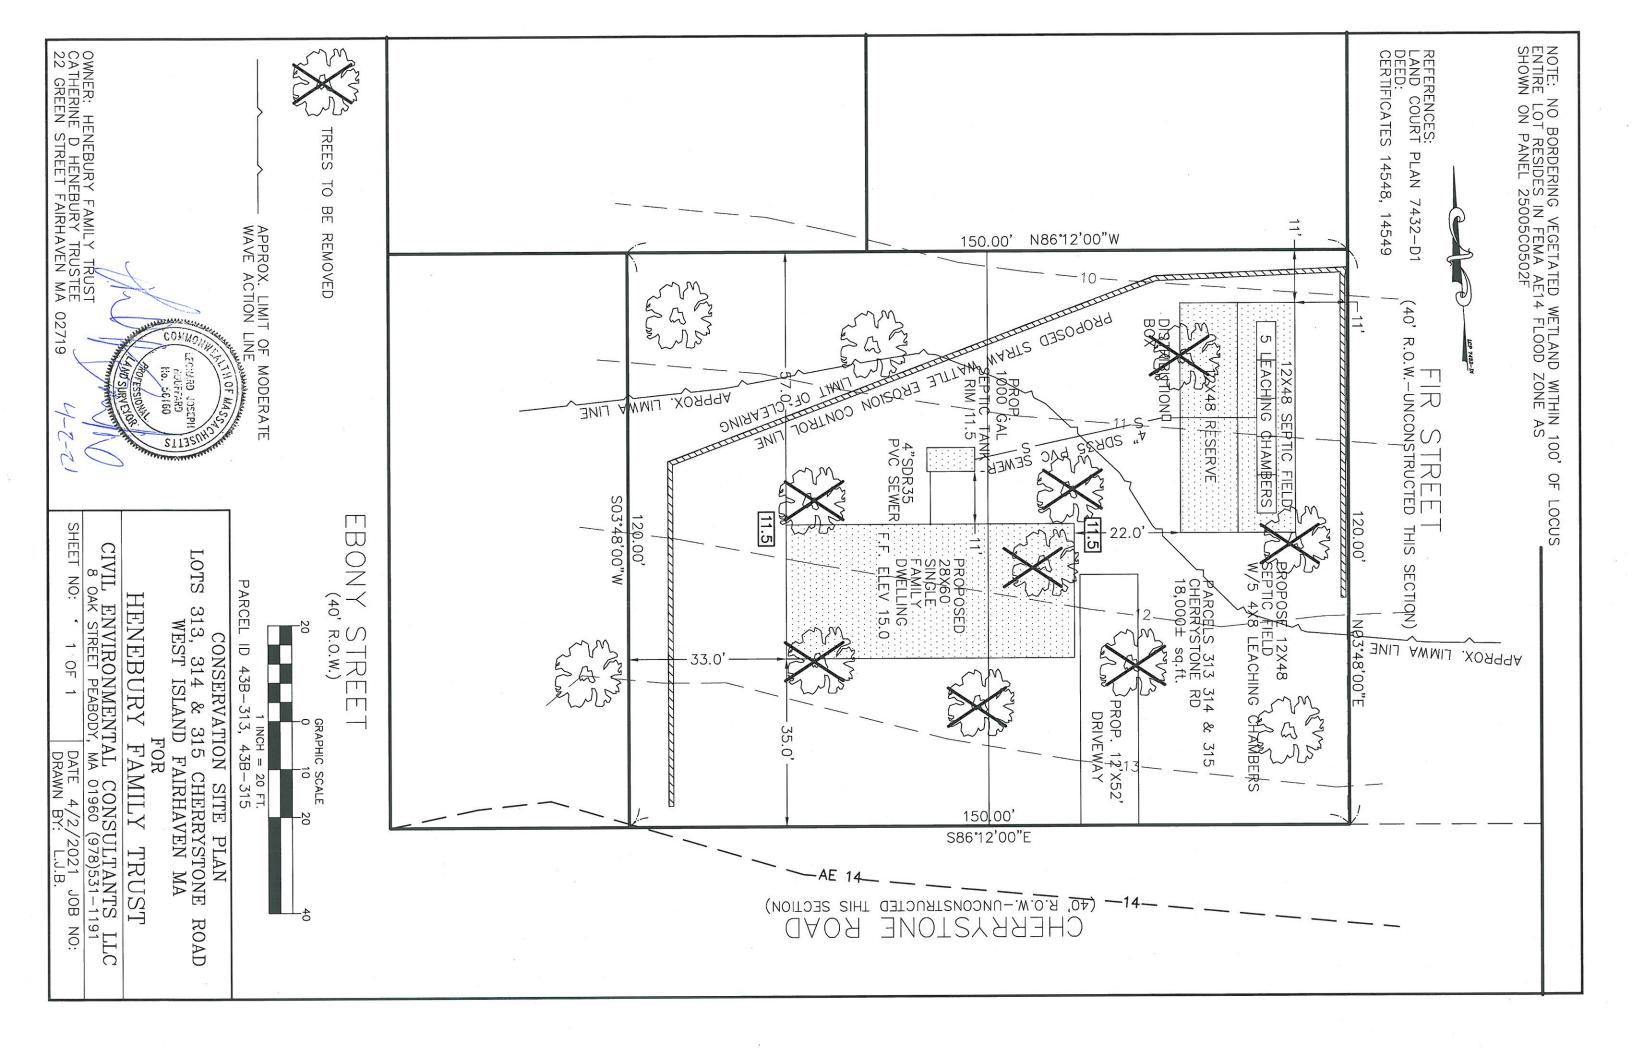

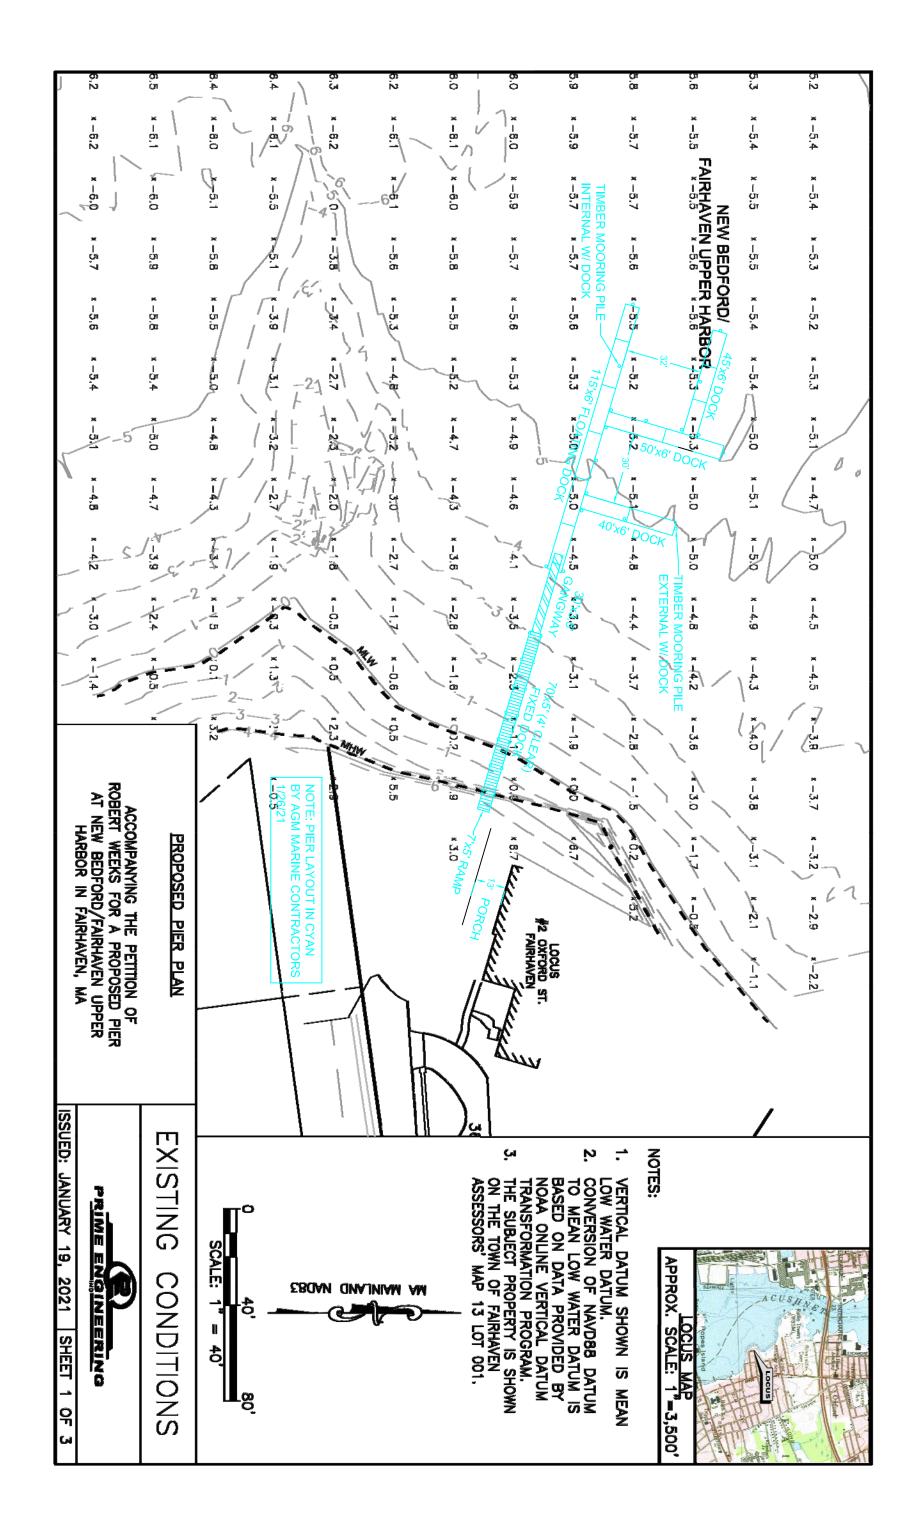

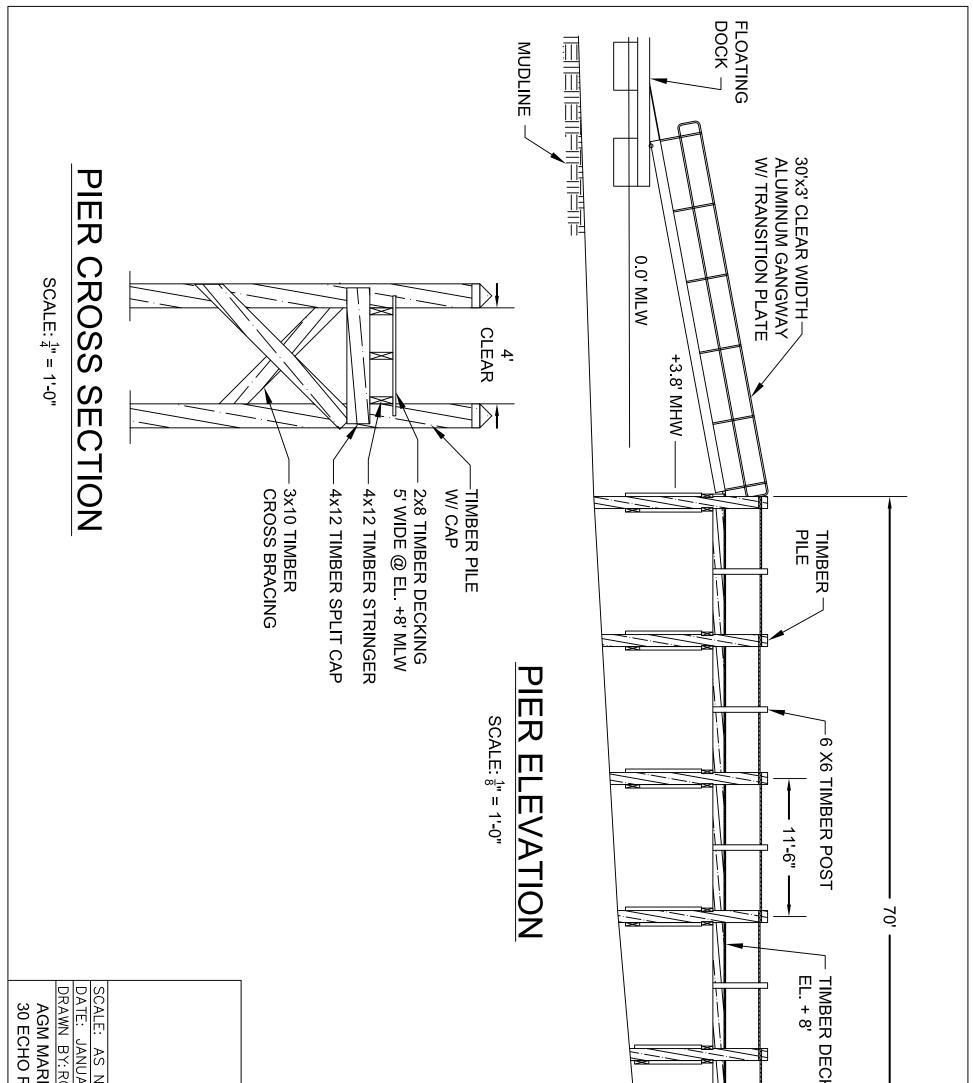

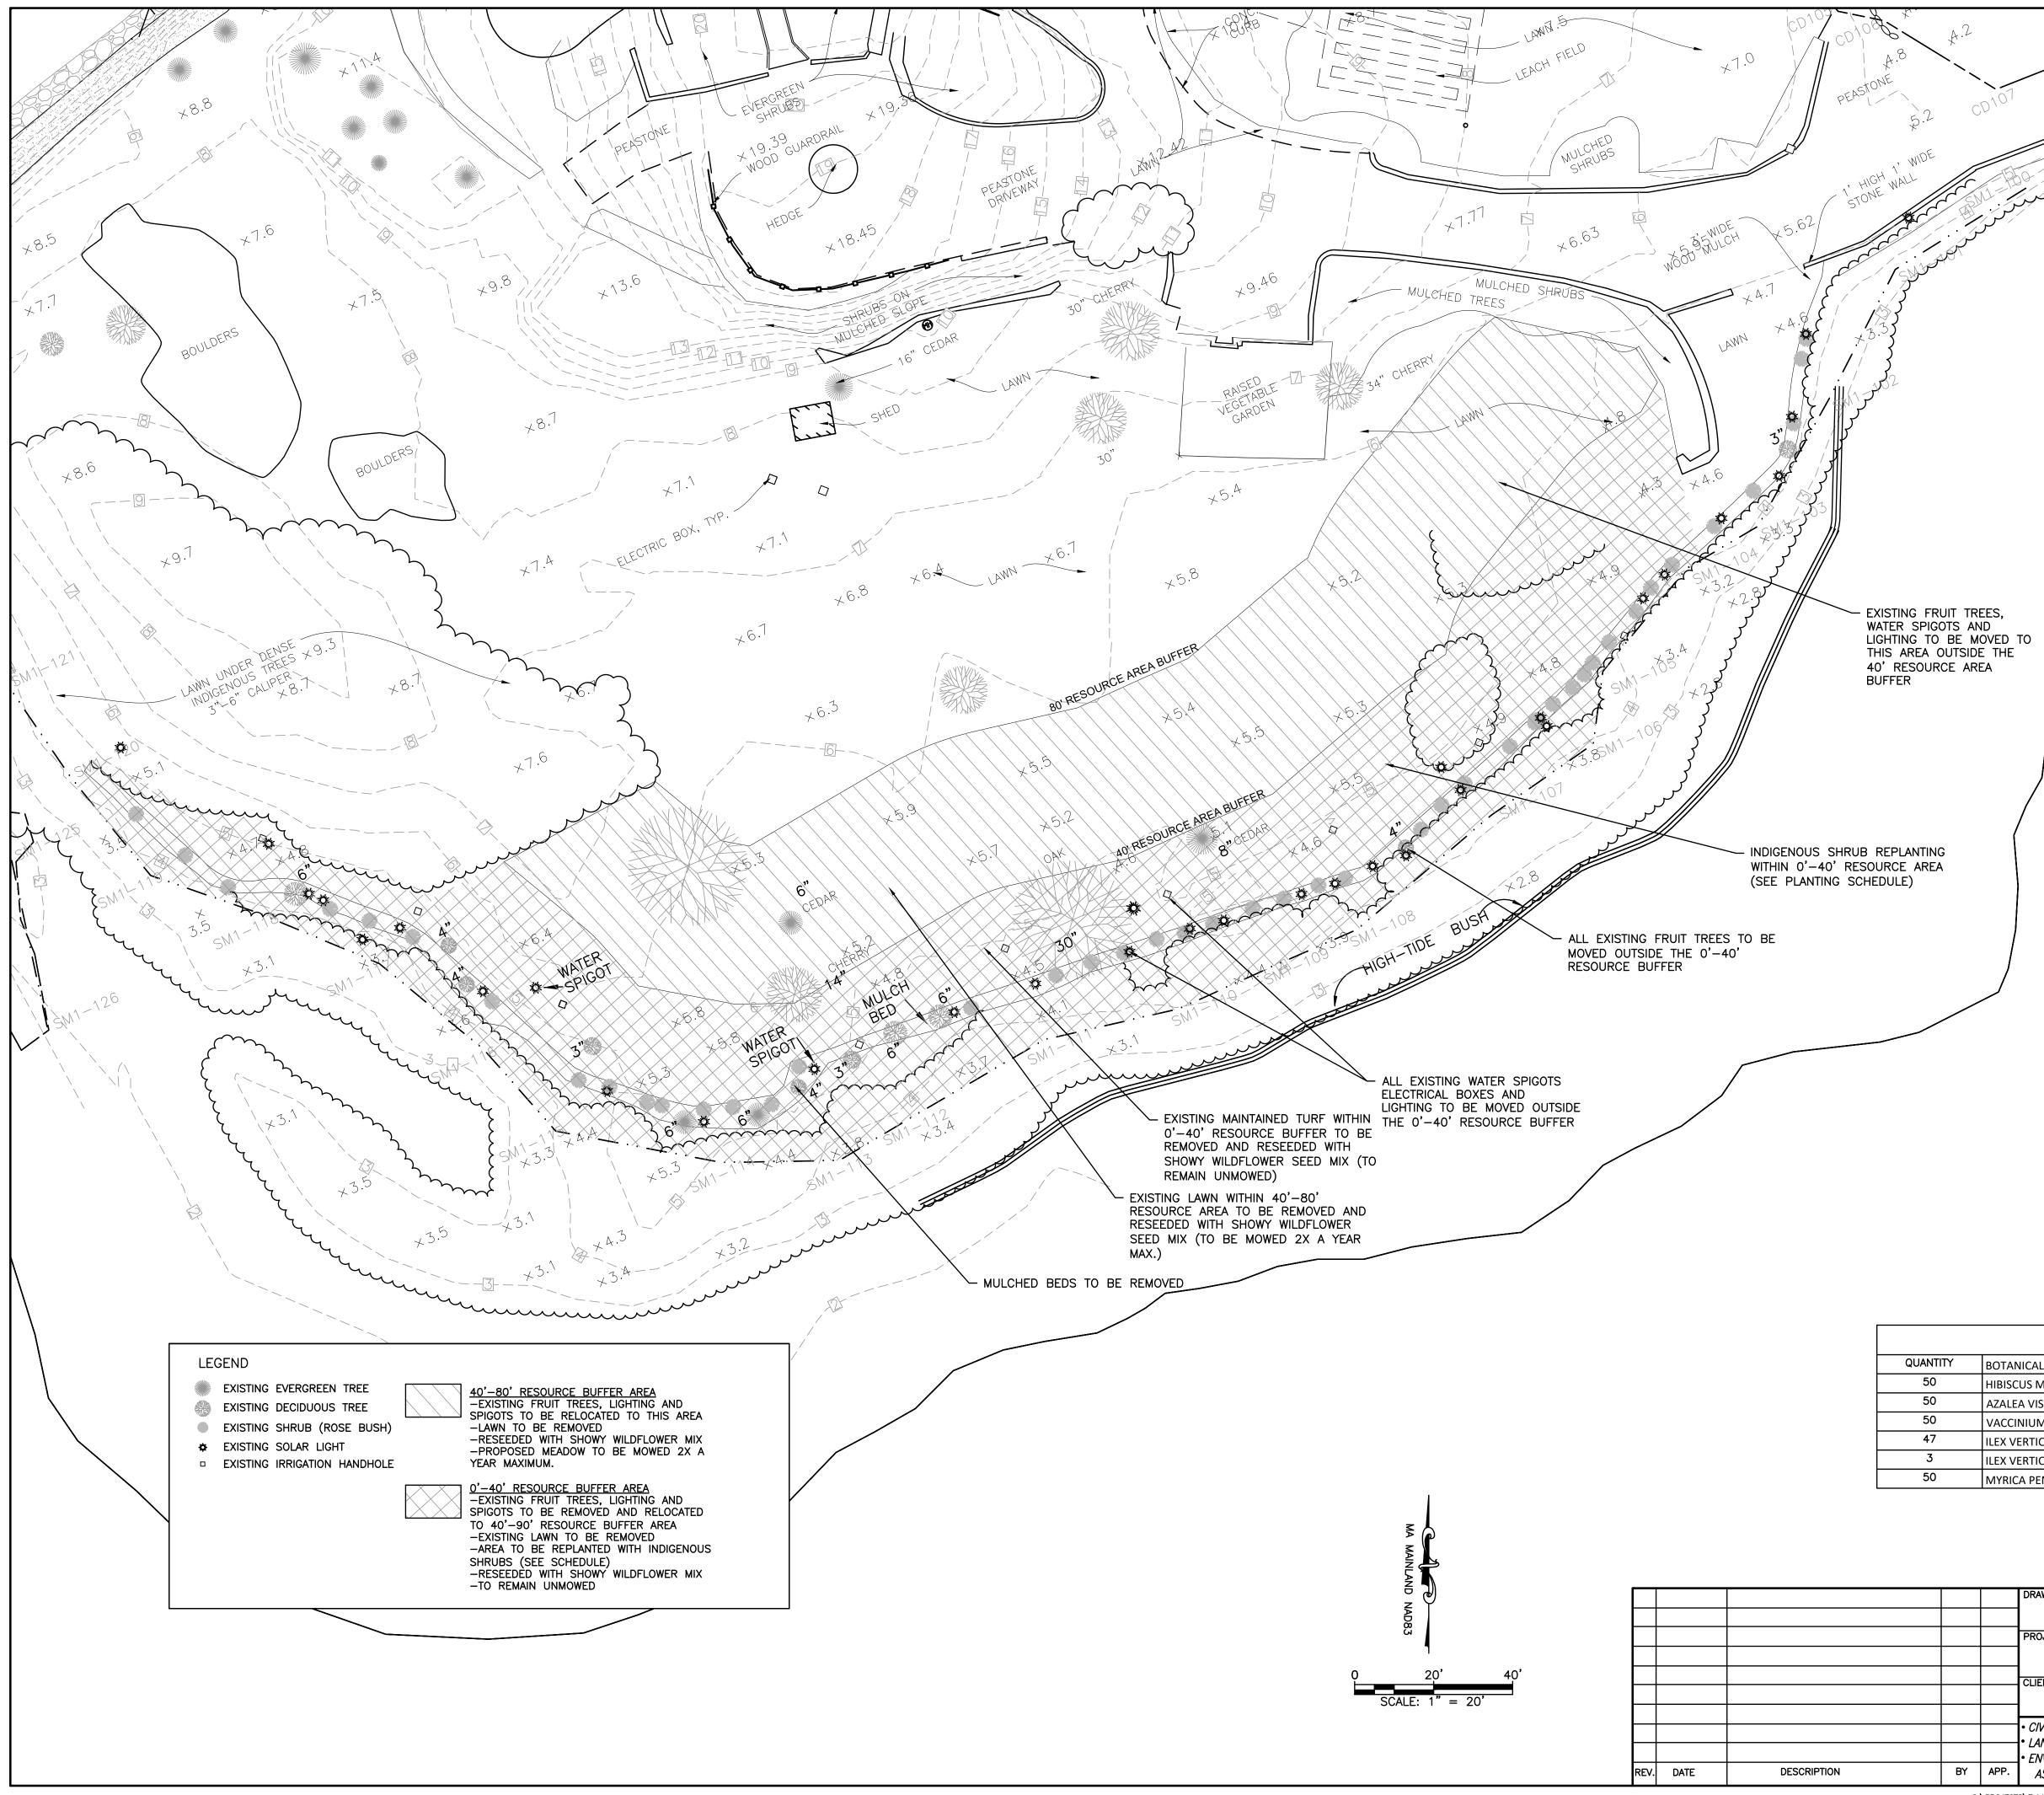



۸ بکشریم

0'-80' RESOURCE BUFFER AREAS TO BE SEEDED WITH ONE POUND PER 2,000 SQUARE FEET OF NEW ENGLAND WETLAND PLANTS, INC. NEW ENGLAND SHOWY WILDFLOWER SEED MIX, OR APPROVED EQUAL WHICH CONTAINS THE FOLLOWING SPECIMENS:

NASKETUCKET

| Botanical Name                                   | Common Name                          | Indicator |
|--|--------------------------------------|-----------|
| Schizachyrium scoparium                          | Little Bluestem                      | FACU      |
| Chamaecrista fasciculata                         | Partridge Pea                        | FACU      |
| Sorghastrum nutans                               | Indian Grass                         | UPL       |
| Festuca rubra                                    | Red Fescue                           | FACU      |
| Elymus canadensis                                | Canada Wild Rye                      | FACU+     |
| Elymus riparius                                  | Riverbank Wild Rye                   | FACW      |
| Heliopsis helianthoides                          | Ox Eye Sunflower                     | UPL       |
| Coreopsis lanceolata                             | Lance Leaved Coreopsis               | FACU      |
| Rudbeckia hirta                                  | Black Eyed Susan                     | FACU-     |
| Liatris spicata                                  | Spiked Gayfeather/Marsh Blazing Star | FAC+      |
| Asclepias syriaca                                | Common Milkweed                      | FACU-     |
| Vernonia noveboracensis                          | New York Ironweed                    | FACW+     |
| Aster novae-angliae (Symphyotrichum novae-anglia | New England Aster                    | FACW-     |
| Eupatorium purpureum (Eutrochium maculatum)      | Purple Joe Pye Weed                  | FAC       |
| Asclepias tuberosa                               | Butterfly Milkweed                   | NI        |
| Solidago juncea                                  | Early Goldenrod                      |           |
| Eupatorium perfoliatum                           | Boneset                              | FACW      |

| PLANTING SCHEDULE |                      |                     |        |  |  |  |  |
|-------------------|----------------------|---------------------|--------|--|--|--|--|
|                   |                      |                     |        |  |  |  |  |
| TITY              | BOTANICAL NAME       | COMMON NAME         | SIZE   |  |  |  |  |
|                   | HIBISCUS MOSCHEUTOS  | MARSH MALLOW        | 2 GAL. |  |  |  |  |
|                   | AZALEA VISCOSUM      | PINK MIST AZALEA    | 2 GAL. |  |  |  |  |
| )                 | VACCINIUM CORYMBOSUM | HIGH BUSH BLUEBERRY | 2 GAL. |  |  |  |  |
| ,                 | ILEX VERTICILLATA    | WINTERBERRY FEMALE  | 3 GAL. |  |  |  |  |
|                   | ILEX VERTICILLATA    | WINTERBERRY MALE    | 3 GAL. |  |  |  |  |
| )                 | MYRICA PENSYLVANICA  | BAYBERRY            | 2 GAL. |  |  |  |  |

| Τ |    |      | DRAWING TITLE       |                         |  | SCALE:        |                   |
|---|----|------|---------------------|-------------------------|--|---------------|-------------------|
| t |    |      |                     | PROPOSED PLANTING PLA   | Ν                                      | 1" = 20'      | June Here         |
| ╈ |    |      | PROJECT             |                         |  | DATE:         | RICHARD           |
| ╋ |    |      | I ROOLOT            | BELLA VISTA ISLAND      |  | APRIL 5, 2021 |                   |
|   |    |      |                     | FAIRHAVEN MASSACHUSETTS |  | DRAWN BY:     |                   |
|   |    |      | CLIENT              |                         |  | JAG           | A P CIVIL AVE     |
|   |    |      |                     | HEIAM ALSWALHI          |  | DESIGNED BY:  | SSIDING SIGNAR    |
| ╈ |    |      |                     | FAIRHAVEN MASSACHUSETTS |  | RJR           | Ching How we want |
| ╈ |    |      | • CIVIL ENGINEERING |                         |  | CHECKED BY:   | SHEET NO.         |
| ╋ |    |      | • LAND SURVEYING    | (**)                    | 350 BEDFORD ST.<br>LAKEVILLE, MA 02347 | RJR           | 1 OF 1            |
|   |    |      | • ENVIRONMENTAL     | PRIME ENGINEERING       |  | APPROVED BY:  | PROJECT NO.       |
|   | BY | APP. | ASSESSMENT          |                         | FAX: 508.947.2004                      | RJR           | 1779-01-01        |

0:\PROJECTS\Fairhaven\Bella Vista Island\ENGINEERING\1779-BELLA VISTA-BASE.dwg