

(FULL WALL HEIGHT)

I IIING KET	
HEATHING	WALL TYPES NOTE: REFER TO FLOOR PLAN FOR WALL TYPES USED, SHEATHING, AND HEIGHT INFORMATION.
LL BOARD HEIGHT)	
LL BOARD AT 6" (150MM) NG)	2 NEW FURRED/CHASE WALL 20 GA. 3 5/8" MTL STUDS 16" O.C. WITH 5/8" TYPE
TIOUS BACKER MINATE AT 6" VE CEILING)	'X' GWB ON ONE SIDE (5/8" TILE BACKER BOARD AS INDICATED ON RESTROOM / BACKBAR / DRIVE THRU SIDE) TO HEIGHT INDICATED ON FLOOR PLAN. SECURE SHEATHING TO STUDS WITH
TIOUS BACKER . WALL HEIGHT)	DRYWALL SCREWS @ 10" O.C. AT PANEL EDGES AND 12" O.C. AT INTERMEDIATE SUPPORTS.
D	L

KEYED NOTES

- 1. STRUCTURAL COLUMN, SEE STRUCTURAL. 2. CONCRETE SLAB OVER VAPOR BARRIER OVER
- COMPACTED FILL. REFER TO STRUCTURAL. 3. ELECTRICAL PANEL LOCATIONS. MAINTAIN MINIMUM
- CLEARANCE AS REQUIRED BY CODE.
- 4. 36" CLEAR FOR ROOF LADDER ACCESS. 5. OUTLINE OF CANOPY ABOVE. SEE ROOF PLAN AND EXTERIOR ELEVATIONS.
- 6. RECESSED AREA FOR FUTURE WALK OFF MAT, TO BE COORDINATED WITH REGIONAL DESIGN TEAM. SEE STRUCTURAL.
- 7. FUTURE FURRED PLUMBING WALL
- 8. FUTURE FURRED WALL 9. ROOF SCUPPER AND DOWNSPOUT. CONNECT VERTICAL LEADERS TO UNDERGROUND STORM
- 10. CANOPY DOWNSPOUT. CONNECT VERTICAL LEADERS TO UNDERGROUND STORM DRAIN.
- 11. SEE STRUCTURAL FOR HEADER ABOVE KNOCK-OUT. STANDARD FRAMING CAN INFILL BELOW HEADER. COORDINATE WITH REGIONAL DESIGN TEAM IF NEEDED.
- 12. CURB BELOW ASSOCIATED WITH FURRING AND INSULATION.
- 13. ALTERNATE EXTERIOR ROOF LADDER LOCATION
- 14. DOOR ACTUATOR CONTROL PEDESTAL. 15. WALL MOUNTED DOOR ACTUATOR CONTROL.
- 16. DOOR ACTUATOR KEY SWITCH, WALL MOUNTED. 17. DOOR OPERATOR LOCATED ABOVE KNOWN ACTIVE

DOOR.

GENERAL NOTES

- A. GENERAL CONTRACTOR TO VERIFY ALL DIMENSIONS AND NOTIFY STARBUCKS CONSTRUCTION MANAGER OF ANY DISCREPANCIES PRIOR TO CONSTRUCTION. ALL DIMENSIONS TO BE TAKEN FROM DESIGNATED DATUM POINT.
- B. PROVIDE FIRE TREATED WOOD STUD BLOCKING, OR EQUIVALENT TO SUPPORT ANY WALL ATTACHMENT AND/OR SIGNAGE.
- C. INTERIOR DIMENSIONS ARE TO FINISHED FACE UNLESS SHOWN OR NOTED OTHERWISE.
- D. EXTERIOR WALL DIMENSIONS ARE TO FACE OF SHEATHING UNLESS SHOWN OR NOTED OTHERWISE.
- E. INSTALL MOISTURE RESISTANT DRYWALL ON
- BACKBAR WALL PER LLWL F. ALL DOORS SHALL BE 32" (815MM) MINIMUM CLEAR
- UNLESS OTHERWISE NOTED.
- G. SEE DOOR AND WINDOW SHEET FOR EXTERIOR DOOR AND WINDOW SCHEDULES.

OPENING WHEN OPENED TO 90 DEGREE POSITION

- H. DOOR HARDWARE COMPONENTS PROVIDED AND INSTALLED PER LLWL.
- J. PROVIDE FIRE EXTINGUISHERS AS NOTED ON THE APPROVED PLANS FROM THE CITY.
- K. SEE STRUCTURAL FOR KNEE WALL BRACING.
- L. SEE DETAIL SHEETS FOR BUILDING DETAILS.
- M. REFER TO FLOOR FINISH SHEET FOR FLOOR FINISHES.




STARBUCKS TEMPLATE VERSION: i2021.10.22

THE OTHER (EXCEPT STATED ABOVE) UNTIL A

WRITTEN AGREEMENT IS FULLY EXECUTED BY BOTH PARTIES.

ARCHITECT OF RECORD

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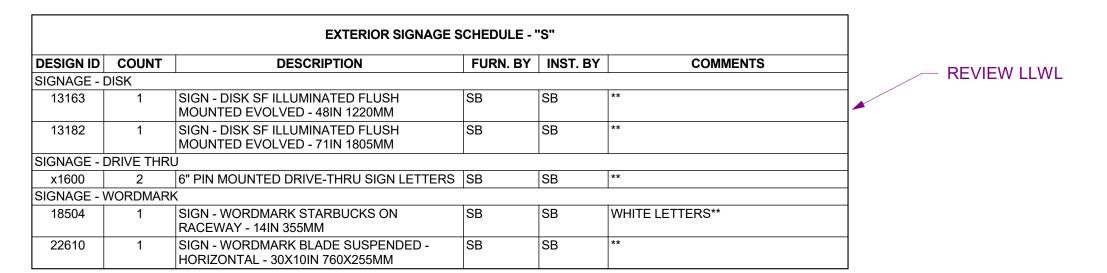
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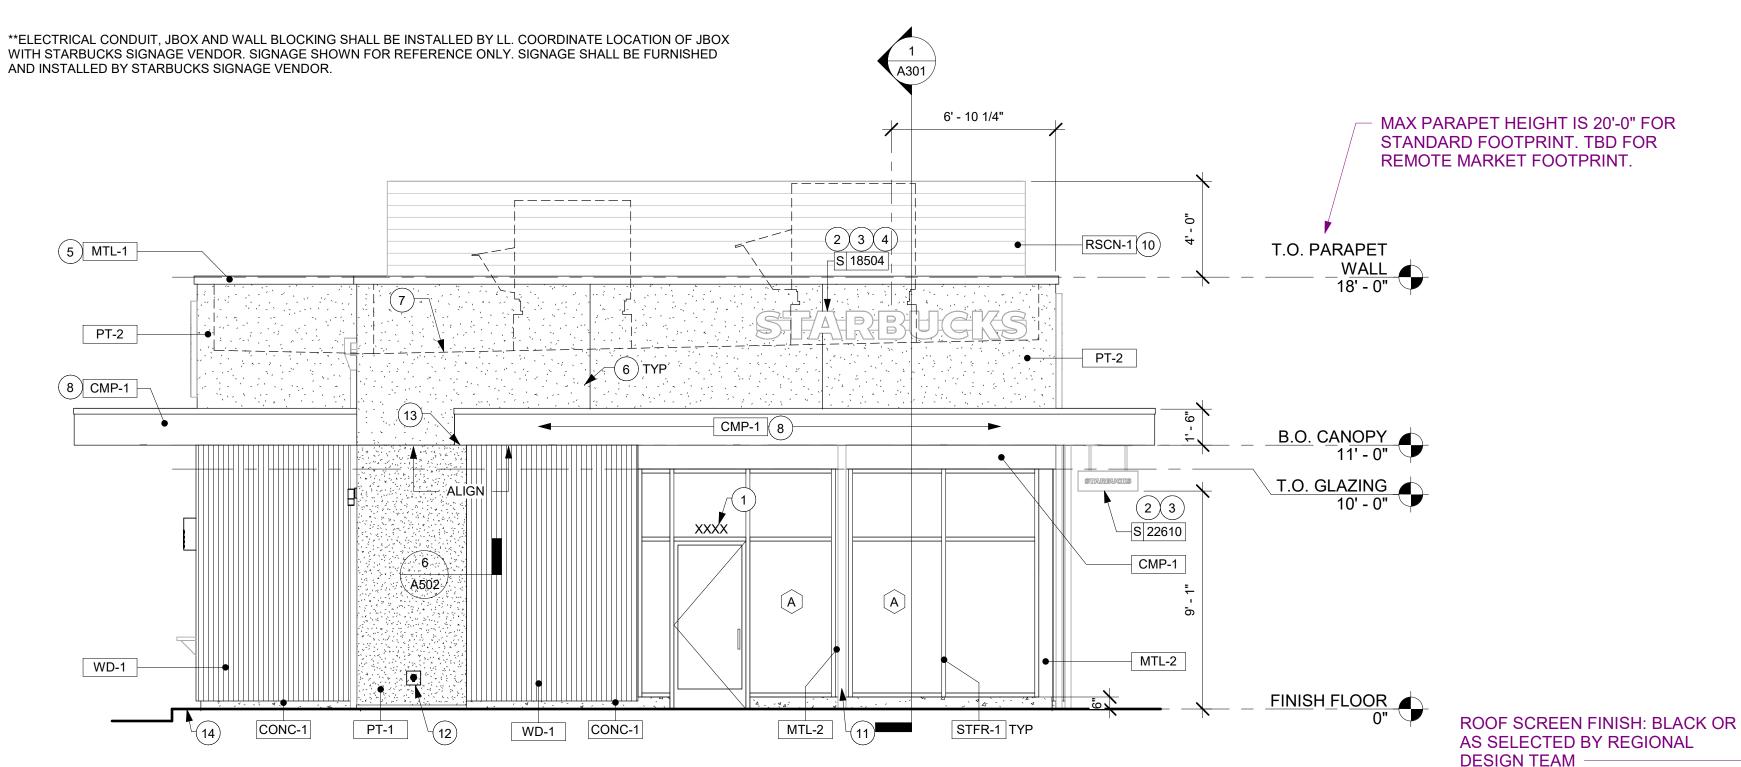
Revision Schedule

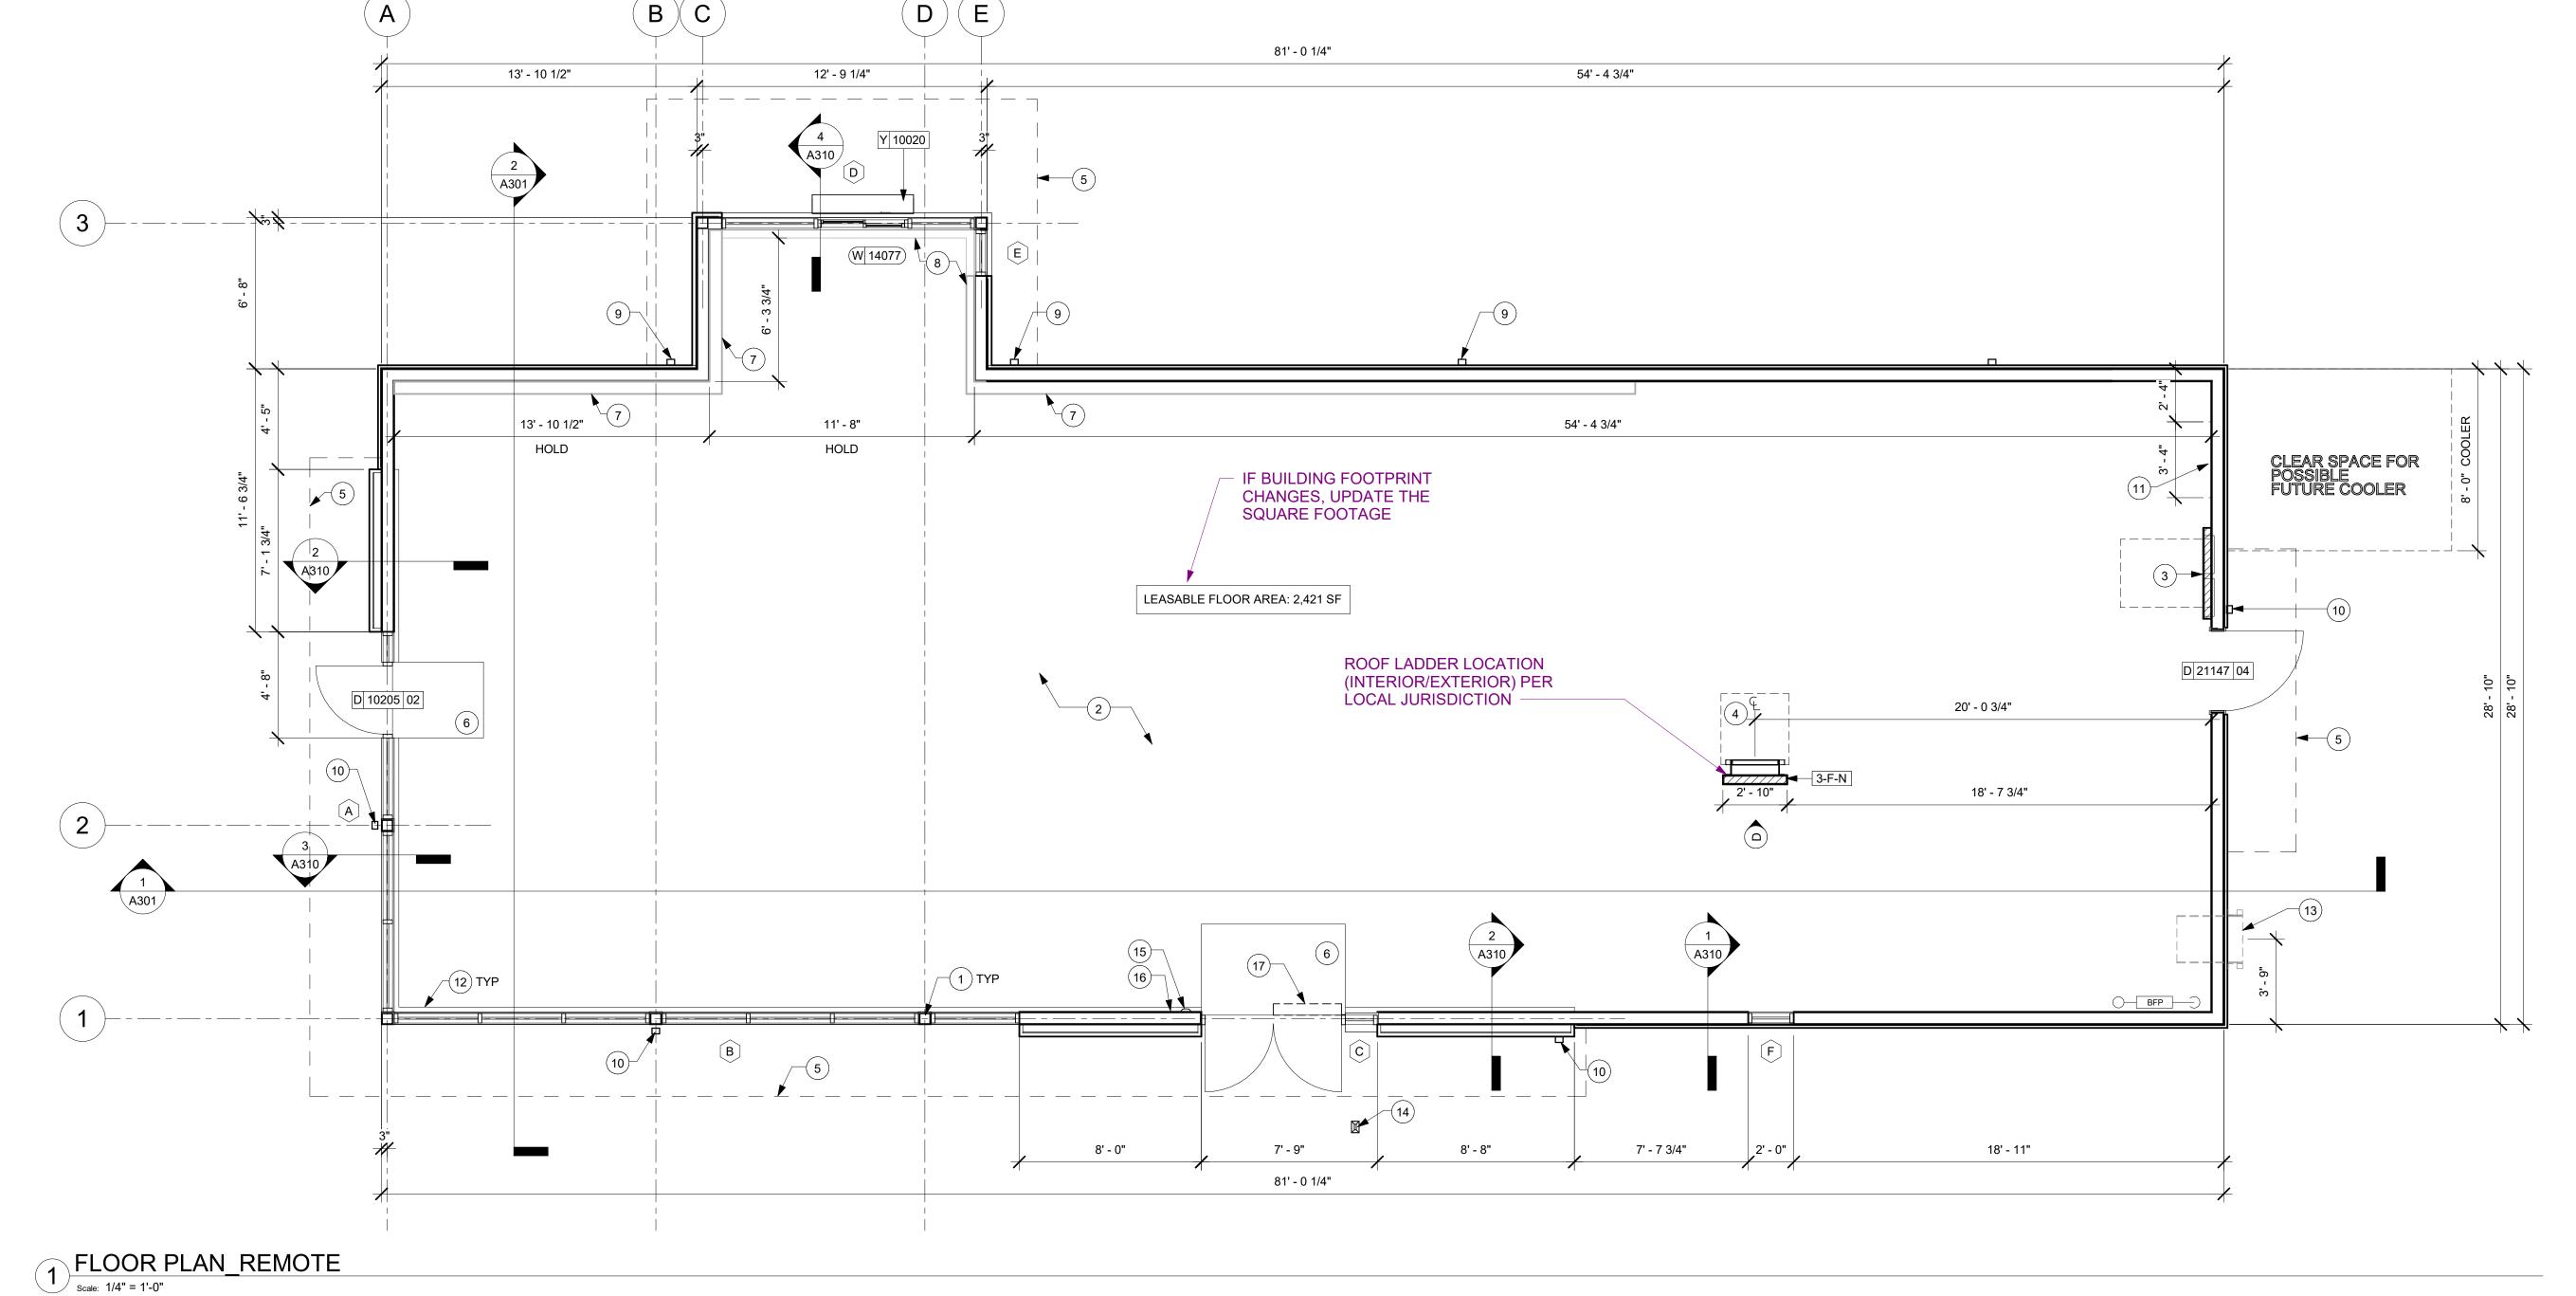BUILDING FLOOR

PLAN REMOTE SCALE: AS SHOWN SHEET NUMBER:

A101R





KEYED NOTES

- 1. PROVIDE 3" HIGH BLACK ACRYLIC STORE ADDRESS ON GLAZING OR PER LOCAL JURISDICTIONAL CODE
- REQUIREMENTS. 2. PROVIDE J-BOX FOR BUILDING SIGNAGE. COORDINATE LOCATION WITH SIGNAGE VENDOR SHOP DRAWINGS.
- 3. PROVIDE SIGNAGE DISCONNECT ON INSIDE FACE OF
- 4. 3/4" MARINE GRADE PLYWOOD BLOCKING FOR EXTERIOR SIGNAGE. EXTEND BLOCKING 8" MIN. BEYOND EDGE OF
- SIGNAGE.
- 5. PRE-FINISHED METAL COPING, TYPICAL. 6. EXTERIOR FINISH CONTROL JOINT.
- 7. OUTLINE OF ROOF BEYOND. 8. CANOPY. SEE BUILDING DETAIL SHEETS AND
- STRUCTURAL DRAWINGS. 9. EXTERIOR SCONCE LIGHTING.
- 10. ROOF EQUIPMENT SCREEN 11. DOWNSPOUT. CONNECT VERTICAL LEADERS TO UNDERGROUND STORM DRAIN. FINISH TO MATCH
- ADJACENT BUILDING FINISH. 12. LOCKABLE HOSE BIBB.
- 13. 6" CANOPY OVERHANG. 14. DRIVE-THRU BUMP OUT TO BE LOCATED 12"-14" OFF THE
- FACE OF THE INSIDE CURB. 15. DOOR ACTUATOR CONTROL PEDESTAL.

GENERAL NOTES


- A. GENERAL CONTRACTOR TO COORDINATE AND SCHEDULE SIGNAGE INSTALLATION WITH THE SIGNAGE CONTRACTOR PROVIDING A MINIMUM SCHEDULING NOTICE OF 4 WEEKS AND 1 WEEK PRIOR TO SCHEDULED DATE OF INSTALLATION. CONSTRUCTION MANAGER TO PROVIDE GENERAL CONTRACTOR WITH SIGNAGE CONTRACTOR CONTACT INFORMATION.
- B. GENERAL CONTRACTOR SHALL COORDINATE WITH ELECTRICAL CONTRACTOR TO FURNISH AND INSTALL ELECTRICAL CIRCUITS INCLUDING ALL CONDUIT, WIRE, CONNECTIONS AND BREAKER AT PANEL BOARD NECESSARY TO SERVE SIGNAGE.
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- D. SIGNAGE CONTRACTOR SHALL VERIFY SIZE AND LOCATION OF ANY AND ALL ALLOWABLE MONUMENT OR POLE SIGNAGE AND PROVIDE SHOP DRAWING(S) PRIOR TO FABRICATION TO THE STARBUCKS DESIGNER FOR
- E. SIGNAGE CONTRACTOR TO INSTALL SIGNAGE IN COMPLIANCE WITH LOCAL CODES AND OBTAIN PERMIT.
- F. SIGNAGE CONTRACTOR TO SUPPLY SHOP DRAWINGS TO CONSTRUCTION MANAGER AND TO THE GENERAL CONTRACTOR AS NEEDED. GENERAL CONTRACTOR TO NOTIFY CONSTRUCTION MANAGER IMMEDIATELY IF SHOP DRAWINGS OR INSTALLATION IS IN DISCREPANCY WITH ARCHITECTURAL DRAWINGS.
- G. SEE SHEET A602 FOR WINDOW AND DOOR TYPES.

MATERIALS SHOWN IN SCHEDULE ARE FOR EXTERIOR FINISH OPTION SHOWN ON THIS SHEET ONLY

EXTERIOR FINISHES SCHEDULE - WOOD/EIFS				
FINISH CODE	DESCRIPTION	COMMENTS		
	T			
CMP-1	COMPOSITE METAL PANELS	MATCH STOREFRONT		
CONC-1	FINISHED CONCRETE			
MTL-1	PREFINISHED COPING			
MTL-2	METAL - PREFINISHED BRAKE METAL	MATCH STOREFRONT		
PT-1	EIFS (COARSE)	STUCCO (ALTERNATE)		
PT-2	EIFS	STUCCO (ALTERNATE)		
RSCN-1	ROOF SCREEN PANEL	HORIZONTAL RIBBED PANEL BY ROOFSCREEN OR EQUAL		
STFR-1	PREFINISHED ALUMINUM STOREFRONT (COLOR - MATTE BLACK)	4 1/2" THERMALLY BROKEN		
WD-1	WOOD SIDING			

PATIO ENTRY WOOD/EIFS Scale: 1/4" = 1'-0"

> SITE ADAPT ARCHITECT TO REVIEW FINISHES W/ STARBUCKS DESIGN MANAGER AND LOCALLY SOURCE.

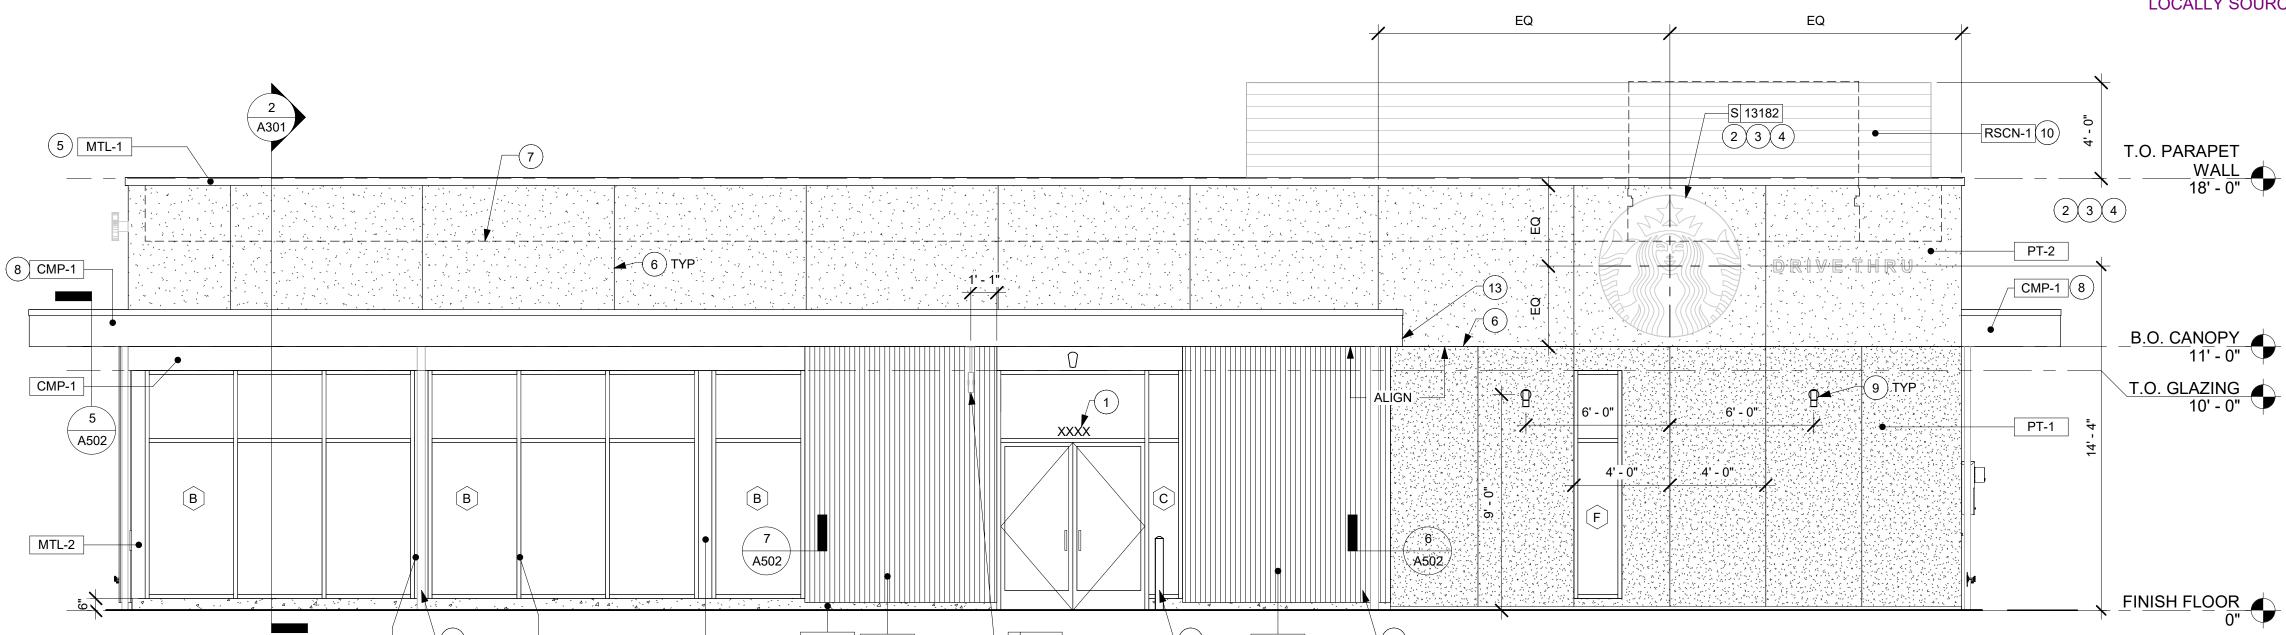

11 11 15 S 22610 WD-1 CONC-1 WD-1 MTL-2 MTL-2 STFR-1

MAIN ENTRY WOOD/EIFS Scale: 1/4" = 1'-0"

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Revision Schedule

EXTERIOR ELEVATIONS - WOOD/EIFS


SHEET NUMBER:

SCALE: AS SHOWN

A201

EXTERIOR SIGNAGE SCHEDULE - "S"					
DESIGN ID	COUNT	DESCRIPTION	FURN. BY	INST. BY	COMMENTS
SIGNAGE -	DISK				
13163	1	SIGN - DISK SF ILLUMINATED FLUSH MOUNTED EVOLVED - 48IN 1220MM	SB	SB	**
13182	1	SIGN - DISK SF ILLUMINATED FLUSH MOUNTED EVOLVED - 71IN 1805MM	SB	SB	**
SIGNAGE -	DRIVE THR	Ú	•		
x1600	2	6" PIN MOUNTED DRIVE-THRU SIGN LETTERS	SB	SB	**
SIGNAGE -	WORDMAR	K	1		
18504	1	SIGN - WORDMARK STARBUCKS ON RACEWAY - 14IN 355MM	SB	SB	WHITE LETTERS**
22610	1	SIGN - WORDMARK BLADE SUSPENDED - HORIZONTAL - 30X10IN 760X255MM	SB	SB	**

**ELECTRICAL CONDUIT, JBOX AND WALL BLOCKING SHALL BE INSTALLED BY LL. COORDINATE LOCATION OF JBOX WITH STARBUCKS SIGNAGE VENDOR. SIGNAGE SHOWN FOR REFERENCE ONLY. SIGNAGE SHALL BE FURNISHED AND INSTALLED BY STARBUCKS SIGNAGE VENDOR.

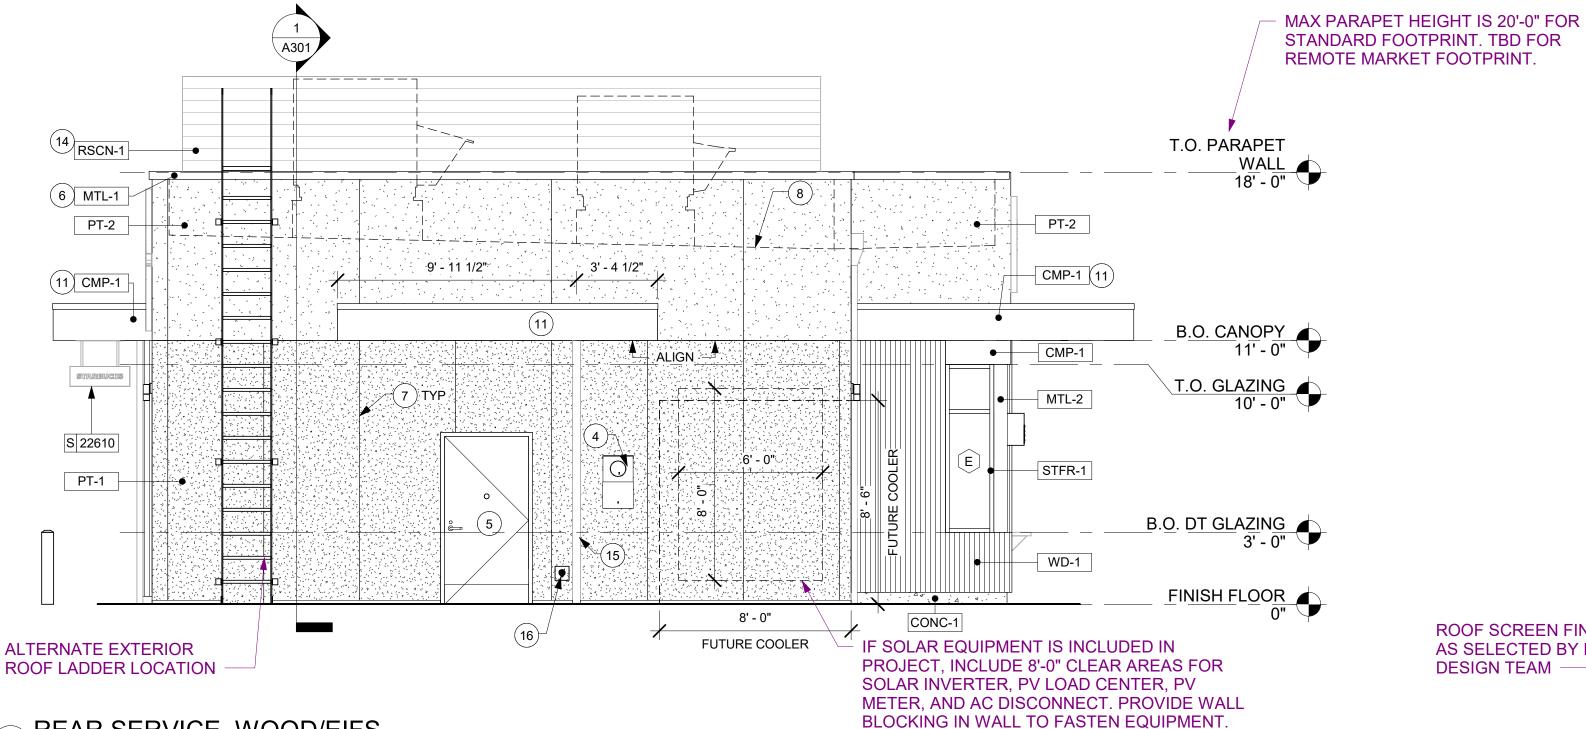

KEYED NOTES

- 1. PROVIDE J-BOX FOR BUILDING SIGNAGE. COORDINATE LOCATION WITH SIGNAGE VENDOR SHOP DRAWINGS. 2. PROVIDE SIGNAGE DISCONNECT ON INSIDE FACE OF
- 3. 3/4" MARINE GRADE PLYWOOD BLOCKING FOR EXTERIOR SIGNAGE. EXTEND BLOCKING 8" (205MM) MIN. BEYOND
- EDGE OF SIGNAGE. ELECTRICAL METER.
- 5. SERVICE DOOR. 6. PRE-FINISHED METAL COPING, TYPICAL.
- 7. EXTERIOR FINISH CONTROL JOINT. 8. OUTLINE OF ROOF BEYOND.
- 9. DT WINDOW. PROVIDE READY ACCESS DT SERVICE WINDOW. WINDOW AND AIR CURTAIN FINISH TO MATCH ADJACENT STOREFRONT.
- 10. DT WINDOW SHELF. INSTALL SERVICE WINDOW SHELF AT 36" INSIDE.
- 11. CANOPY. SEE BUILDING DETAIL SHEETS AND
- STRUCTURAL DRAWINGS. 12. ROOF SCUPPER AND DOWNSPOUT. CONNECT VERTICAL

LEADERS TO UNDERGROUND STORM DRAIN.

- 13. EXTERIOR SCONCE LIGHTING.
- 14. ROOF EQUIPMENT SCREEN. 15. CANOPY DOWNSPOUT. CONNECT VERTICAL LEADERS TO
- UNDERGROUND STROM DRAIN. 16. LOCKABLE HOSE BIB.

ROOF SCREEN FINISH: BLACK OR

AS SELECTED BY REGIONAL

DESIGN TEAM

GENERAL NOTES

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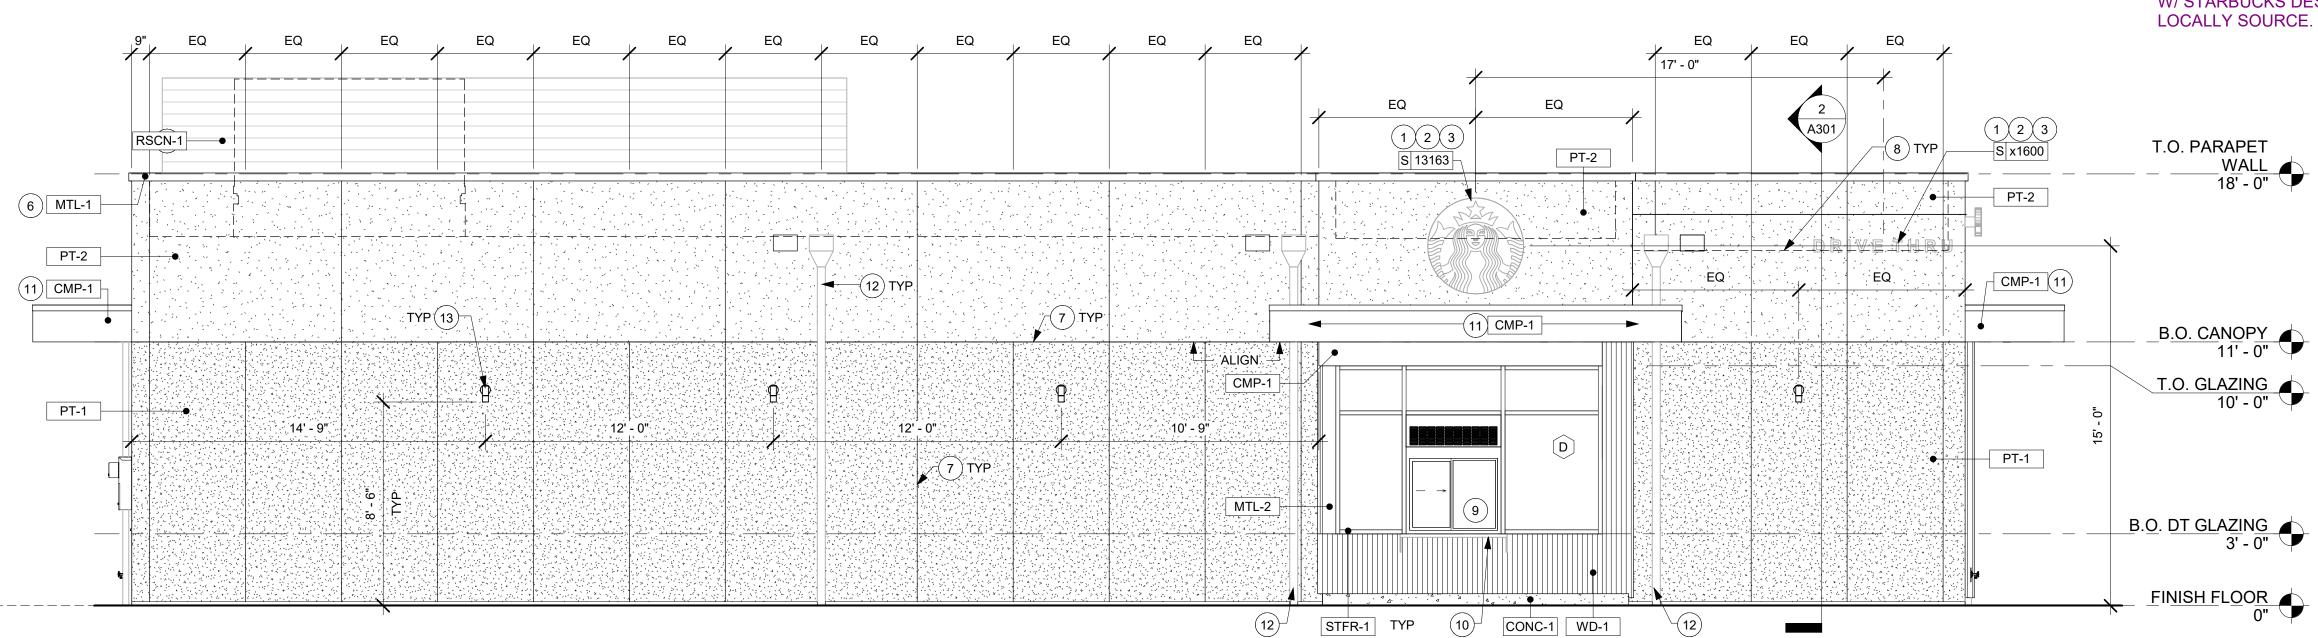
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MTL-1	PREFINISHED COPING				
MTL-2	METAL - PREFINISHED BRAKE METAL	MATCH STOREFRONT			
PT-1	EIFS (COARSE)	STUCCO (ALTERNATE)			
PT-2	EIFS	STUCCO (ALTERNATE)			
RSCN-1	ROOF SCREEN PANEL	HORIZONTAL RIBBED PANEL BY ROOFSCREEN OR EQUAL			
STFR-1	PREFINISHED ALUMINUM STOREFRONT (COLOR - MATTE BLACK)	4 1/2" THERMALLY BROKEN			
WD-1	WOOD SIDING				

REAR SERVICE WOOD/EIFS

Scale: 1/4" = 1'-0"

SITE ADAPT ARCHITECT TO REVIEW FINISHES W/ STARBUCKS DESIGN MANAGER AND



DRIVE THRU WOOD/EIFS

/ Scale: 1/4" = 1'-0"

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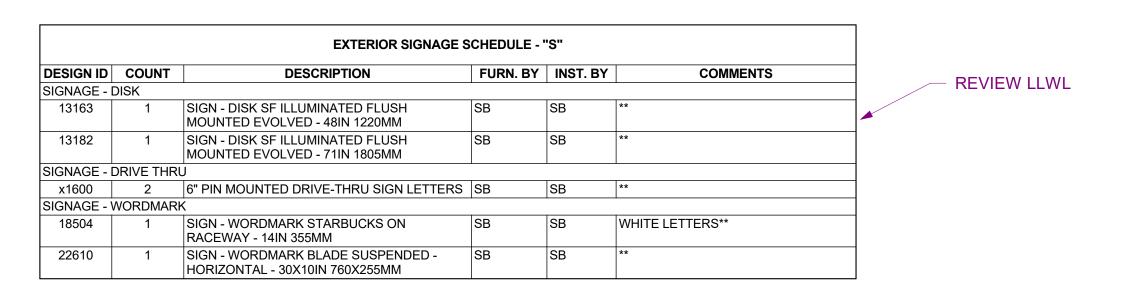
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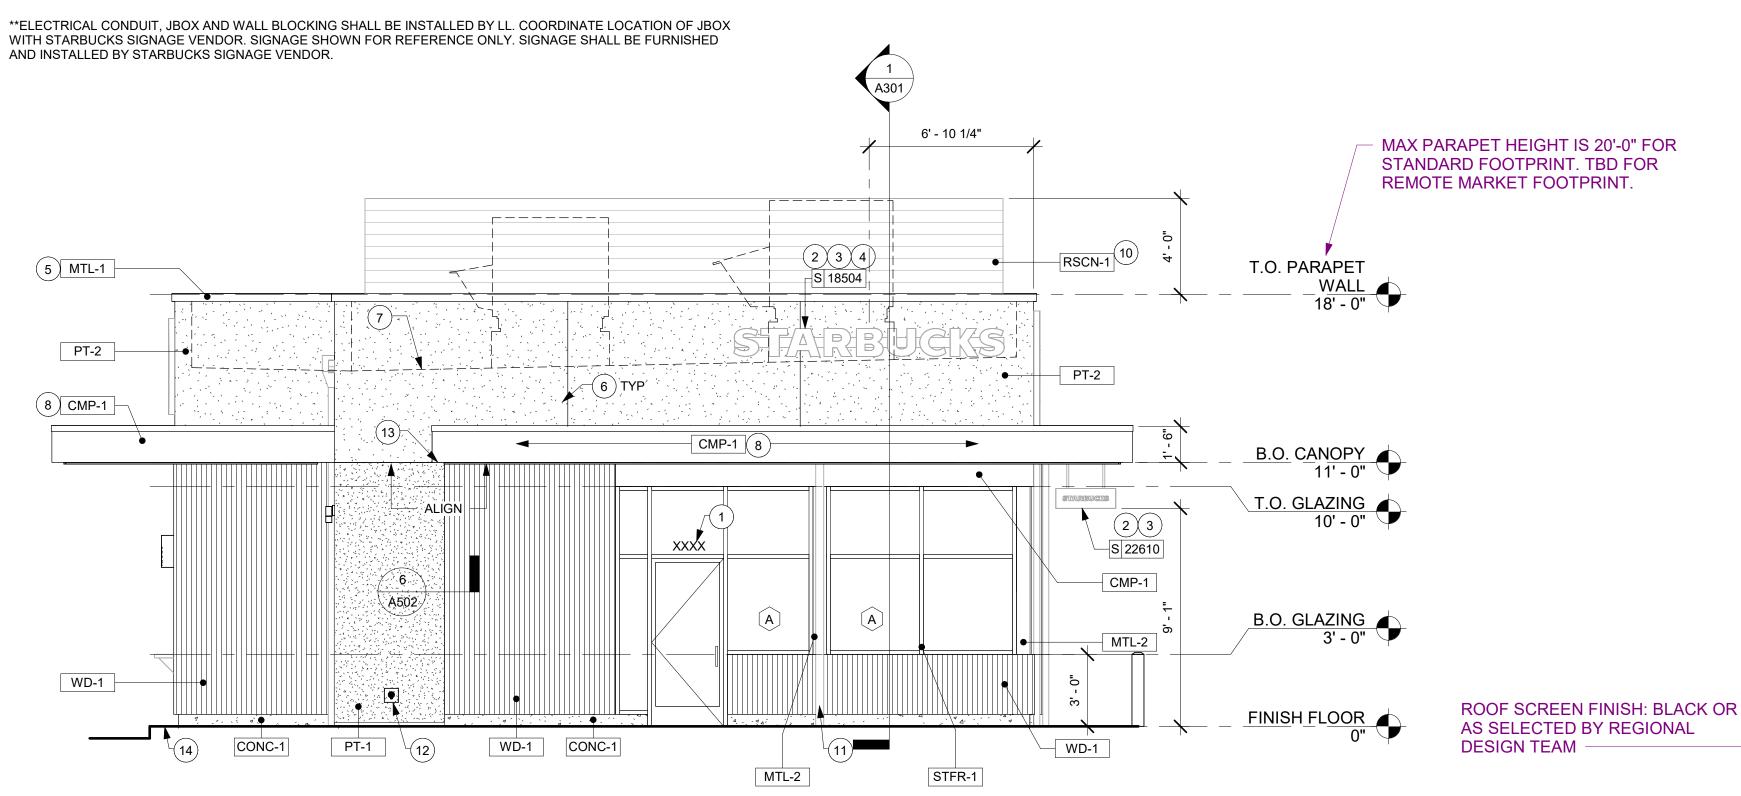
Revision Schedule S

EXTERIOR ELEVATIONS - WOOD/EIFS SCALE: AS SHOWN

SHEET NUMBER:

A202





MTL-2

KEYED NOTES

- 1. PROVIDE 3" HIGH BLACK ACRYLIC STORE ADDRESS ON GLAZING OR PER LOCAL JURISDICTIONAL CODE
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- 7. OUTLINE OF ROOF BEYOND.
- 8. CANOPY. SEE BUILDING DETAIL SHEETS AND STRUCTURAL DRAWINGS.
- 9. EXTERIOR SCONCE LIGHTING.

6. EXTERIOR FINISH CONTROL JOINT.

- 10. ROOF EQUIPMENT SCREEN
- 11. DOWNSPOUT. CONNECT VERTICAL LEADERS TO UNDERGROUND STORM DRAIN. FINISH TO MATCH ADJACENT BUILDING FINISH.
- 12. LOCKABLE HOSE BIBB.
- 13. 6" CANOPY OVERHANG.
- 14. DRIVE-THRU BUMP OUT TO BE LOCATED 12"-14" OFF THE FACE OF THE INSIDE CURB.
- 15. DOOR ACTUATOR CONTROL PEDESTAL.

GENERAL NOTES


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EXTERIOR FINISHES SCHEDULE - WOOD/EIFS					
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WD-1	WOOD SIDING				

PATIO ENTRY_WOOD/EIFS

| Scale: 1/4" = 1'-0"



MAIN ENTRY_WOOD/EIFS

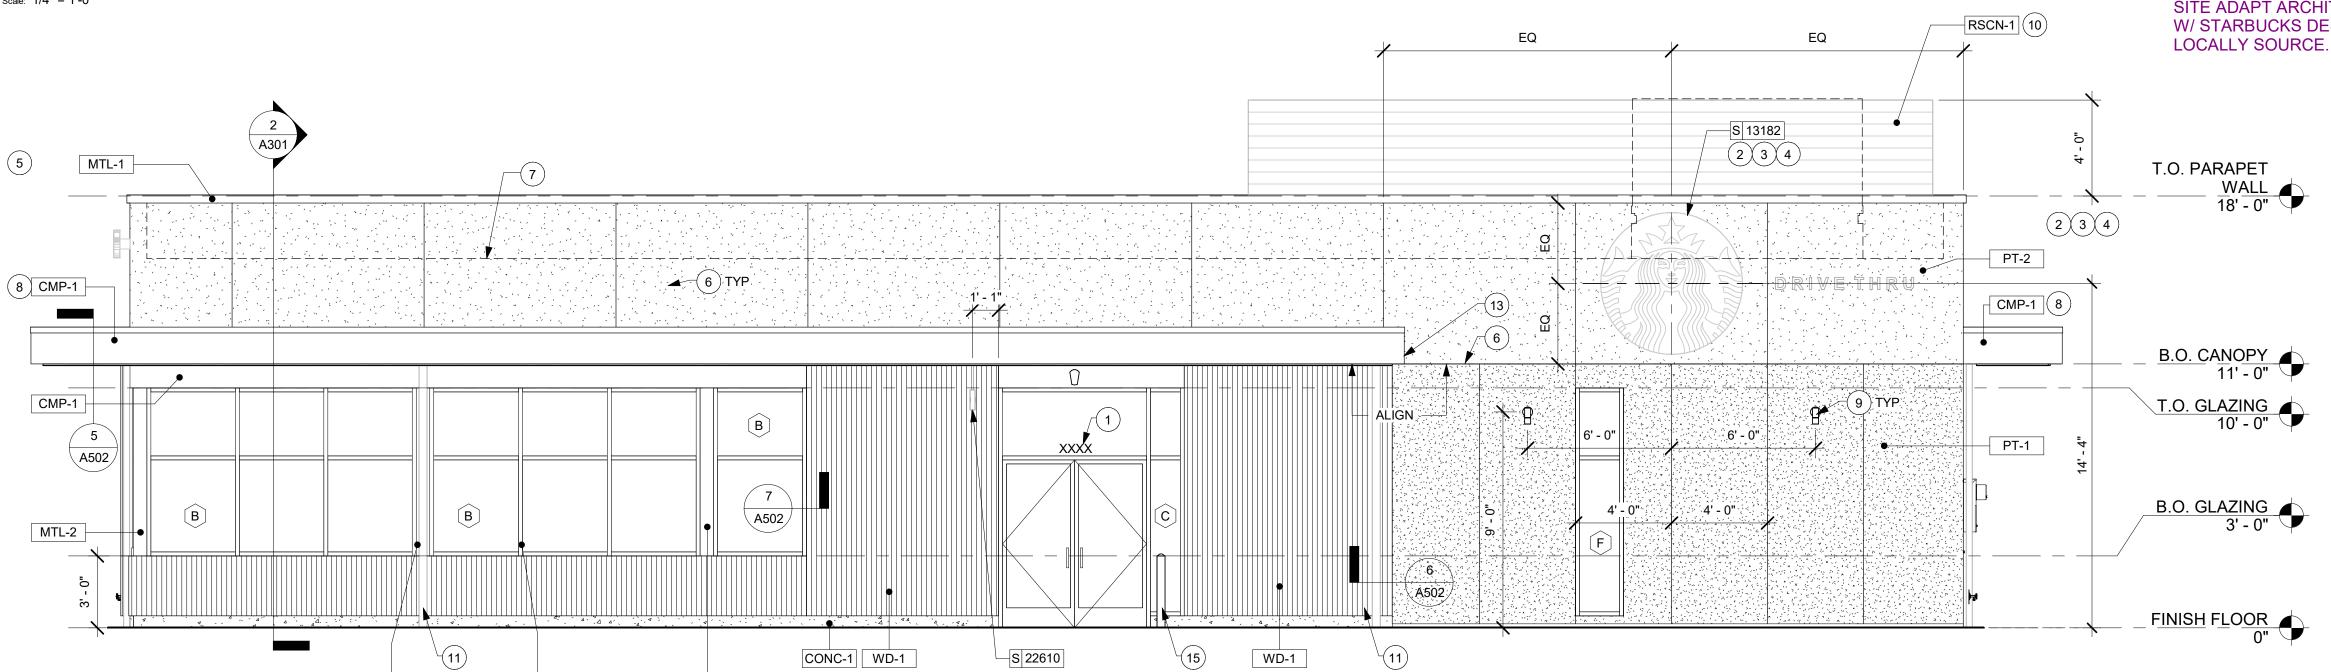Scale: 1/4" = 1'-0"

MTL-2

STFR-1

SITE ADAPT ARCHITECT TO REVIEW FINISHES W/ STARBUCKS DESIGN MANAGER AND

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STORE #: TBD PROJECT #:

SSUE DATE: DESIGN MANAGER: PRODUCTION DESIGNER: CHECKED BY:

Revision Schedule

EXTERIOR ELEVATIONS

- KNEE WALL SCALE: AS SHOWN

SHEET NUMBER:

A203

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