LEWIS LANDING


PROPOSED MULTI-UNIT RESIDENTIAL DEVELOPMENT HUTTLESTON AVE. FAIRHAVEN, MASSACHUSETTS

APPLICANT/OWNER:

DANA LEWIS 18 TANNER LANE FAIRHAVEN, MA 02719

LOCUS:

MAP 31 - LOT 117C AND LOT 115A HUTTLESTON AVENUE FAIRHAVEN, MA

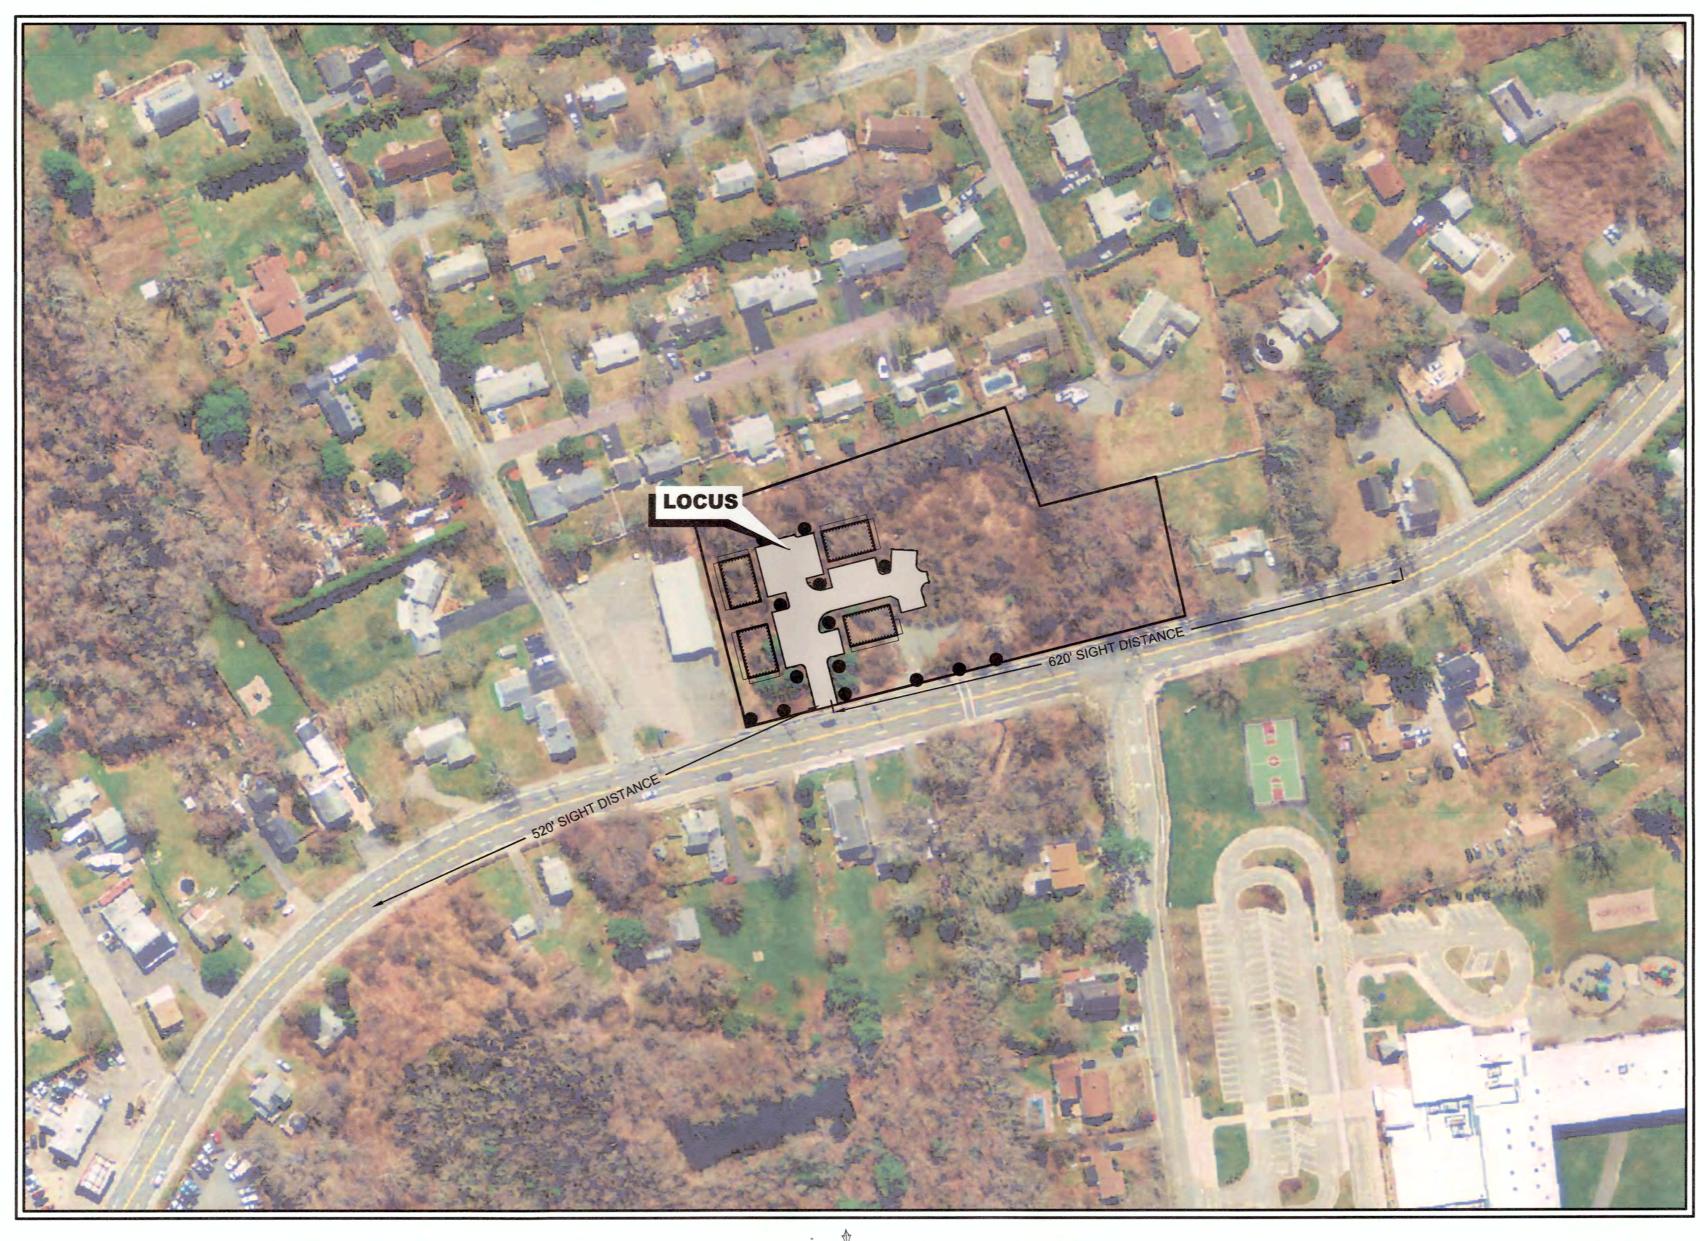

SCHEDULE OF DRAWINGS

SHEET	NUMBER	PLAN	IIILE
-		COVER SHE	ET
1		EXISTING CO	ONDITIONS PLAN
2		SITE LAYOU	T AND LANDSCAPING PLAN
3		GRADING &	UTILITIES PLAN
4		EROSION CO	ONTROL PLAN
5		DETAIL SHE	ET-1
6		DETAIL SHE	ET-2
7		ARCHITECT	URALS

PLANNING BOARD WAIVERS REQUESTED FOR STORMWATER MANAGEMENT REGULATIONS

- 1. FAIRHAVEN ZONING BYLAW 198-31.1 (C) (2) (g) [6] REQUIRING BASINS AND PONDS TO HAVE 4:1 SIDE SLOPES AND SEDIMENT FOREBAYS TO HAVE 3:1 SIDE SLOPES.
 - FAIRHAVEN ZONING BYLAW 198-31.1 (A) (1) (a) [2] ALLOWING NO INCREASE IN THE 10-YEAR STORM RUNOFF VOLUME DUE TO SOILS UNSUITABLE FOR INFILTRATION.






CIVIL ENGINEERING—LAND SURVEYING—ENVIRONMENTAL ASSESSMENT P.O. BOX 1088, 350 BEDFORD STREET, LAKEVILLE, MA 02347 TEL: 508.947.0050 FAX: 508.947.2004





SCALE: 1"=100"

SEPTEMBER 9, 2019

REVISED JULY 8, 2020

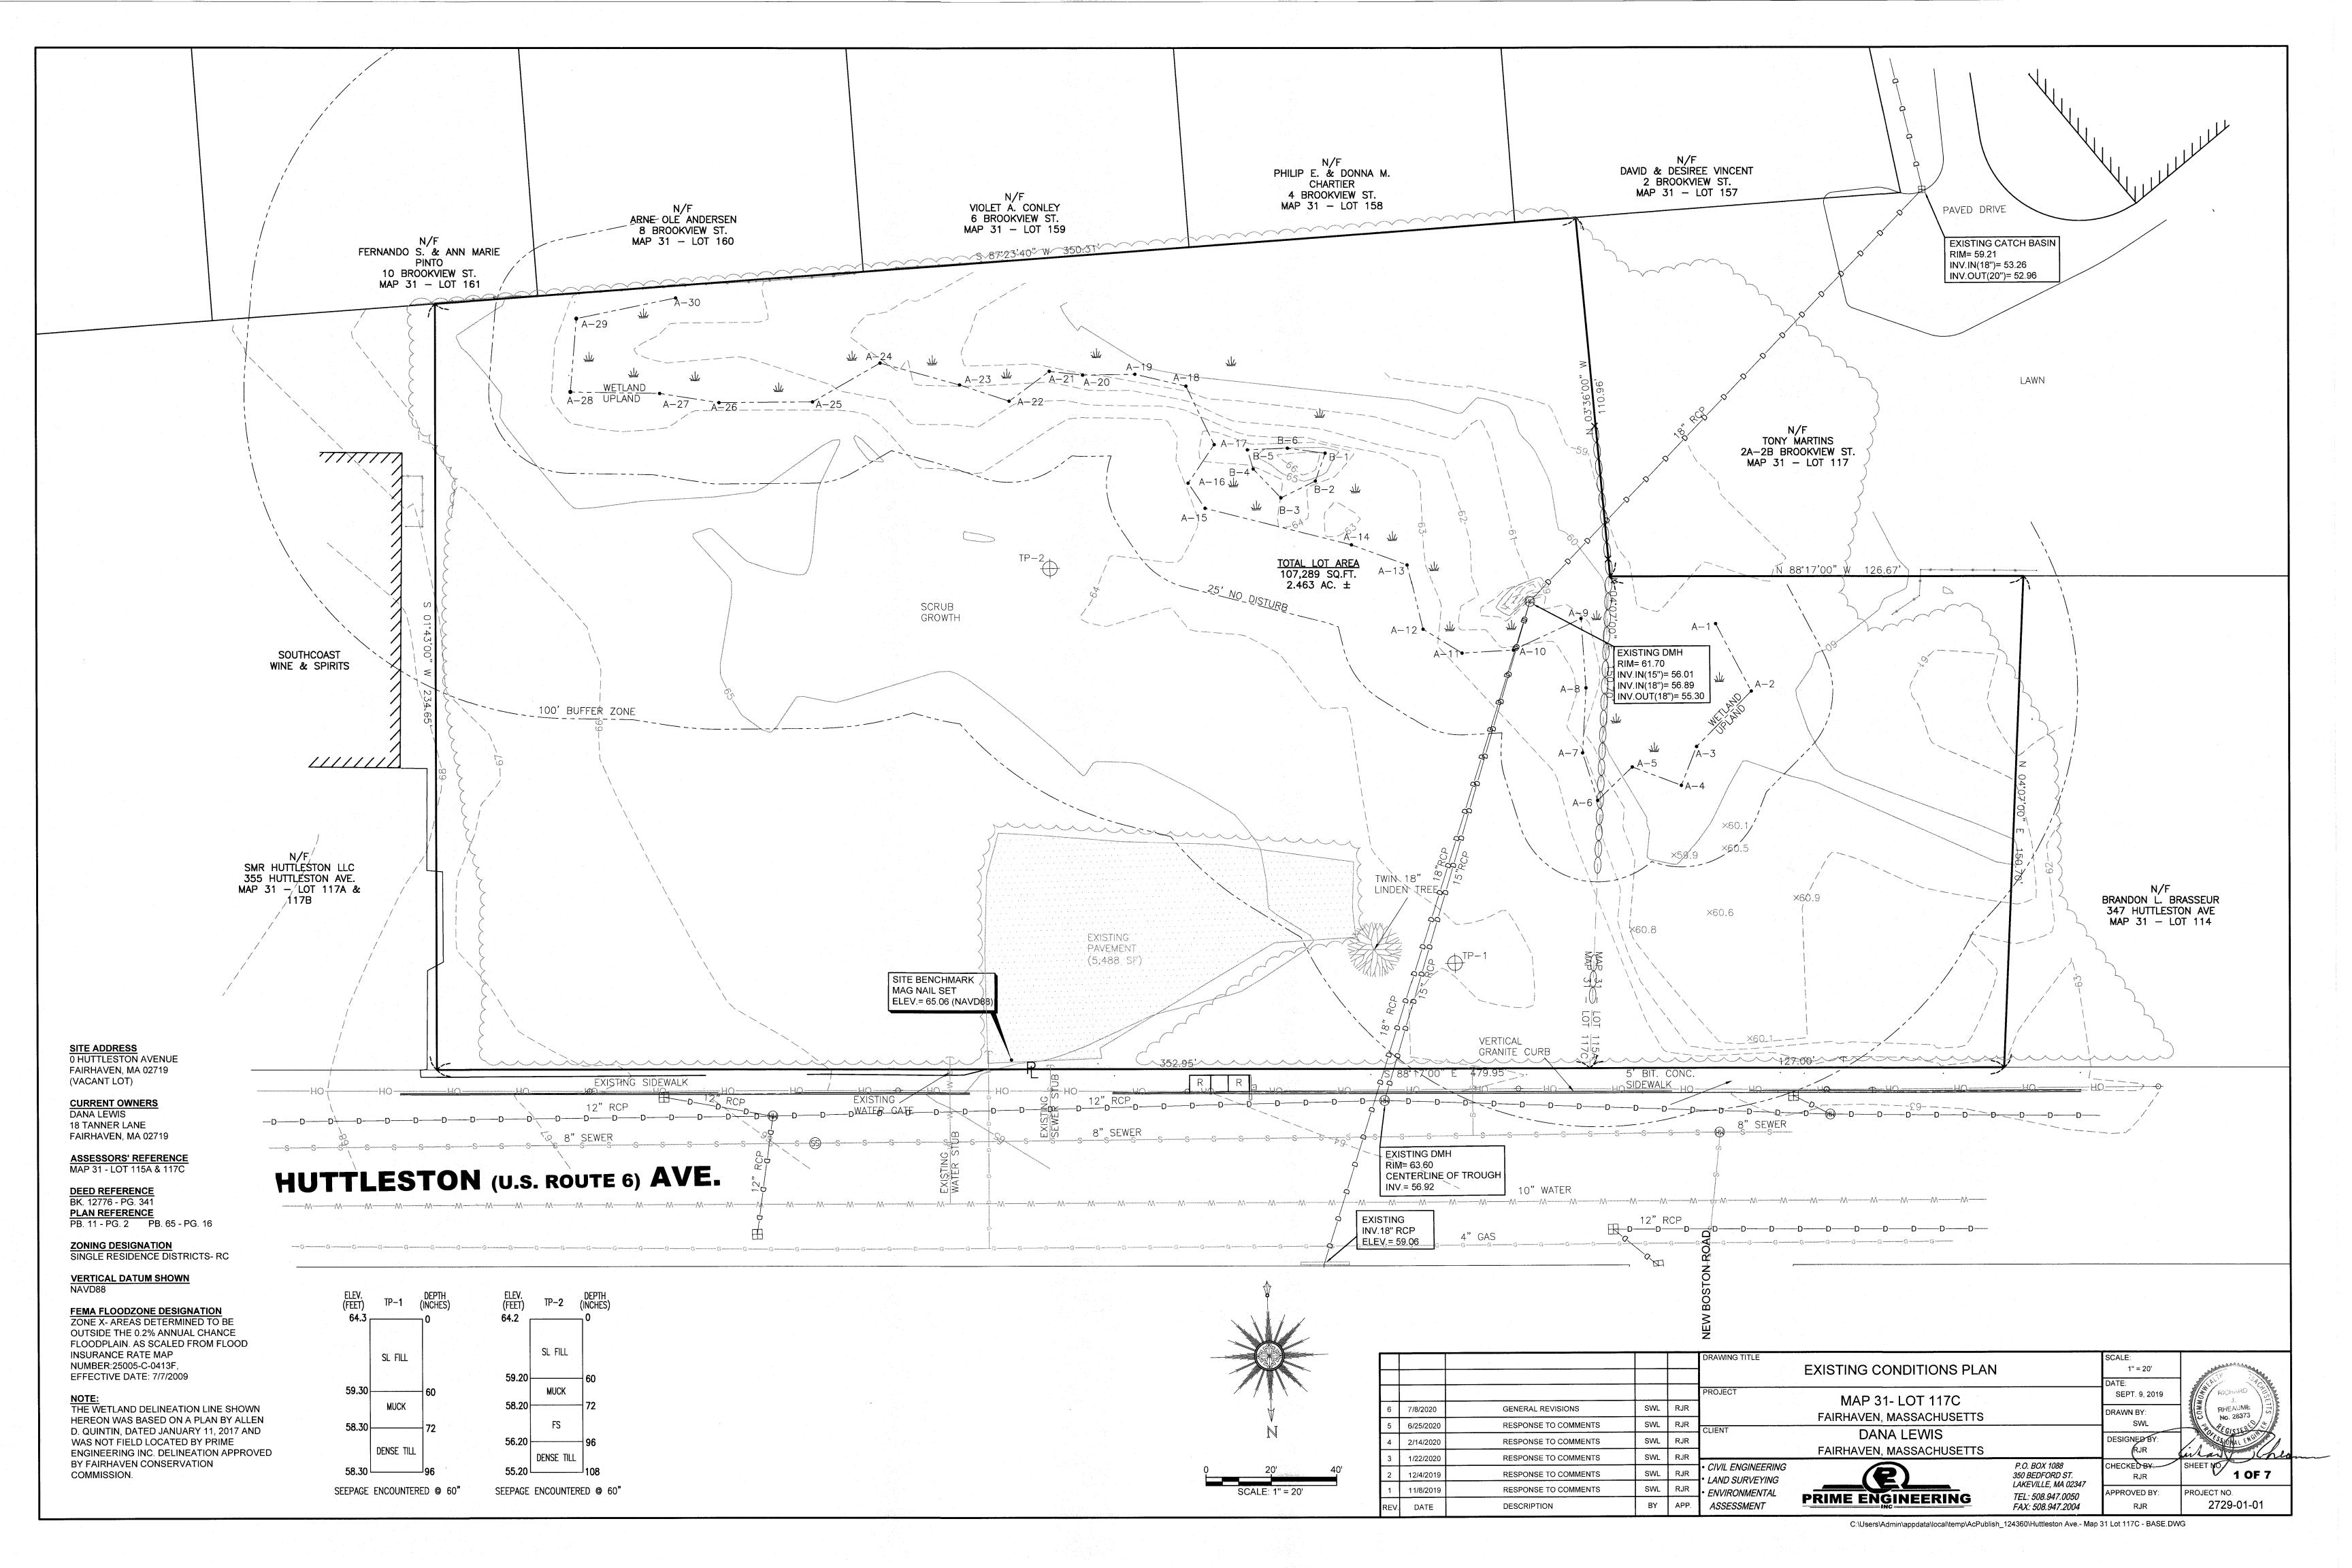

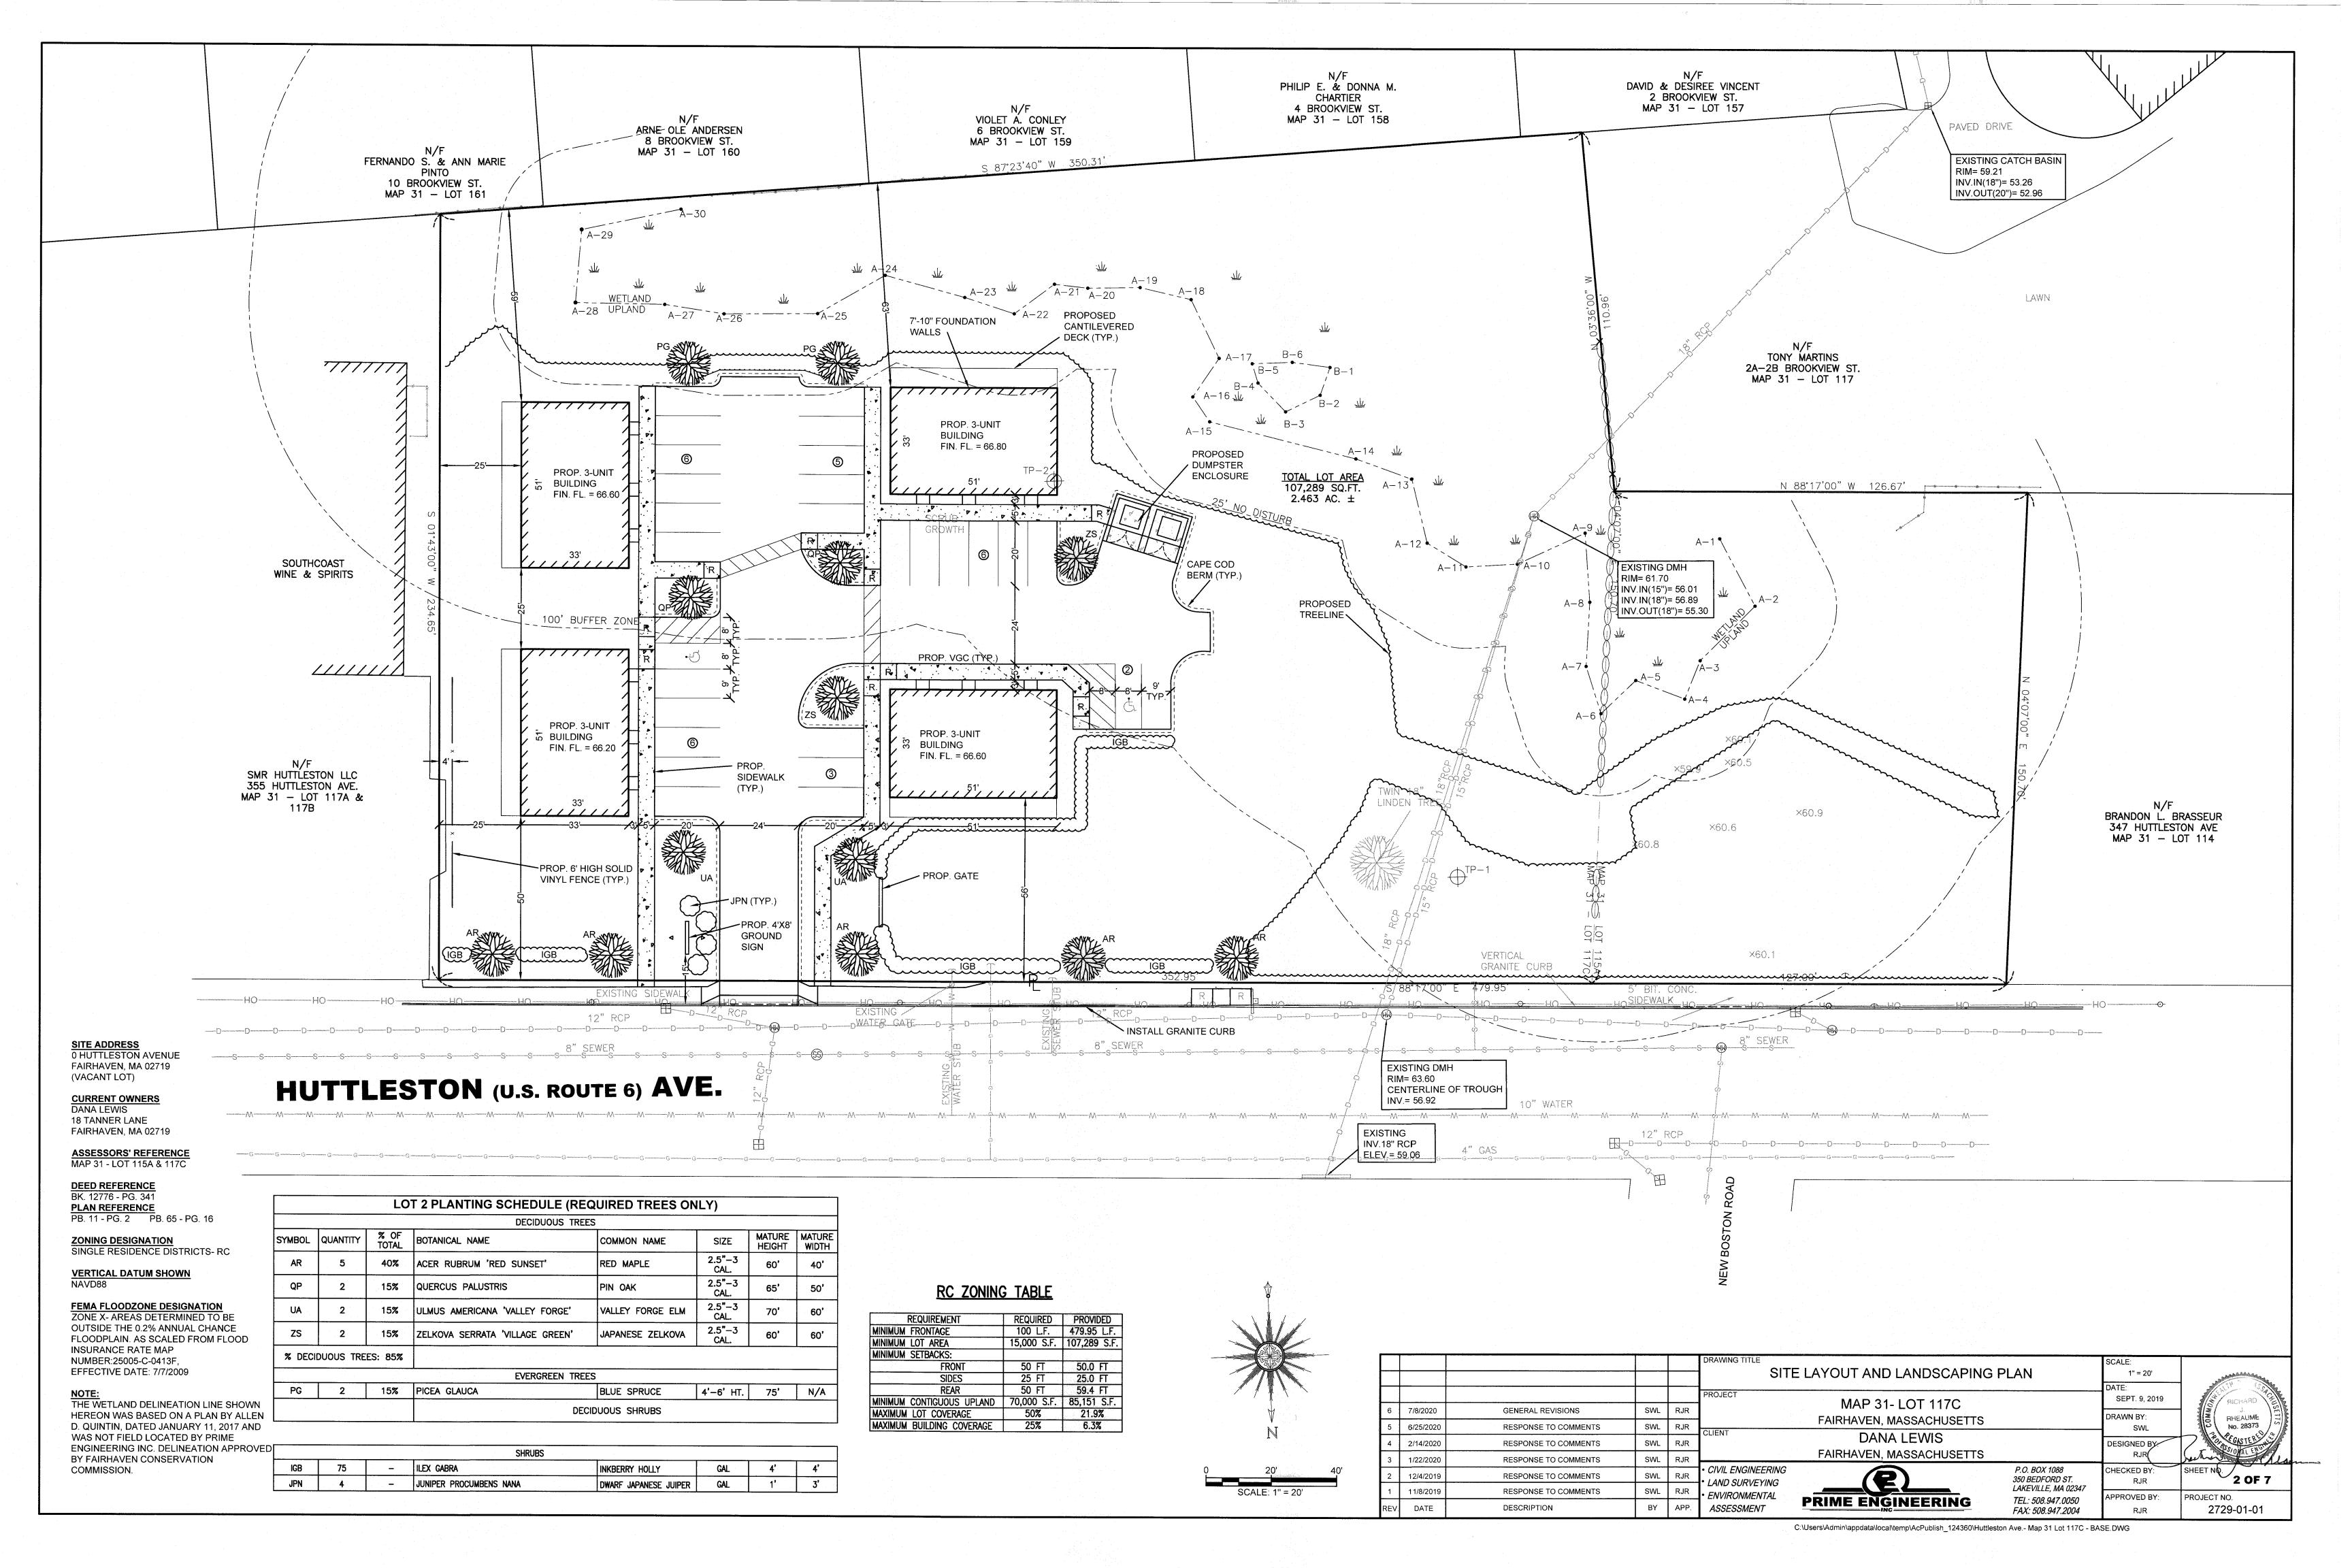

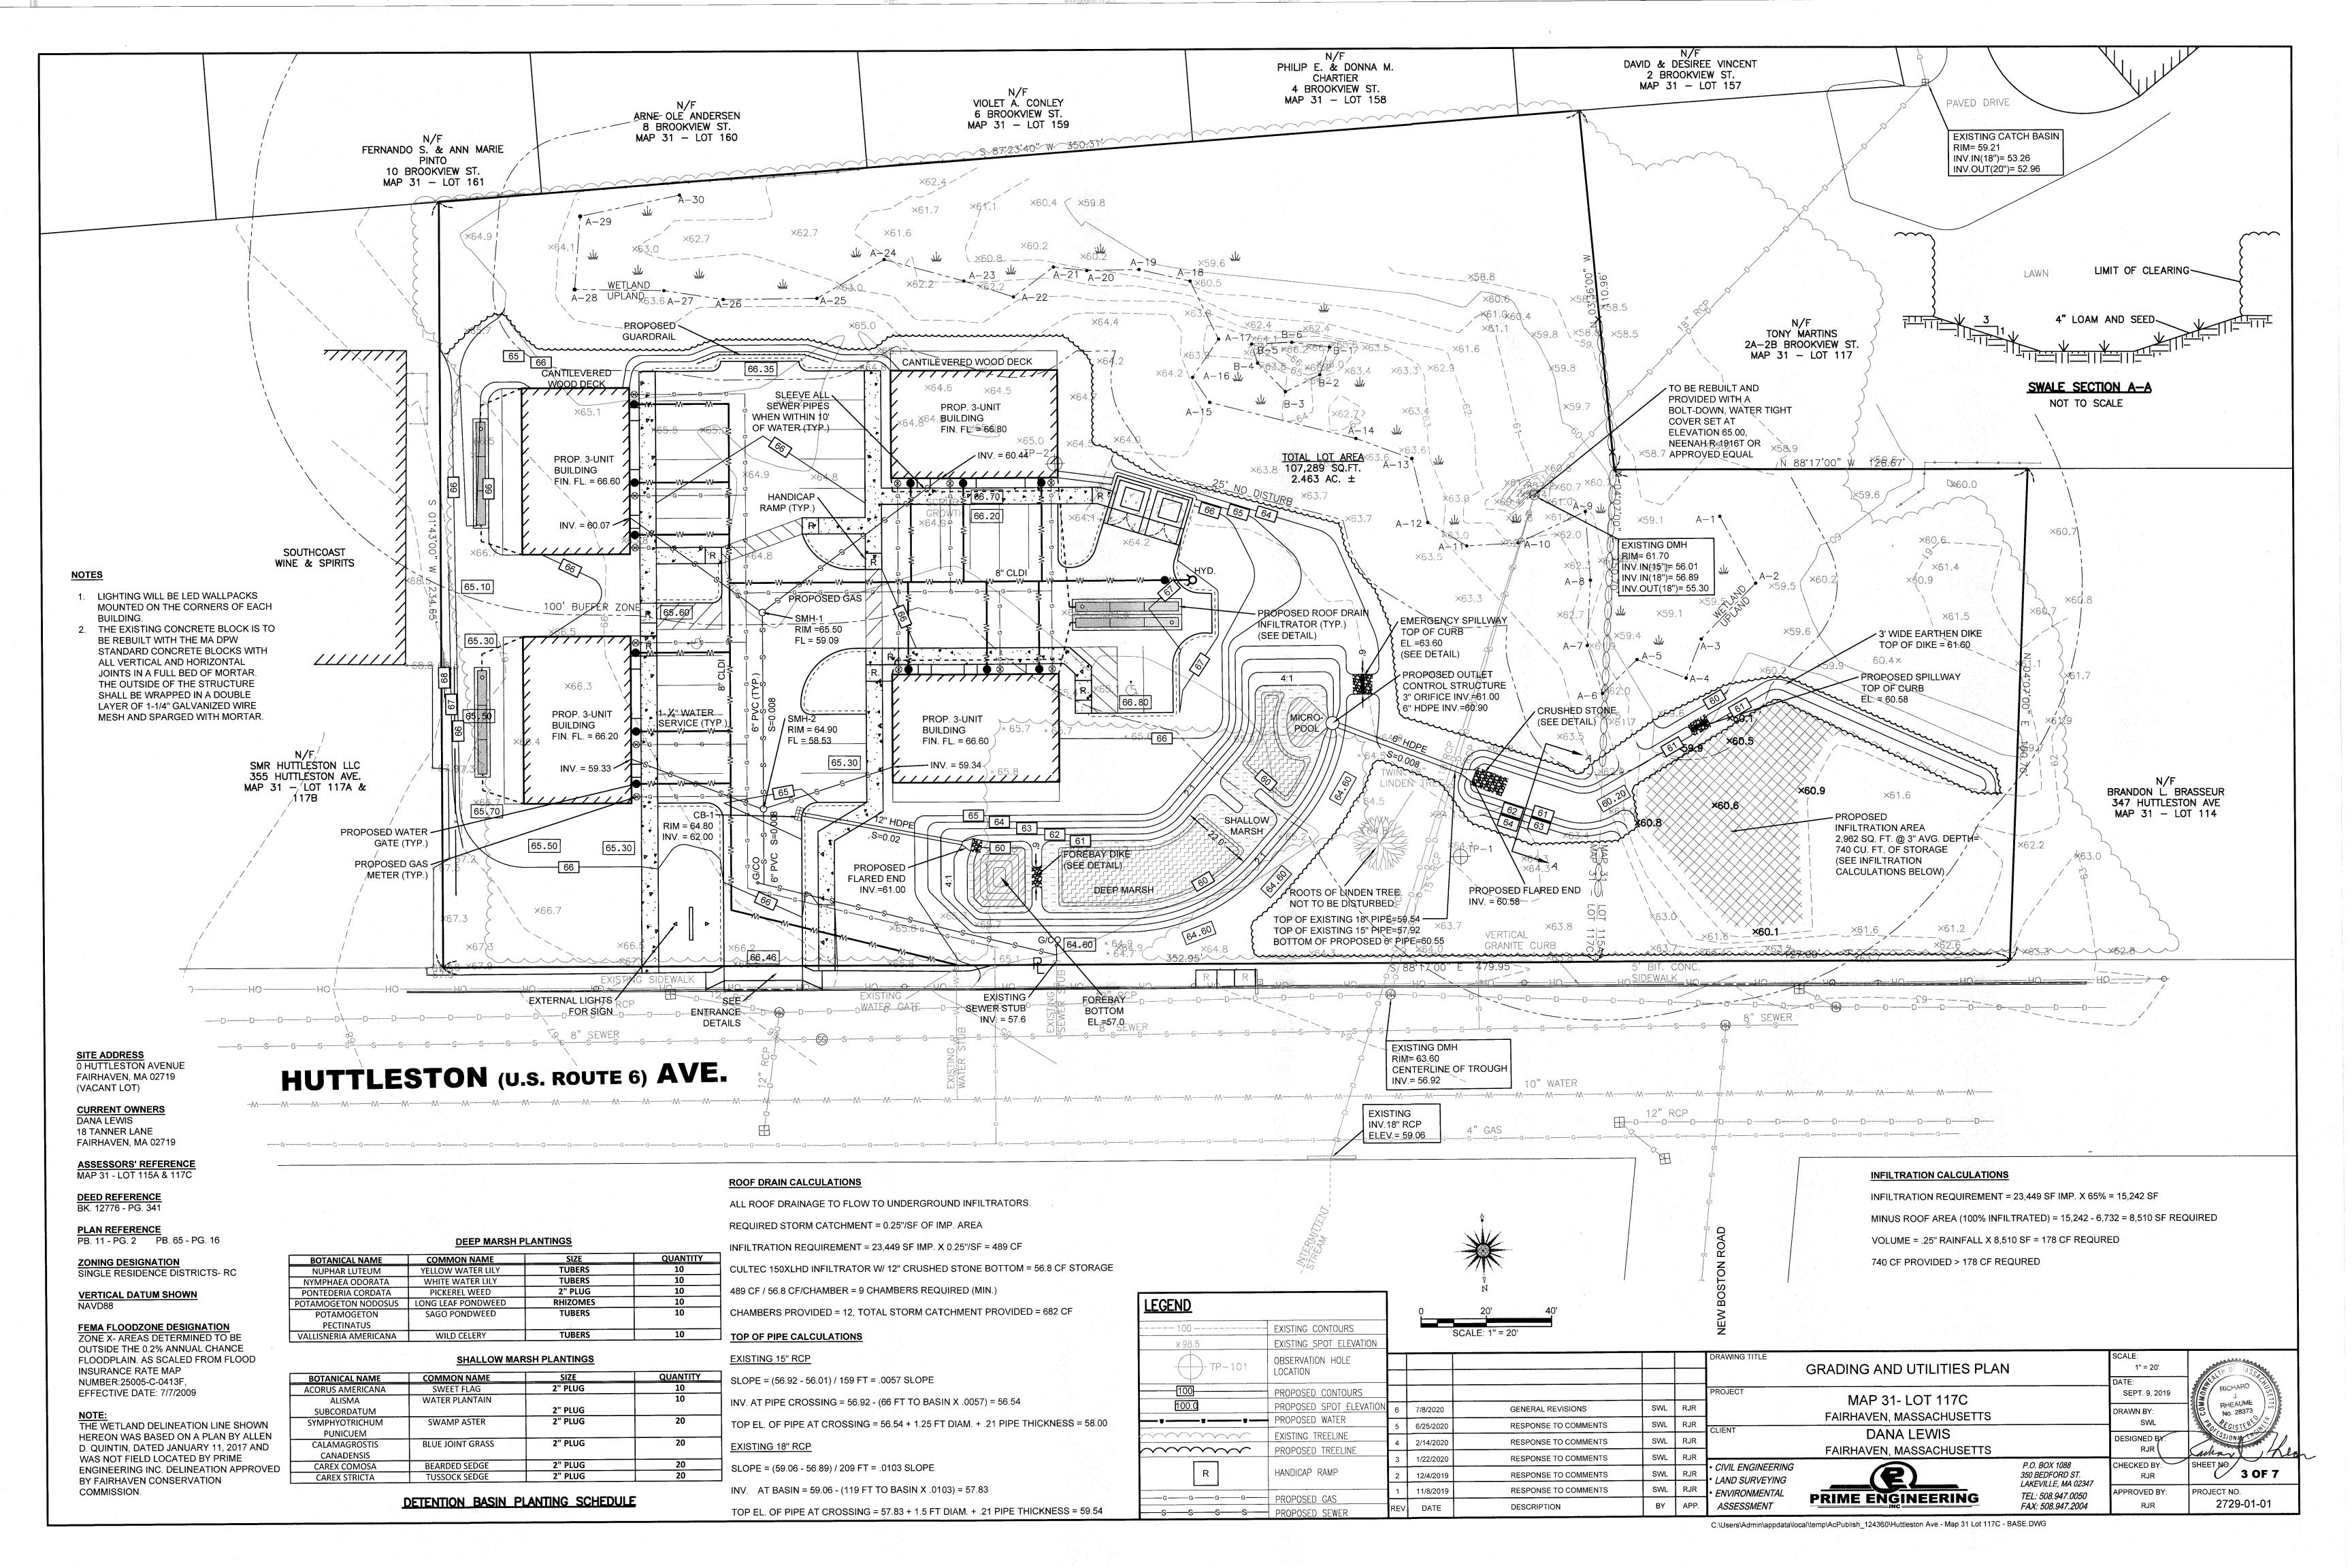


EROSION & SEDIMENT CONTROL NOTES

- THE FOLLOWING IS THE MINIMUM REQUIREMENTS THE CONTRACTOR SHALL FOLLOW TO PREVENT IMPACTS CAUSED BY EROSION AND SEDIMENTATION DURING CONSTRUCTION. THE CONTRACTOR MAY, AT HIS DISCRETION, IMPLEMENT ADDITIONAL MEASURES IF NECESSARY.
- EROSION AND SEDIMENT CONTROL MEASURES WILL BE INSTALLED PRIOR TO STUMP REMOVAL AND CONSTRUCTION. STABILIZATION OF ALL REGRADED AND SOIL STOCKPILE AREAS WILL BE INITIATED AND MAINTAINED DURING ALL PHASES OF CONSTRUCTION.
- LOCAL MUNICIPAL REGULATIONS. ALL EROSION CONTROL MEASURES ARE TO BE MAINTAINED AND UPGRADED AS REQUIRED TO ACHIEVE PROPER SEDIMENT CONTROL DURING CONSTRUCTION. A STAKED STRAW BALE DAM SHALL BE INSTALLED DOWN GRADIENT OF ALL DRAINAGE OUTFALLS.

2. ALL EROSION AND SEDIMENT CONTROL MEASURES WILL BE CONSTRUCTED IN ACCORDANCE WITH

- 3. ADDITIONAL CONTROL MEASURES WILL BE INSTALLED DURING THE CONSTRUCTION PERIOD, IF DEEMED NECESSARY BY THE OWNER OR AGENTS OF THE OWNER.
- 4. CATCH BASINS WILL BE PROTECTED WITH STRAW BALE FILTERS THROUGHOUT THE CONSTRUCTION PERIOD UNTIL ALL DISTURBED AREAS ARE THOROUGHLY STABILIZED. FILTER FABRIC SHOULD BE INSTALLED UNDER GRATE OPENING UNTIL PAVEMENT IS IN PLACE AND GROUND SURFACE IS
- 5. SEEDING MIXTURE FOR FINISHED GRASSED AREAS WILL BE AS FOLLOWS:
 - KENTUCKY BLUE GRASS CREEPING RED FESCUE 45%

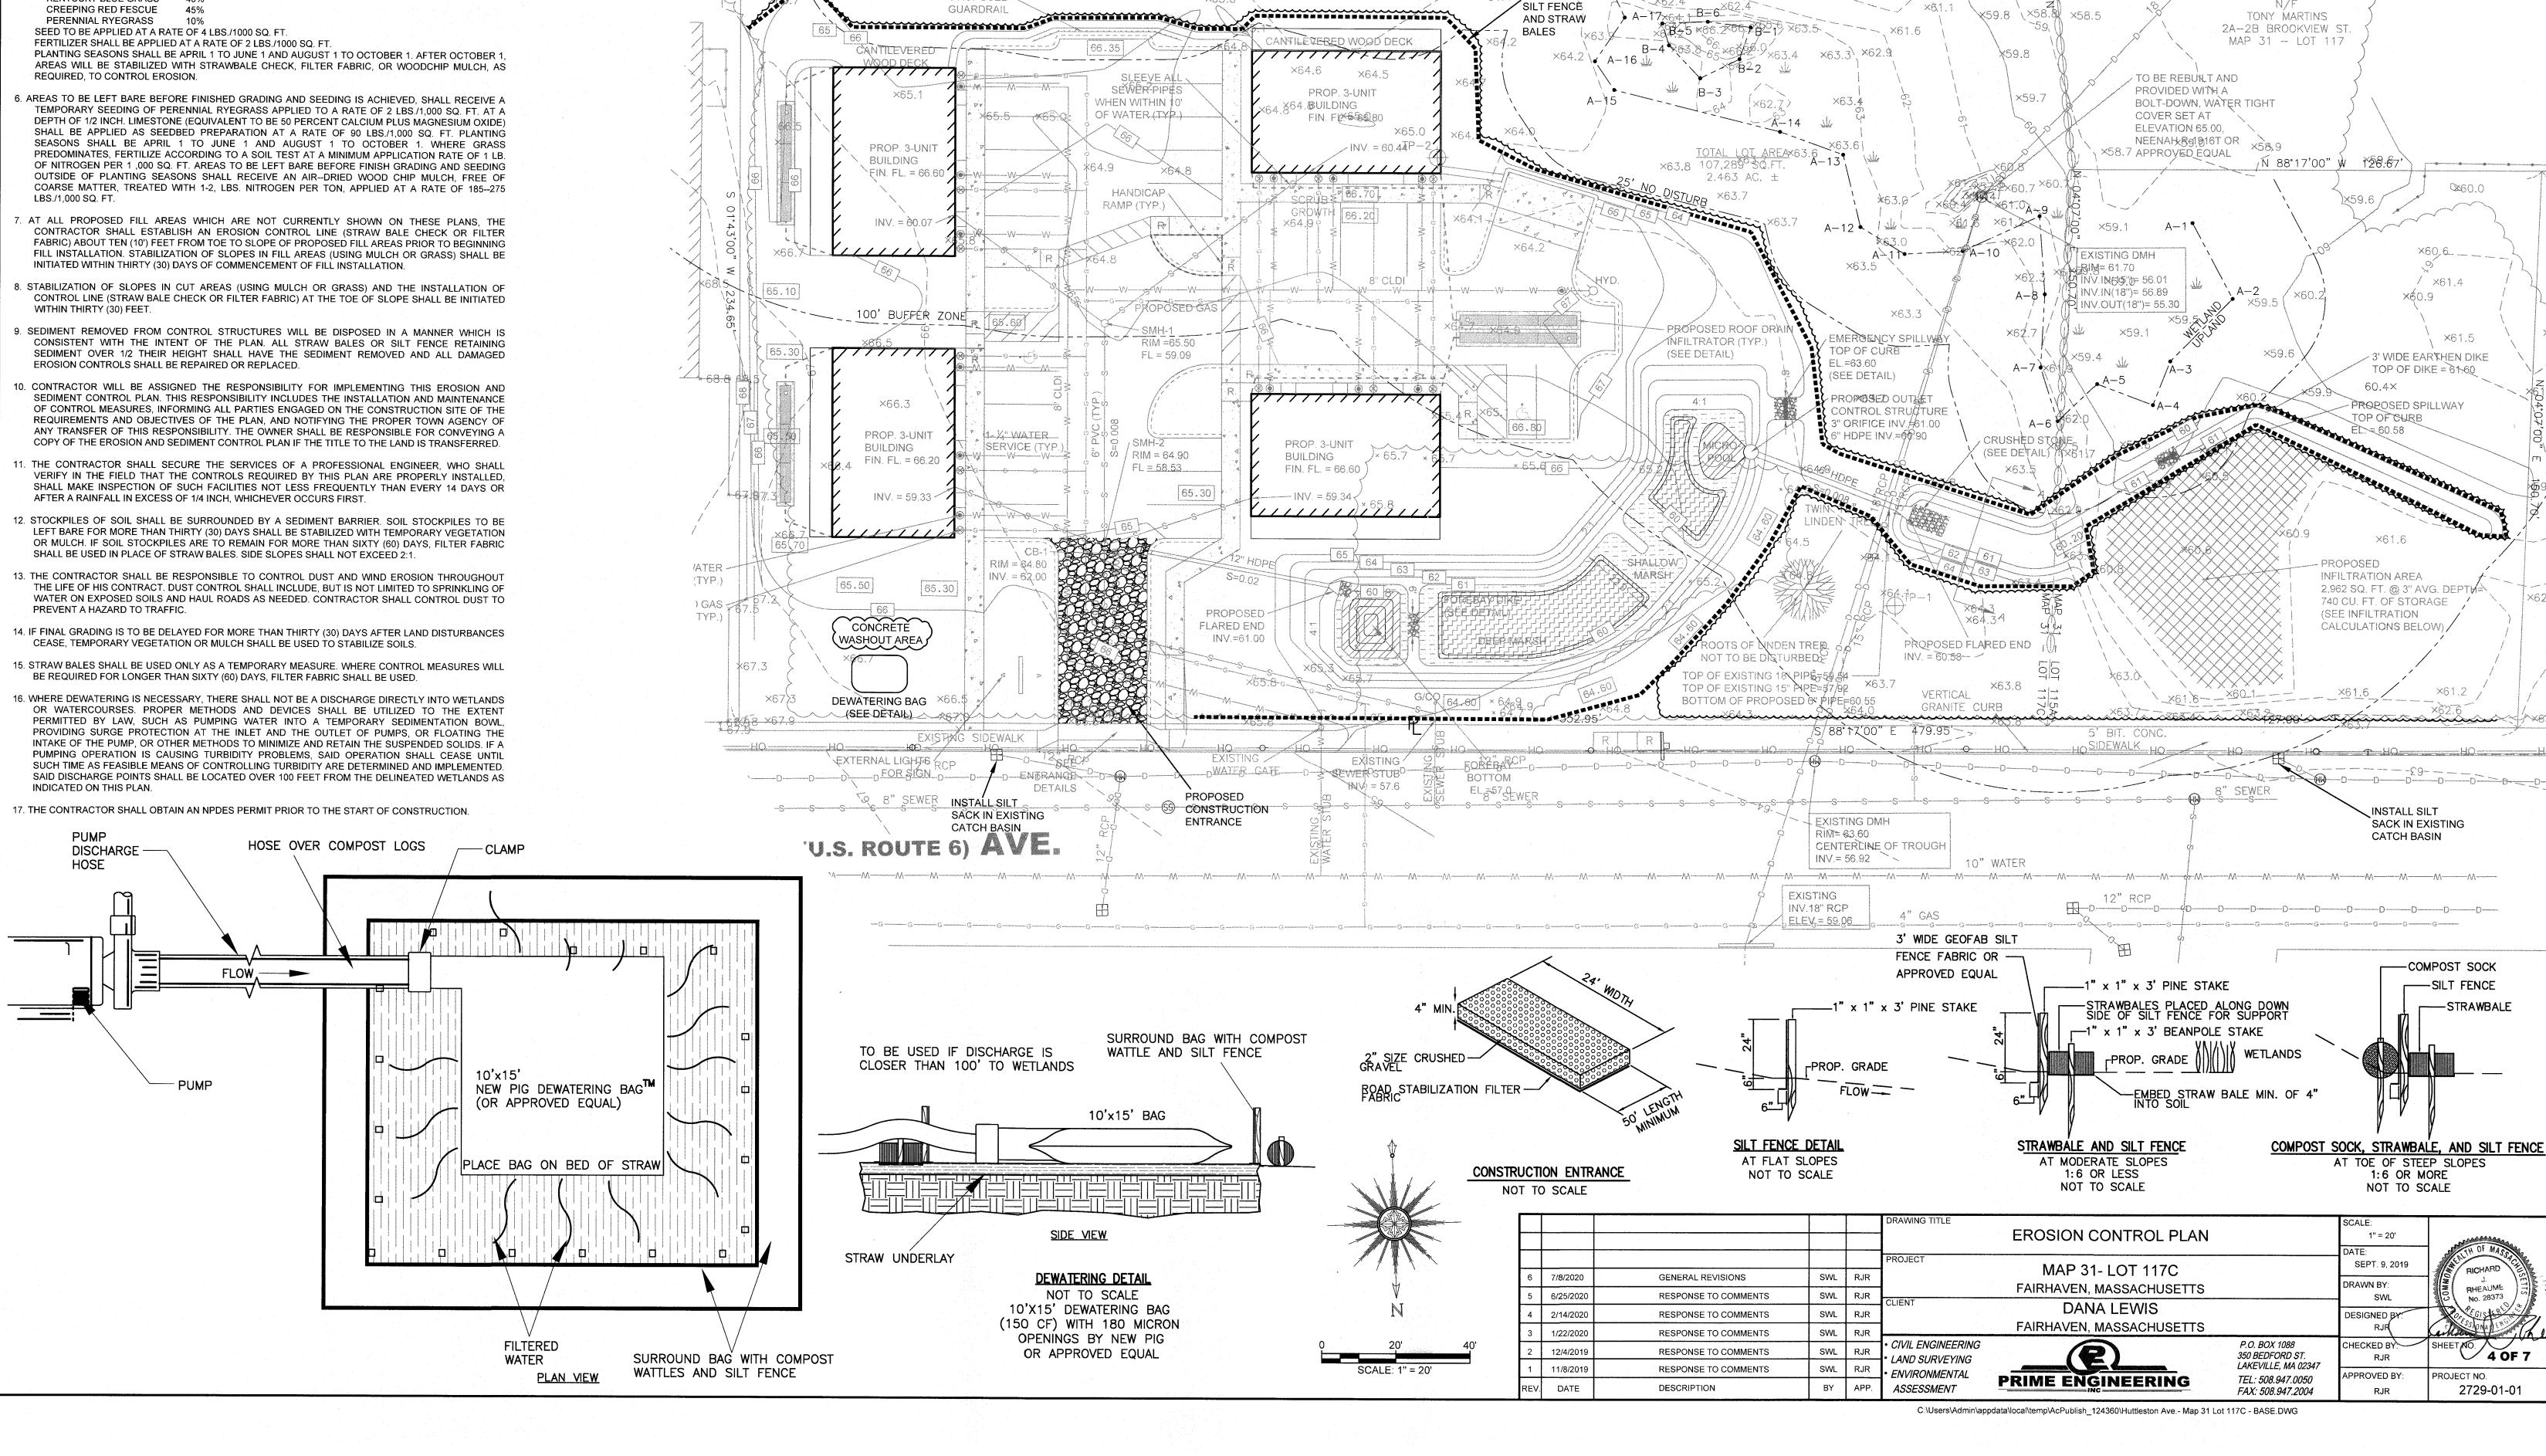



×62.7


- <u>- PROPOSED</u>


×60.4 (×59.8

X64.4

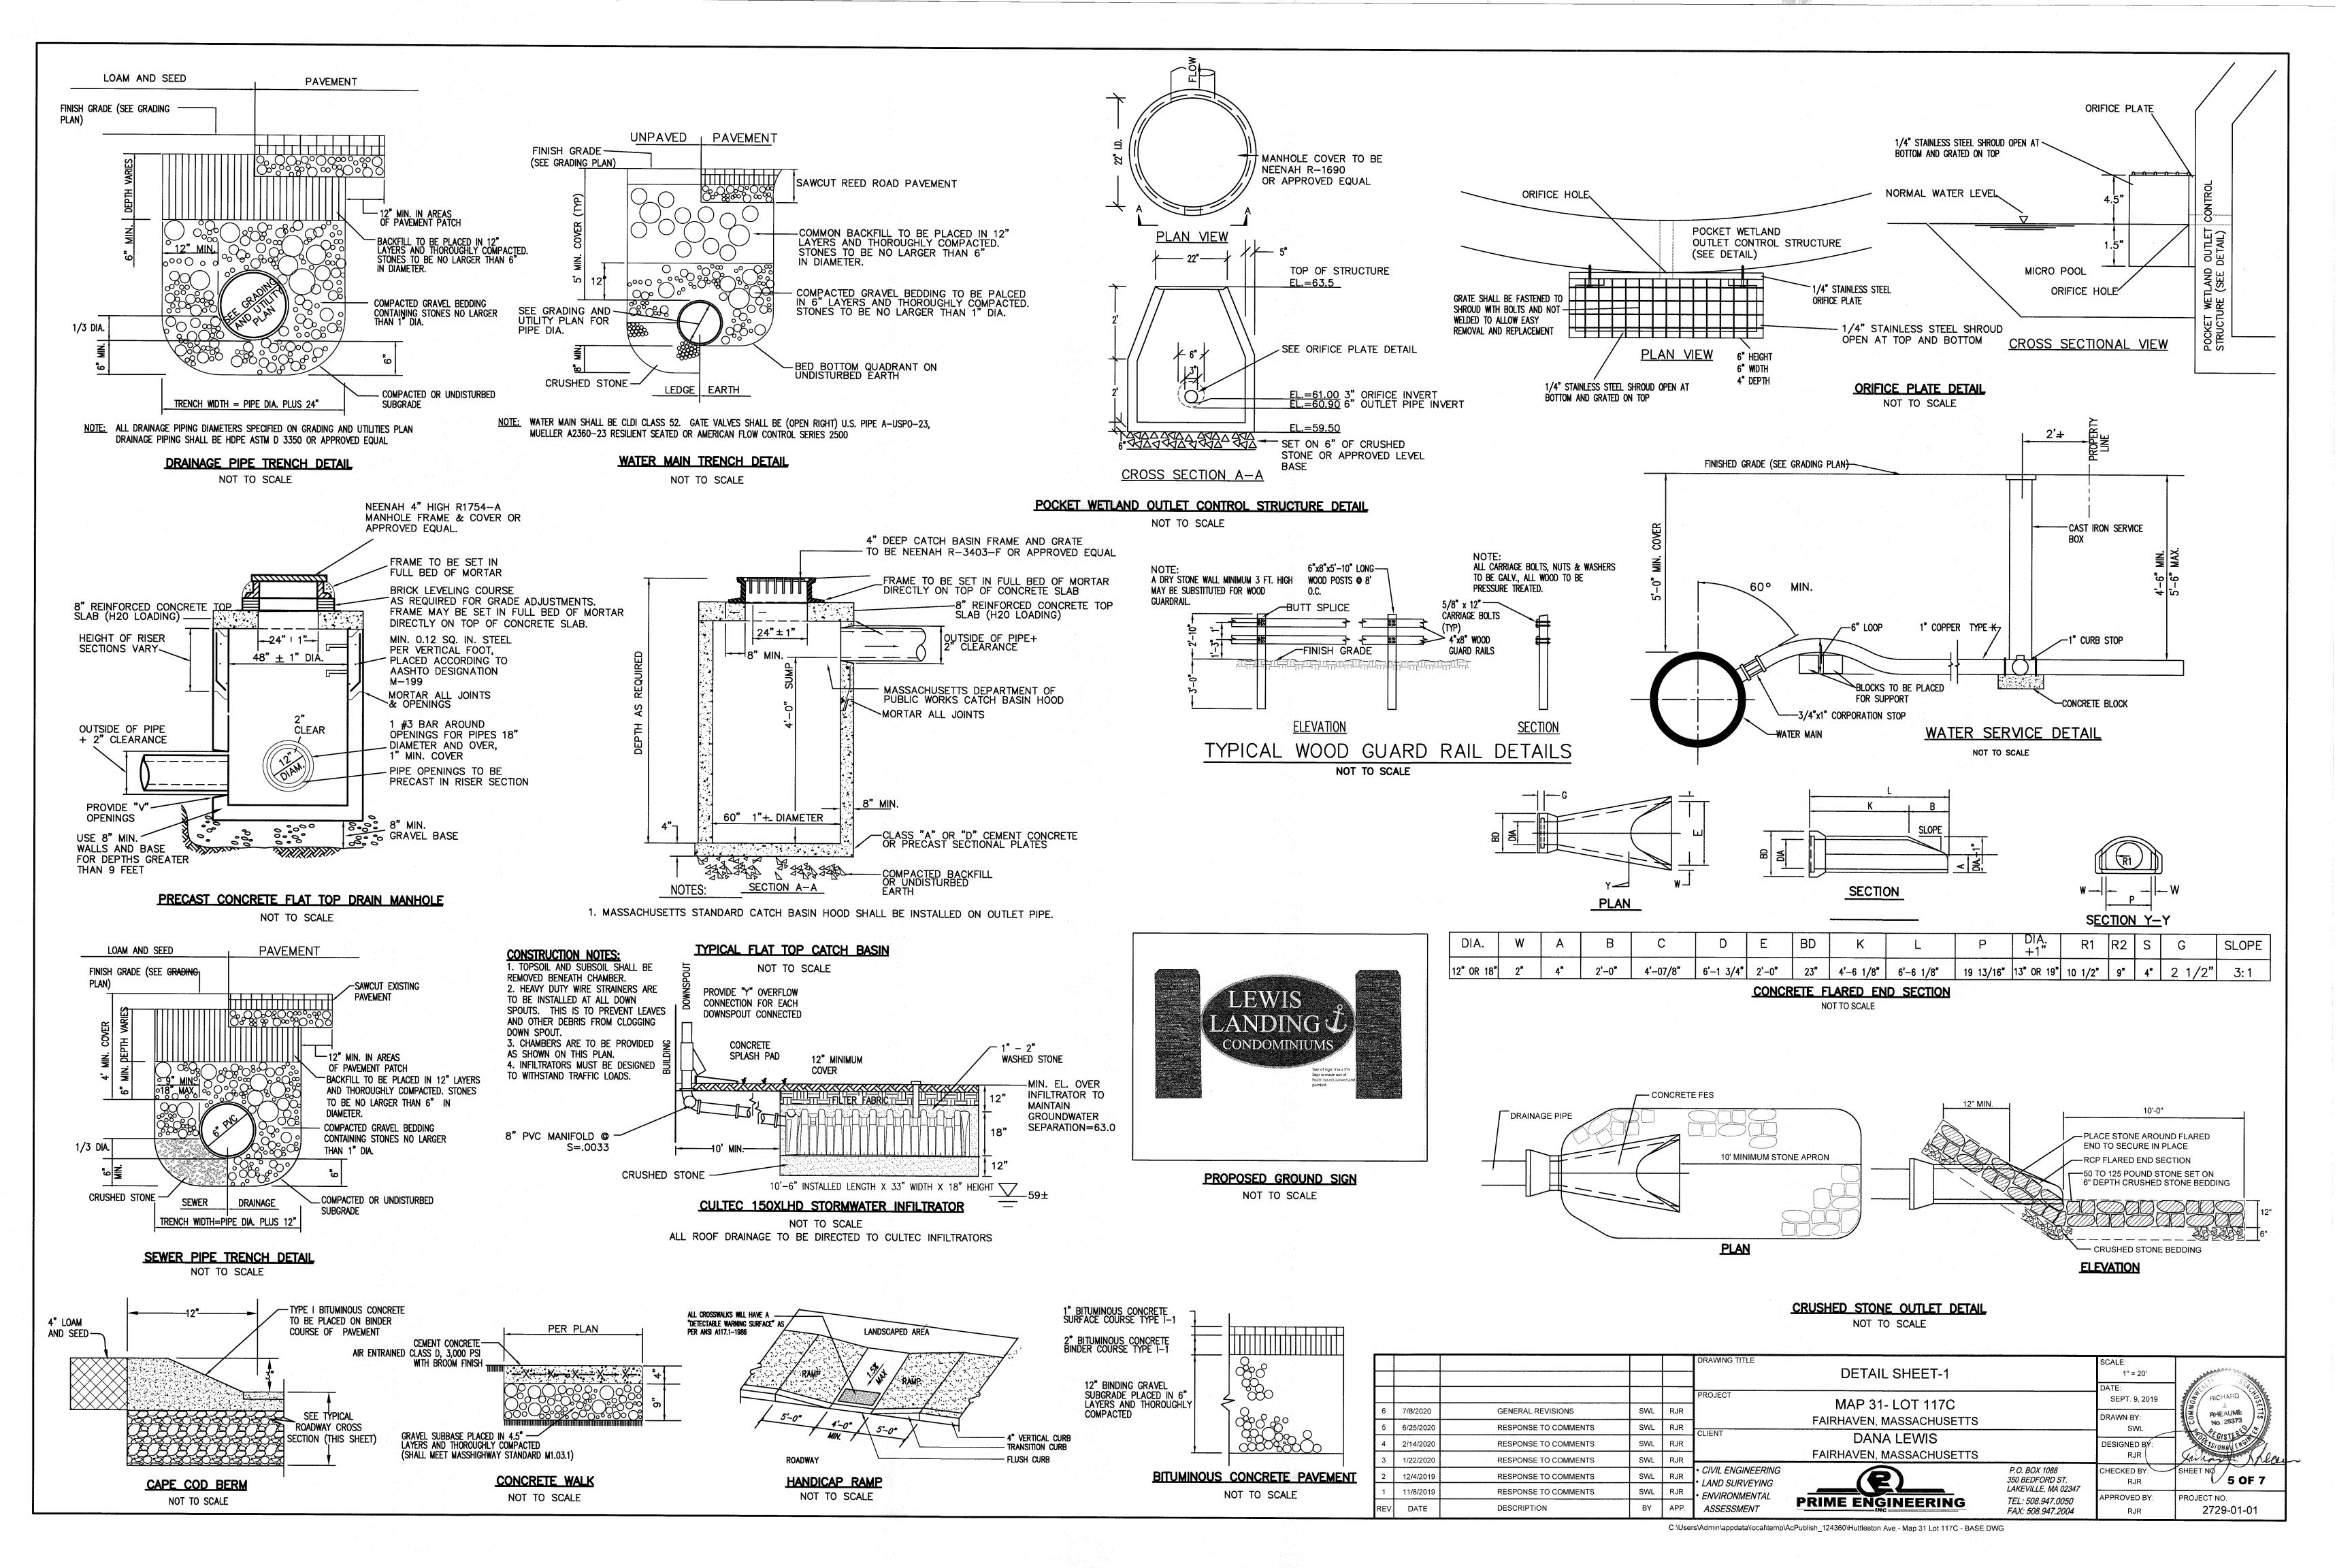

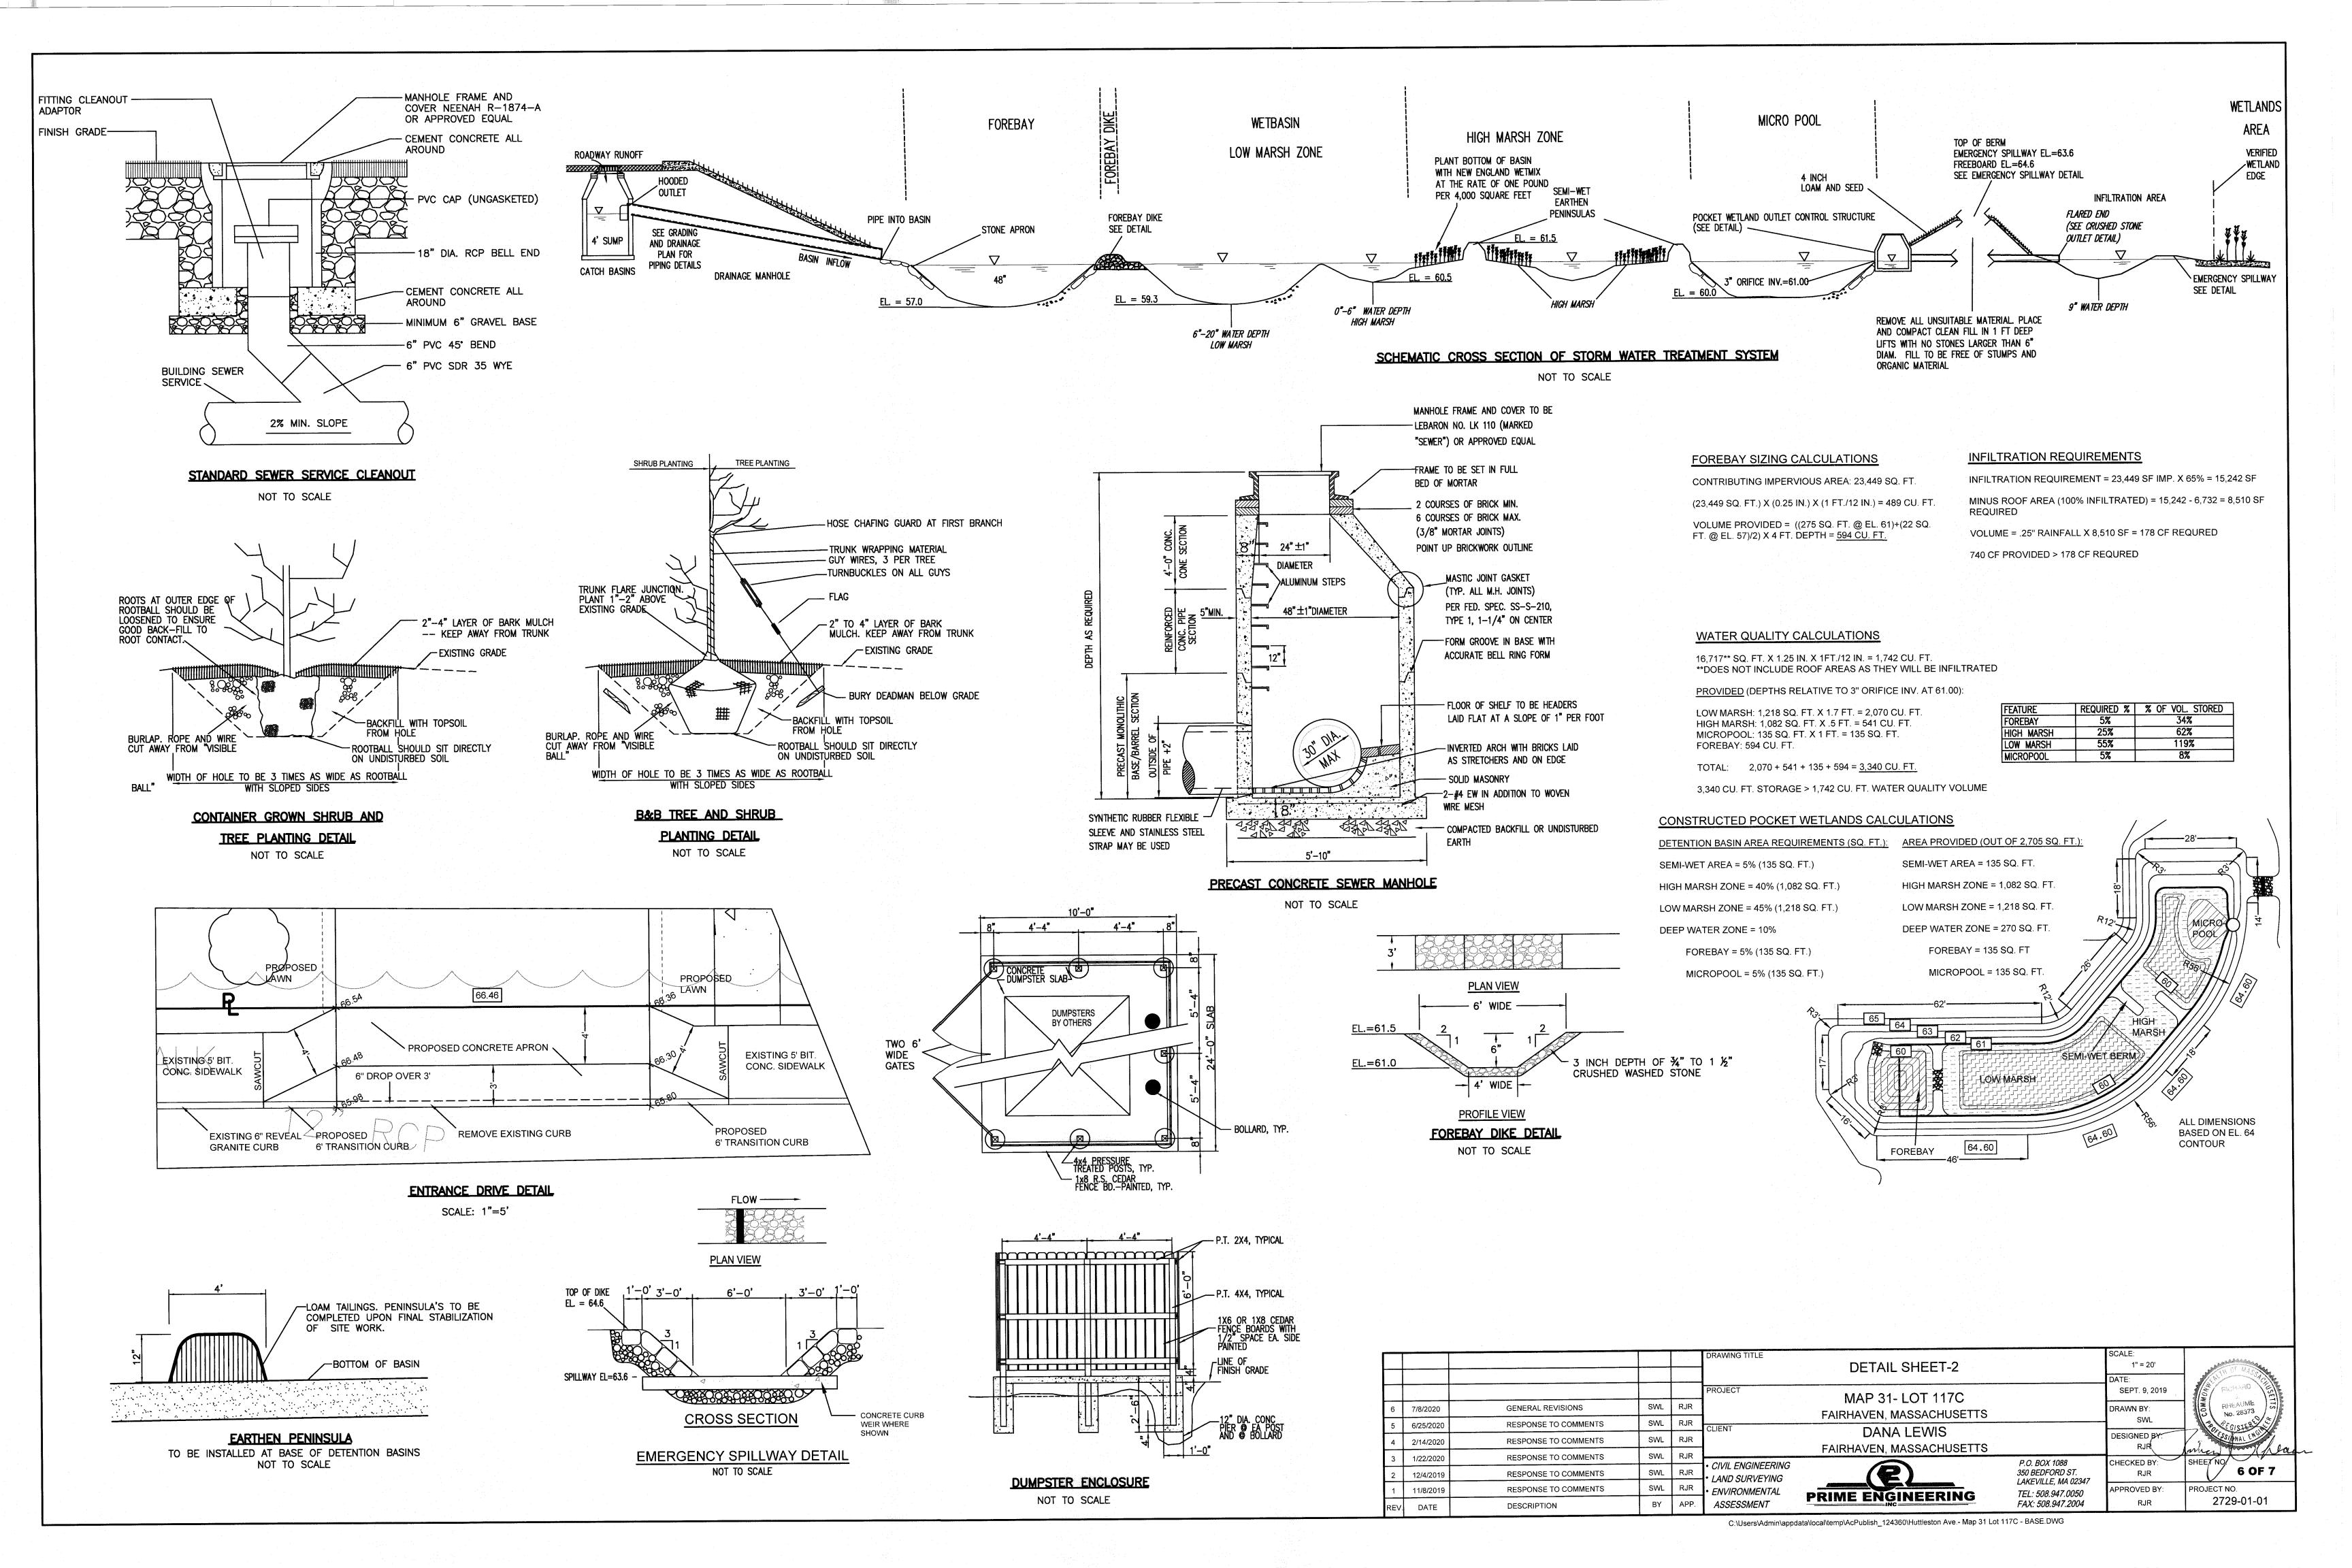

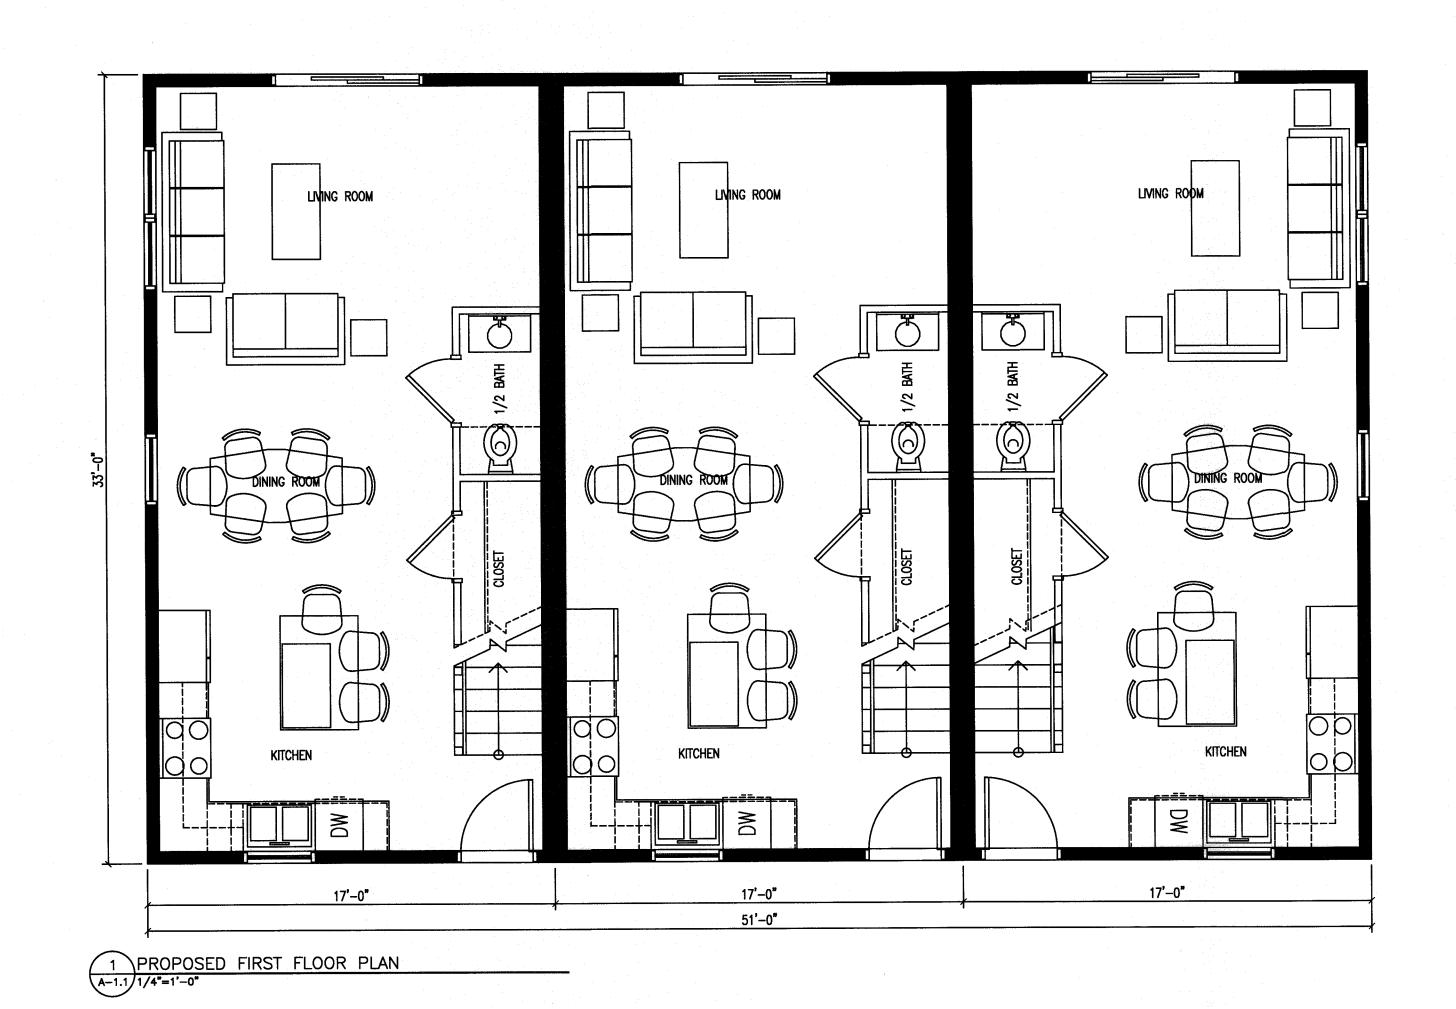

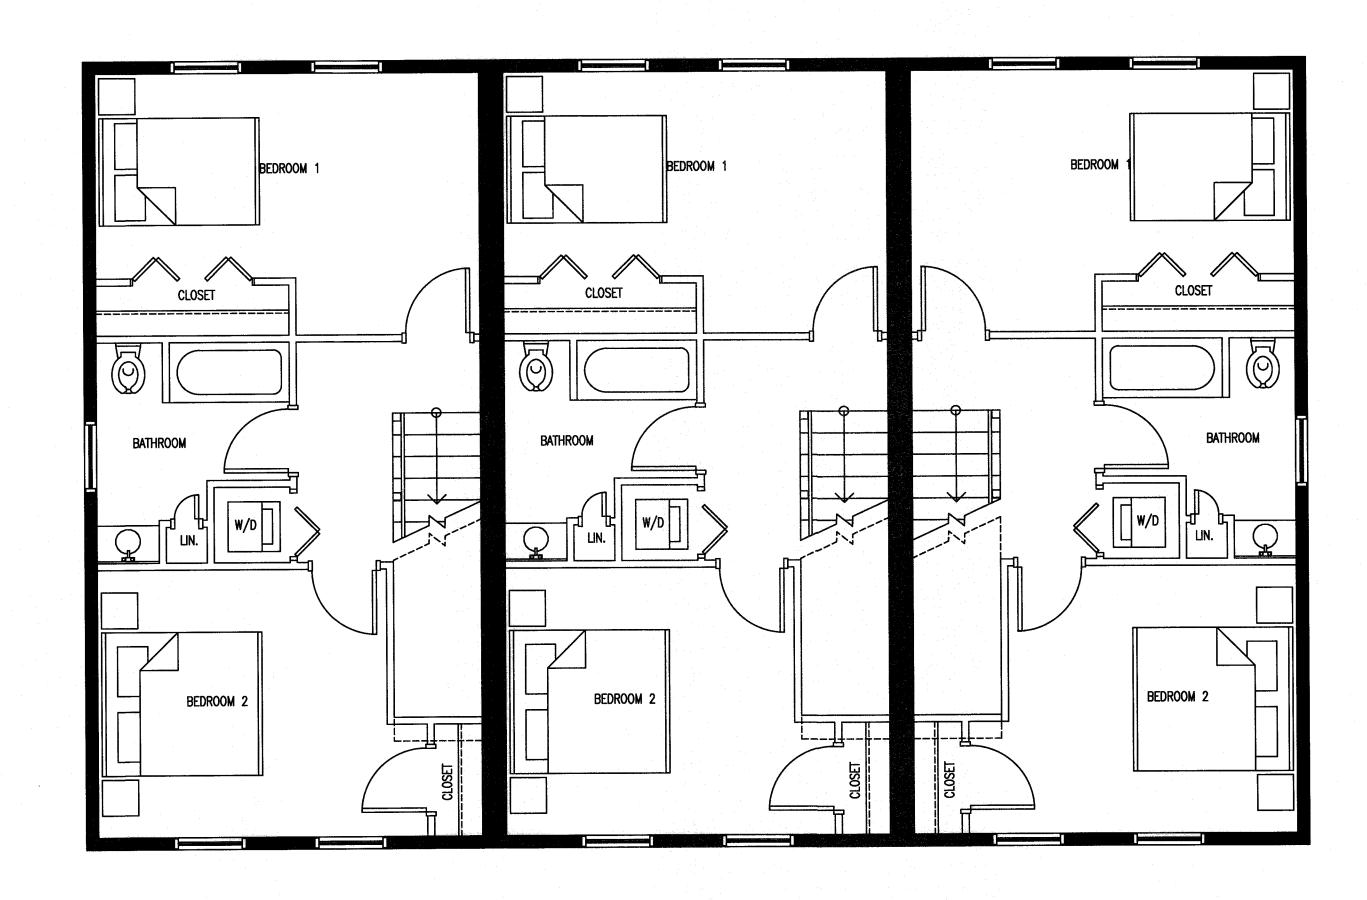


1 PROPOSED SECOND FLOOR PLAN
A-1.2 1/4"=1'-0"



1 PROPOSED FRONT ELEVATION
A-2.0 1/8"=1'-0"



1 PROPOSED REAR ELEVATION
A-2.1 1/8"=1'-0"

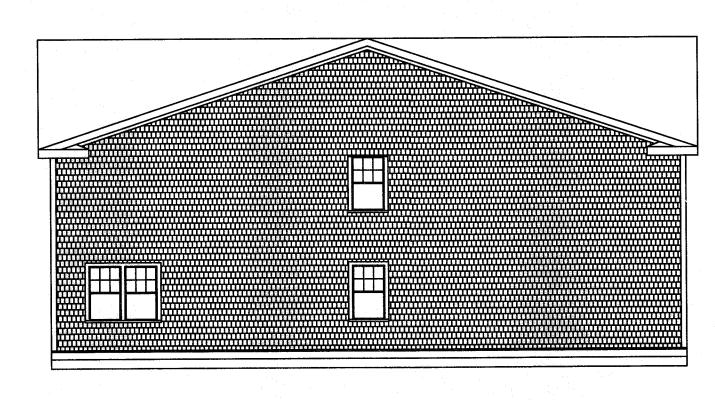

1 PROPOSED SIDE ELEVATION
A-2.2 1/8"=1'-0"

								T	
					DRAWING TITLE	ARCHITECTURALS		SCALE: 1" = 20'	NITH OF MASSA
					PROJECT	MAP 31- LOT 117C		SEPT. 9, 2019	RHEAUME No. 28373
						FAIRHAVEN, MASSACHUSETTS		DRAWN BY: SWL	No. 28373
					CLIENT	DANA LEWIS FAIRHAVEN, MASSACHUSETTS		DESIGNED BY RJR	alen Schlar
					• CIVIL ENGINEERING • LAND SURVEYING	(2)	P.O. BOX 1088 350 BEDFORD ST.	CHECKED BY:	7 OF 7
					• ENVIRONMENTAL	PRIME ENGINEERING	LAKEVILLE, MA 02347 TEL: 508.947.0050	APPROVED BY:	PROJECT NO. 2729-01-01
REV	DATE	DESCRIPTION	BY	APP.	ASSESSMENT	INC	FAX: 508.947.2004	RJR	2123-01-01