



September 25, 2019

Whitney McClees
Conservation Agent and Sustainability Coordinator
Fairhaven Town Hall
40 Center Street
Fairhaven, MA 02719

**RE: Updated Plans and Information
Notice of Intent Submittal
46 Charity Stevens Lane Solar Project
46 Charity Stevens Lane, Fairhaven, MA 02719 (Map 40, Lot 8)
DEP File No. SE 023-1307**

Dear Conservation Commission:

Enclosed, please find updated plans and documents relative to the above listed Notice of Intent filing for the 46 Charity Stevens Lane Solar Project on behalf of Fairhaven MA 4, LLC. We have provided copies of the following items for the Conservation Commission:

1. Eight (8) full size copies of Site Development Plans prepared by Atlantic Design Engineers – revised dated 9/24/19;
2. One (1) 11 X 17 set of plans – revised dated 9/24/19;
3. (1) Copy Revised Recharge Volume Calculations – dated 9/24/19;
4. (1) Copy Revised Long-Term Stormwater Operation and Maintenance Plan – dated 9/24/19;
5. (1) Memory Stick of this Entire Submittal.

These items address comments received from GCC Associates (erosion barrier at southeast corner of site, revised recharge volume calculations/stone trench, and revised Long-Term Stormwater Operation and Maintenance Plan) and the Conservation Commission (clarification of erosion control barrier placement outside of the fence, native seed mix, addition of erosion control barrier around the isolated ponds, incorporation of a 25' no disturb zone, and elimination of the shading easement tree coping.)

If you have any questions or require further information, please don't hesitate to contact me at (508) 888-9282.

Sincerely,

ATLANTIC DESIGN ENGINEERS, INC

Richard J. Tabaczynski, P.E.
Vice President

cc: DEP-SERO
GCC Associates, Inc.

SITE DEVELOPMENT PLANS

FOR


46 CHARITY STEVENS LANE SOLAR PROJECT

FAIRHAVEN, MASSACHUSETTS


DATE: AUGUST 23, 2019

REVISED: SEPTEMBER 11, 2019


REVISED: SEPTEMBER 24, 2019

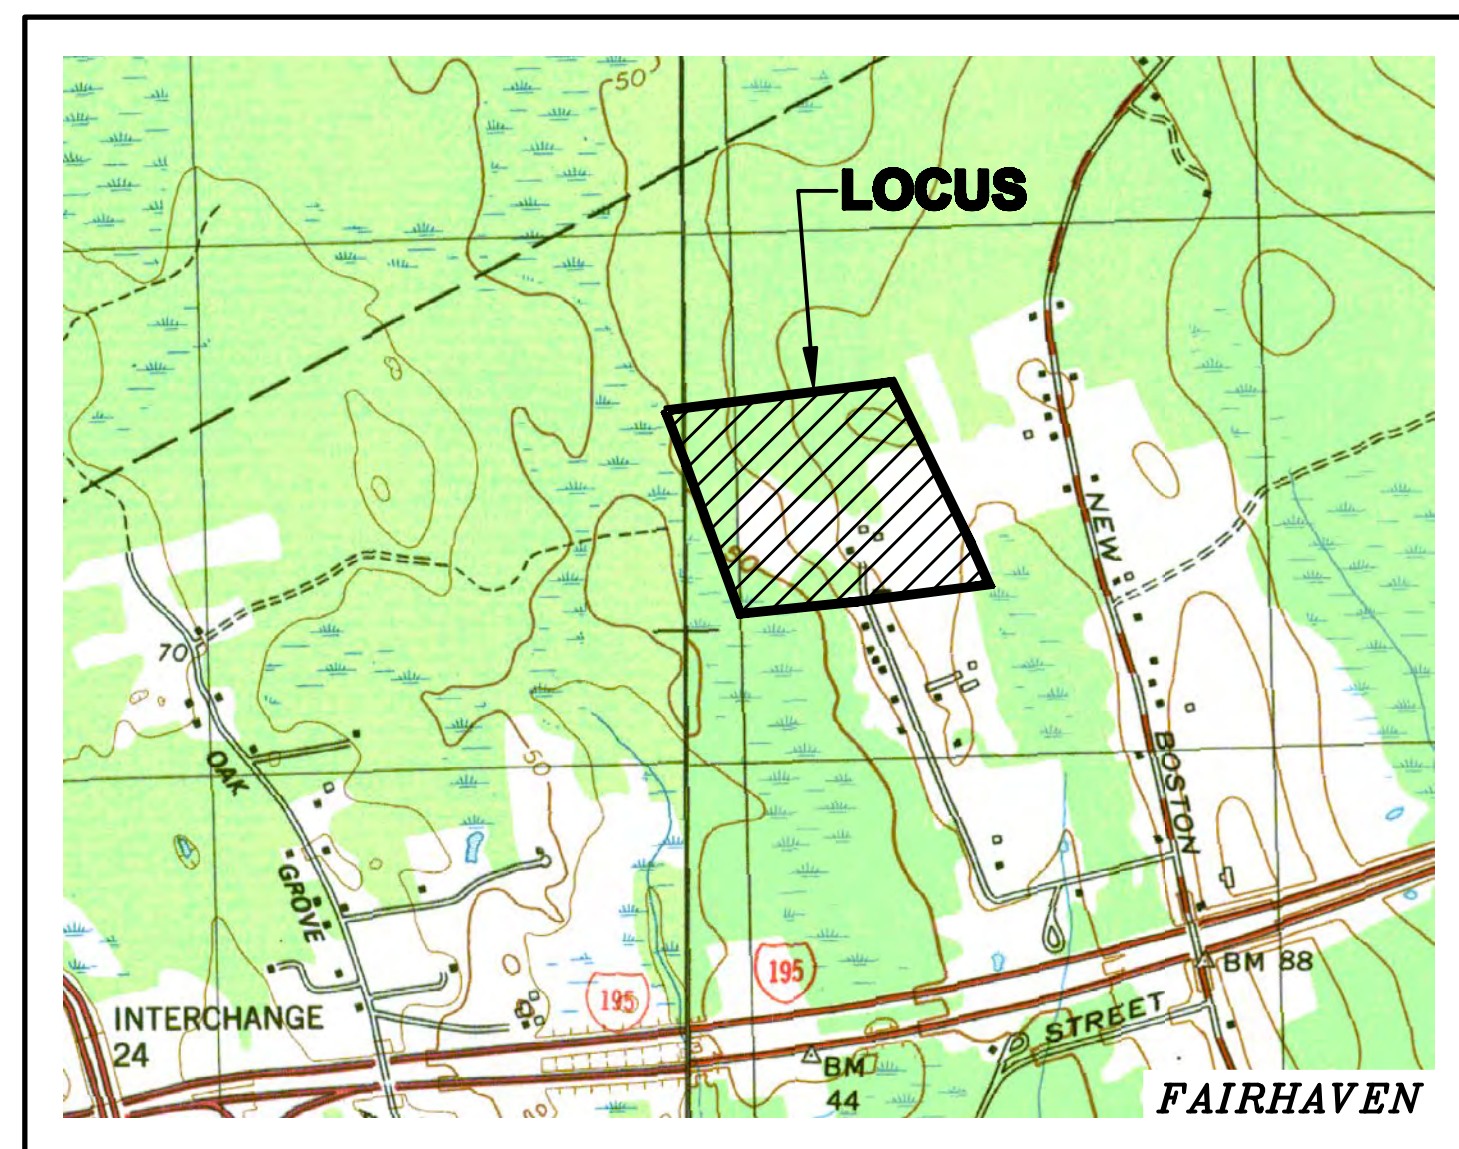

VICINITY MAP
1" = 1,200'

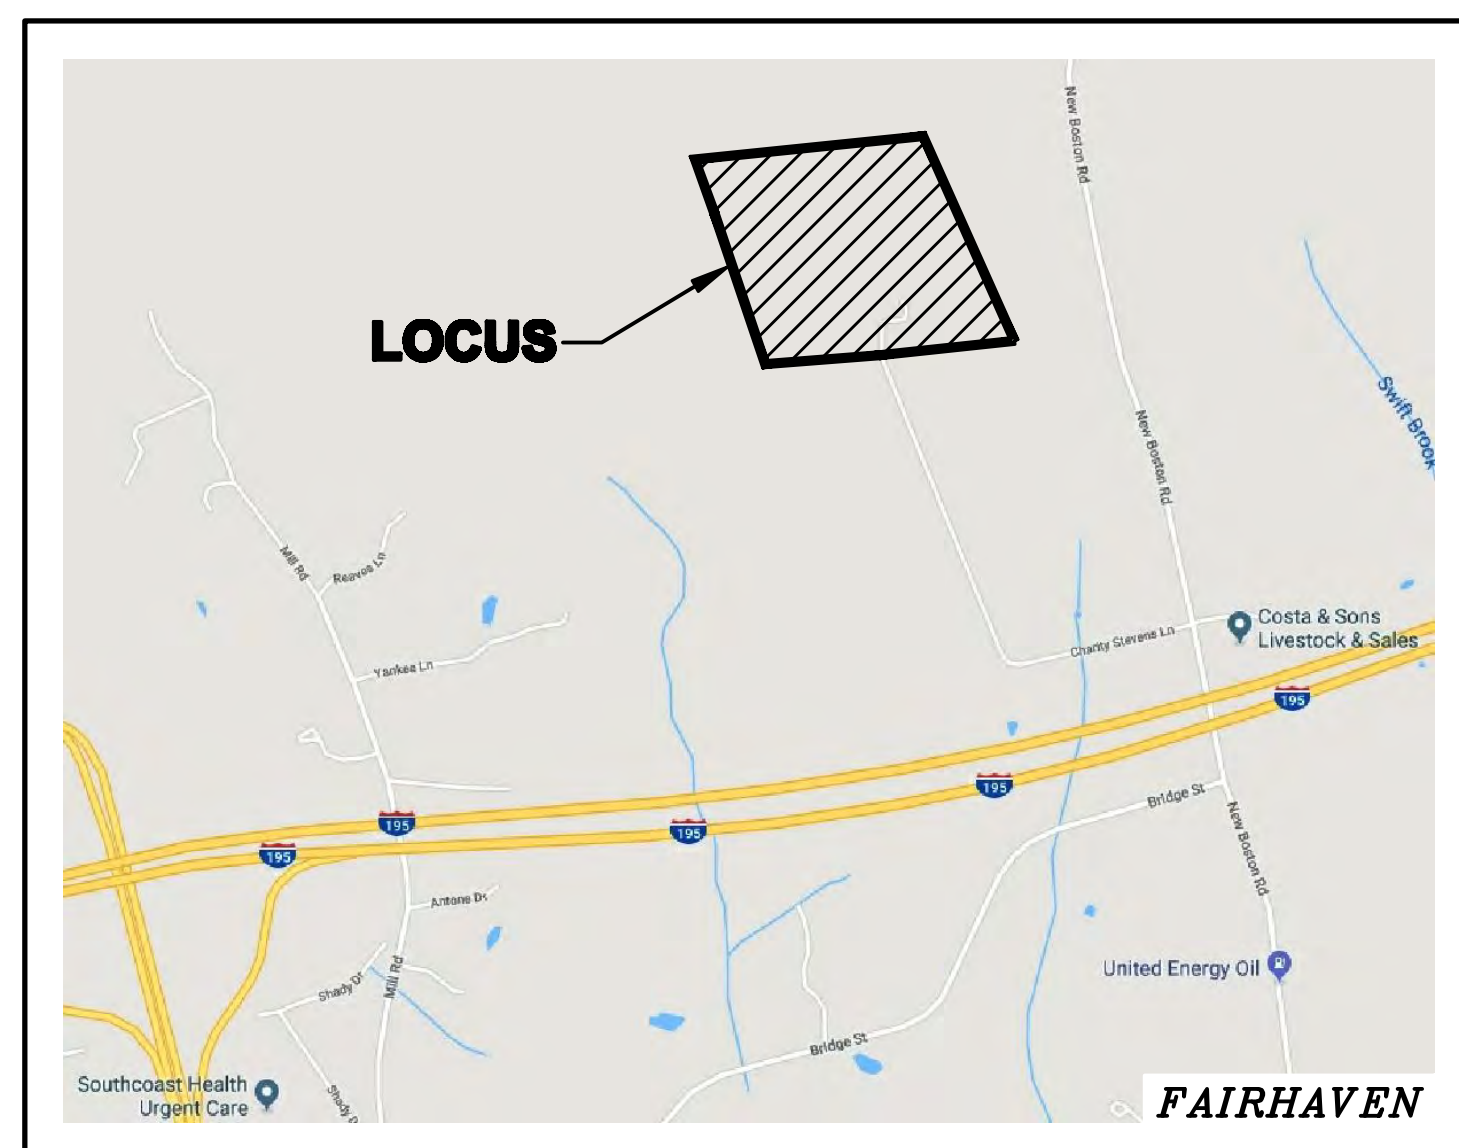

LOCUS MAP
1" = 1,200'

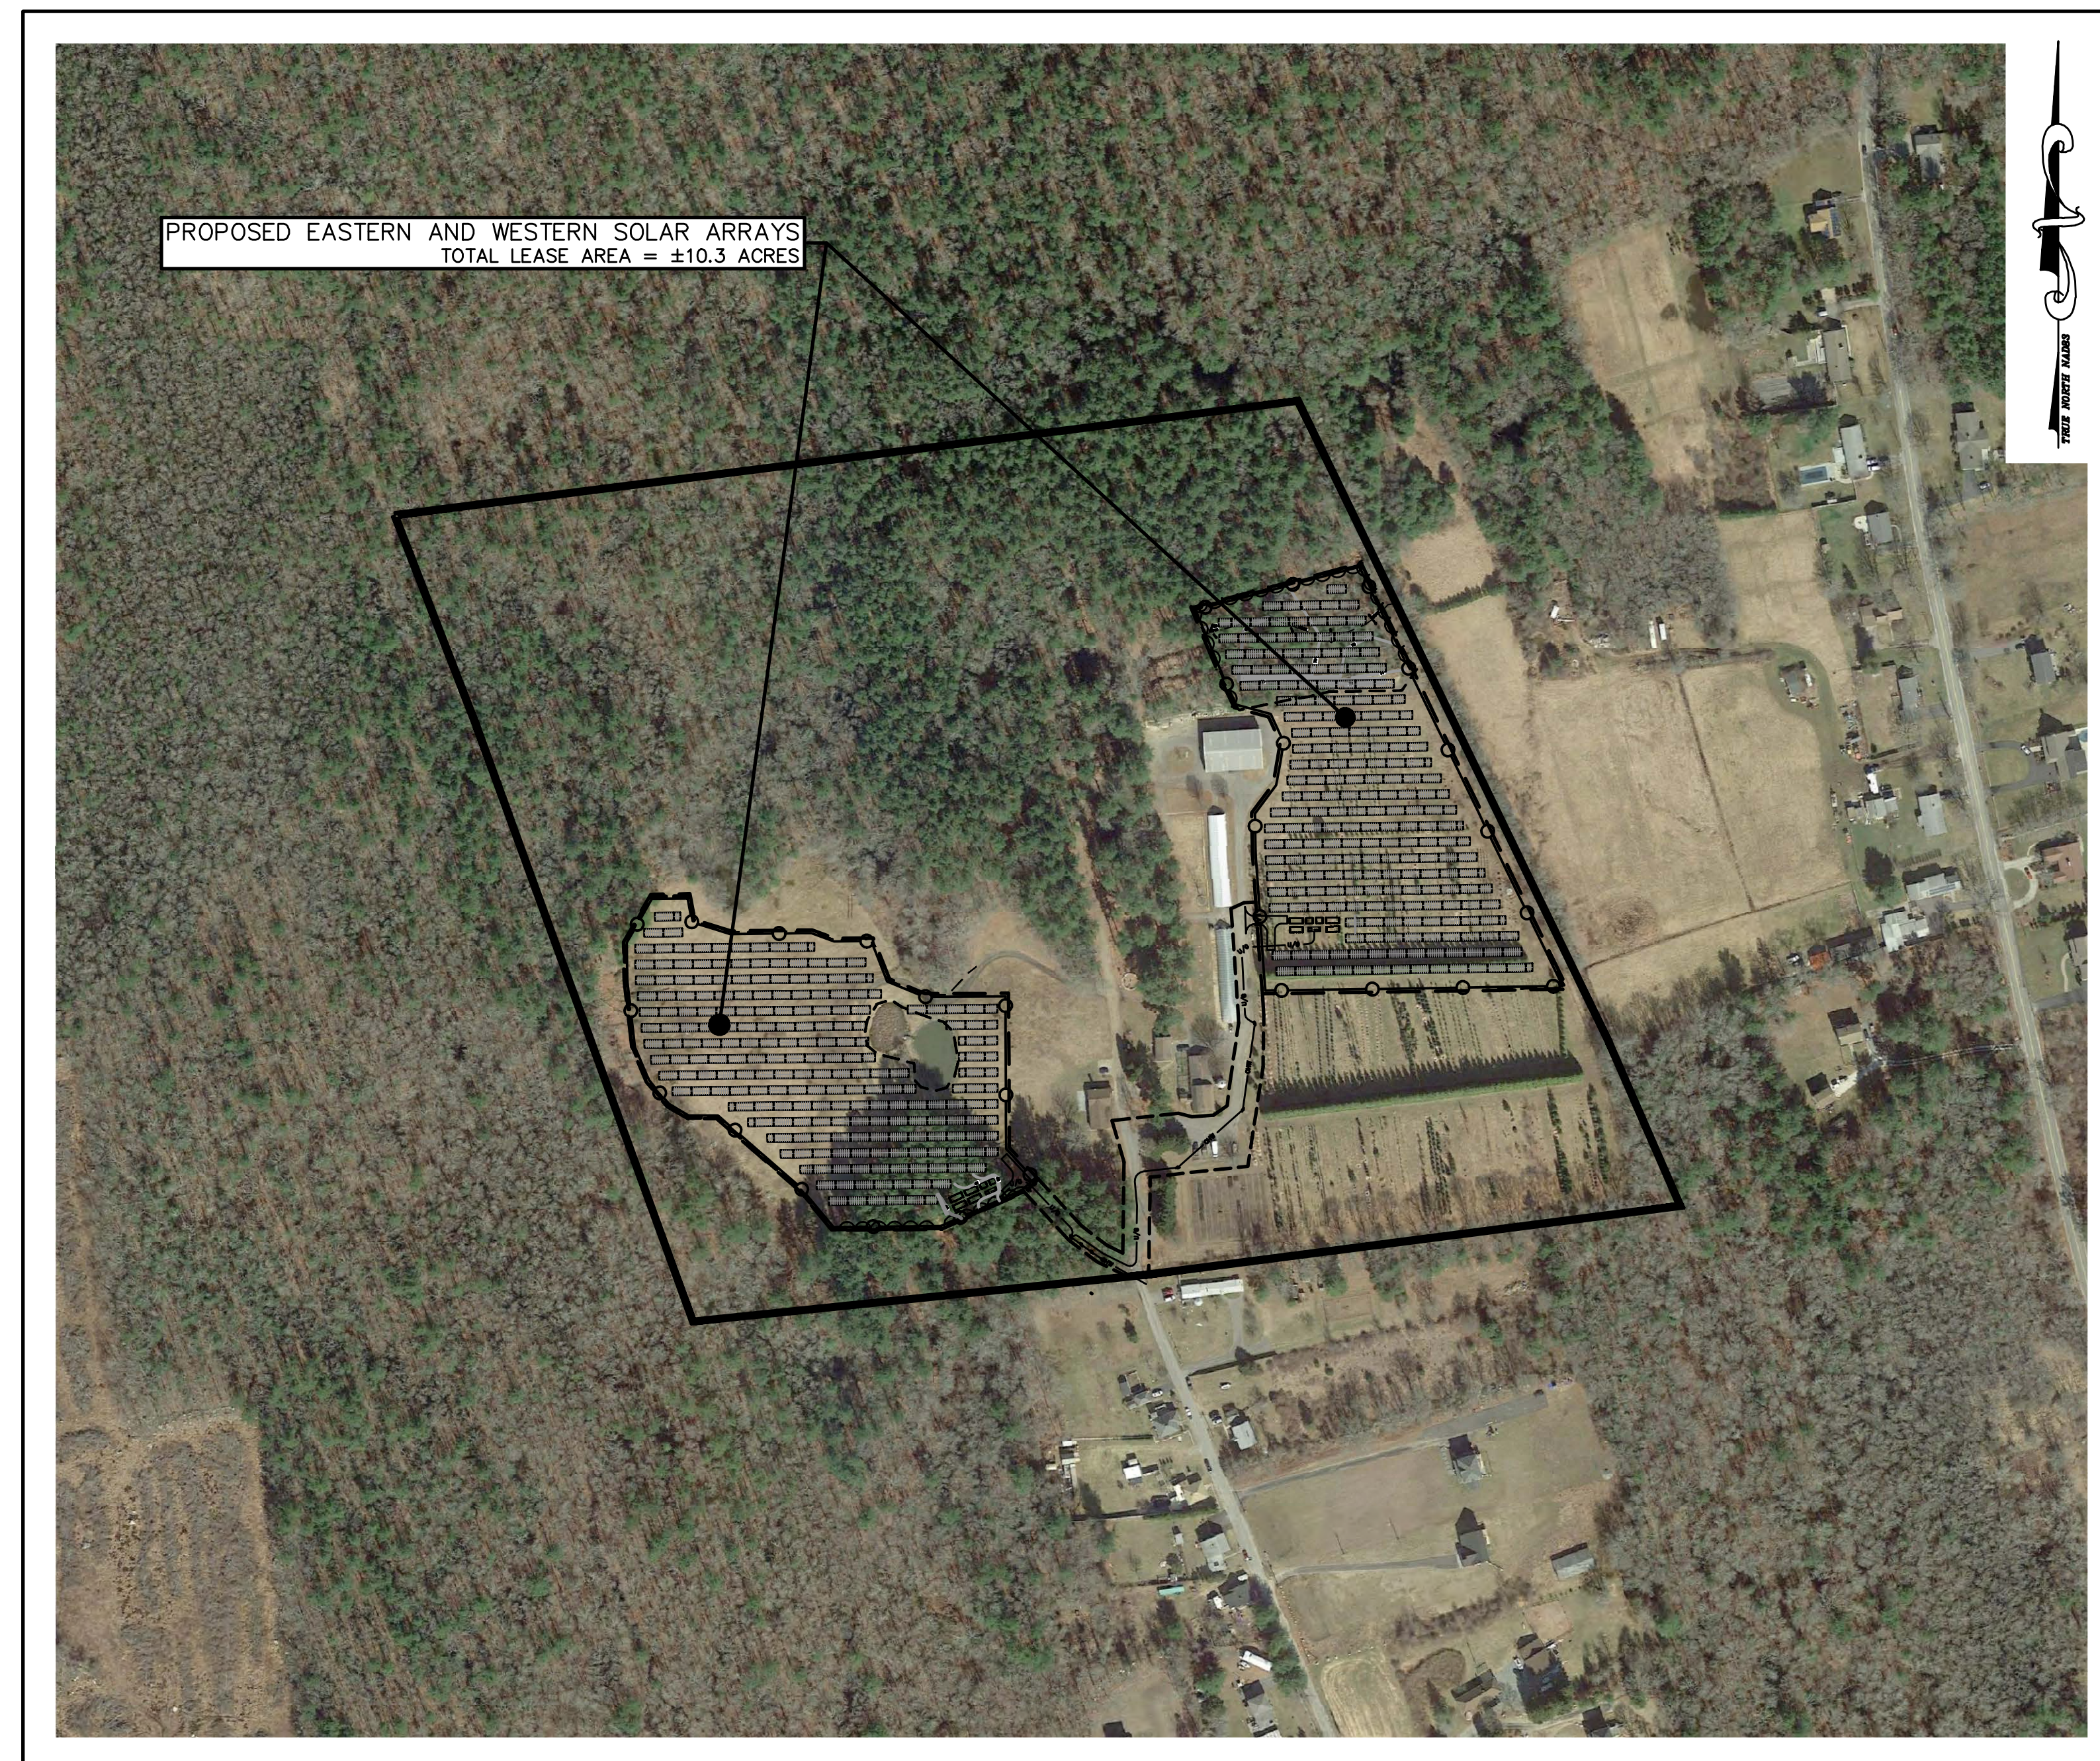

OVERALL LOCATION PLAN
SCALE: 1" = 200'

NOTE:
"THE CONTRACTOR SHALL GIVE SEVEN (7) DAYS' NOTICE TO PERTINENT TOWN DEPARTMENTS BEFORE COMMENCING WORK IN THE FIELD"

INDEX OF PLANS		
SHEET NO.	TITLE	SCALE
1	COVER SHEET	1" = 200'
2	OVERALL EXISTING CONDITIONS PLAN	1" = 80'
3	OVERALL SITE DEVELOPMENT PLAN	1" = 80'
4	SITE DEVELOPMENT PLAN	1" = 40'
5	SITE DEVELOPMENT PLAN	1" = 40'
6	DETAILS PLAN	N.T.S.

OWNER:

HASKELL FAMILY REVOCABLE TRUST
46 CHARITY STEVENS LANE
FAIRHAVEN, MASSACHUSETTS 02719


APPLICANT:

FAIRHAVEN MA 4, LLC
C/O CLEAN ENERGY COLLECTIVE, LLC
27 B MIDSTATE DR., SUITE 106
AUBURN, MASSACHUSETTS 01501

ENGINEER:

Atlantic[®]
DESIGN ENGINEERS, INC.
P.O. Box 1051, Sandwich, MA 02563
(508) 888 - 9282



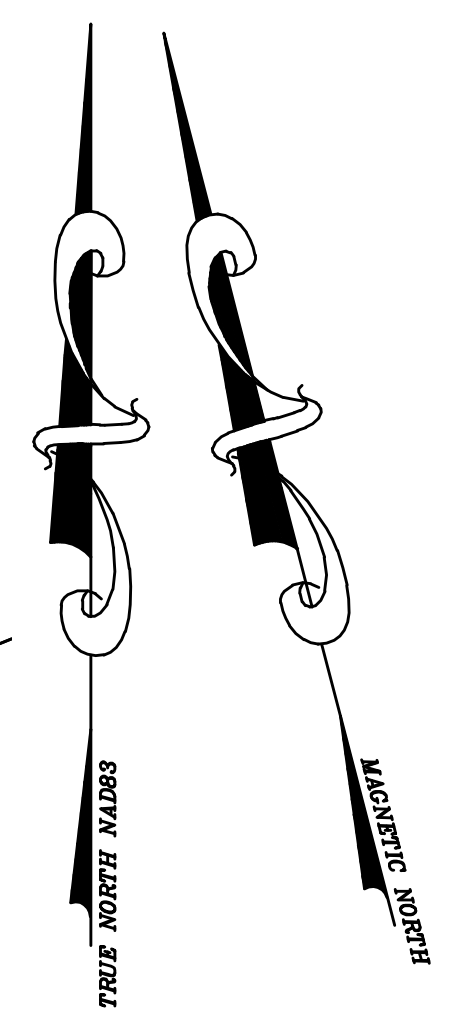

LEGEND	
	EXISTING 1 FOOT CONTOUR LINE
	EXISTING 5 FOOT CONTOUR LINE
	EXISTING EDGE OF GRAVEL
	EXISTING WATER LINE
	EXISTING STONE WALL
	EXISTING VINYL FENCE
	EXISTING WIRE FENCE
	EXISTING MAILBOX
	EXISTING TREE LINE
	EXISTING CONCRETE
	EXISTING TREE
	EXISTING UTILITY POLE
	EXISTING OVERHEAD WIRE
	EXISTING GUY WIRE
	EXISTING WELL
	EXISTING 100' WETLAND BUFFER
	EXISTING WETLAND LINE

GENERAL NOTES:

- OWNER OF RECORD: DAVID HASKELL, TRUSTEE
HASKELL FAMILY REVOCABLE TRUST
46 CHARITY STEVENS LANE
FAIRHAVEN, MA 02719
BOOK 10196 PAGE 70
- THE SUBJECT PROPERTY IS SHOWN AS LOT 8.0 ON THE TOWN OF FAIRHAVEN'S ASSESSOR MAP 40, LAND AREA IS APPROXIMATELY ±45.9 ACRES.
- THE PROPERTY LIES WITHIN A RURAL RESIDENTIAL DISTRICT BASED UPON A REVIEW OF THE TOWN OF FAIRHAVEN ZONING MAP AND PROPERTY CARD. THE PROPERTY ALSO LIES WITHIN THE NASKTUCKET RIVER BASIN OVERLAY DISTRICT.
- THE PROPERTY LINES FOR MAP 40 LOT 8.0 SHOWN HEREON, ARE A RESULT OF A BOUNDARY SURVEY COMPLETED BY ATLANTIC DESIGN ENGINEERS IN JUNE 2019 AND PLANS AND DEEDS RECORDED IN BRISTOL COUNTY SOUTH REGISTRY OF DEEDS.
- EXISTING CONDITIONS DEPICTED HEREON ARE BASED UPON PARTIAL FIELD SURVEYS BY ATLANTIC DESIGN ENGINEERS IN JUNE AND AUGUST 2019. THE MASSACHUSETTS GEOGRAPHIC INFORMATION SYSTEM, THE FAIRHAVEN GEOGRAPHIC INFORMATION SYSTEM AND INFORMATION OBTAINED FROM PUBLIC RECORDS.
- THE PROPERTY LIES WITHIN FLOOD ZONE X BASED UPON A REVIEW OF THE FEDERAL EMERGENCY MANAGEMENT AGENCY (FEMA) FLOOD INSURANCE RATE MAP (FIRM) MAP NUMBER 25005C0411F, DATED JULY 7, 2009.
- THE WETLAND RESOURCE AREAS SHOWN HEREON ARE BASED UPON DELINEATION BY GODDARD CONSULTING LLC, IN MAY OF 2019 WITH ADJUSTMENTS IN AUGUST 2019 AND FIELD SURVEYS BY ATLANTIC DESIGN ENGINEERS IN MAY AND AUGUST 2019.
- THE PROPERTY IS NOT LOCATED WITHIN A ZONE II BASED UPON A REVIEW OF THE MASSACHUSETTS GEOGRAPHIC INFORMATION SYSTEM.
- THE PROPERTY IS NOT LOCATED WITHIN AN ESTIMATED AND HABITAT OF RARE WILDLIFE AND A PRIORITY HABITAT OF RARE SPECIES BASED UPON A REVIEW OF THE NATURAL HERITAGE AND ENDANGERED SPECIES PROGRAM MAPS OBSERVED ON THE MASSACHUSETTS GEOGRAPHIC INFORMATION SYSTEM.
- THE PROPERTY DOES NOT LIE WITHIN AN AREA OF CRITICAL ENVIRONMENTAL CONCERN (ACEC) BASED UPON A REVIEW OF THE MASSACHUSETTS GEOGRAPHIC INFORMATION SYSTEM.

Atlantic DESIGN ENGINEERS, INC.
P.O. Box 1051, Sandwich, MA 02563 (508) 888 - 9282

Designed by : _____
 Drawn by : _____
 Checked by : _____
 Survey chk. by : _____
 Approved by : _____

SCALE
SCALE 1" = 80'
0 20 40 80 160


NO.	BY	DATE	REVISION
2	SWG	9-24-19	PER CONCOM COMMENTS
1	JCE	9-11-19	UPDATED BUFFER ZONES PER CONCOM

APPLICANT:
FAIRHAVEN MA 4, LLC
 c/o CLEAN ENERGY COLLECTIVE, LLC.
 27 B MIDSTATE DR, SUITE 106
 AUBURN, MASSACHUSETTS 01501

OVERALL EXISTING CONDITIONS PLAN
 FOR
46 CHARITY STEVENS LANE SOLAR PROJECT
 FAIRHAVEN, MASSACHUSETTS
 AUGUST 23, 2019

File: 3119.01-SITE-R2
Sheet 2 of 6
JOB NUMBER 3119.01



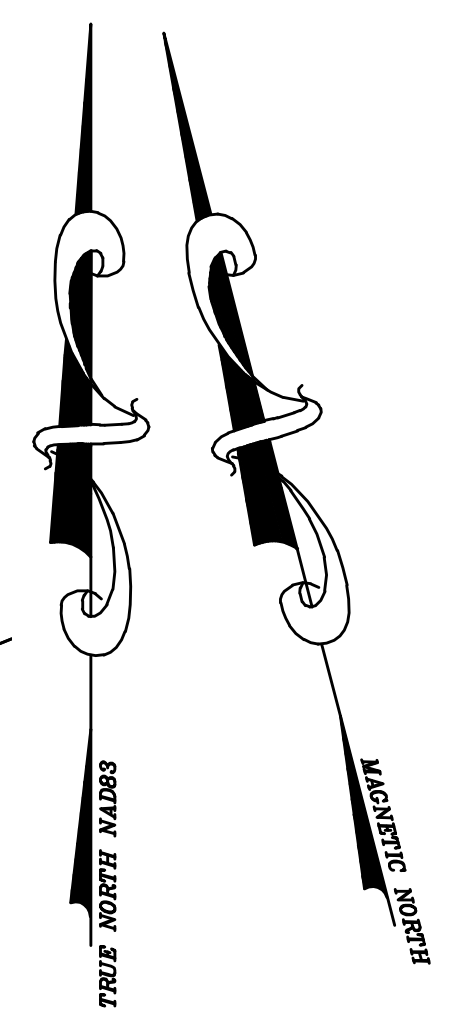

LEGEND	
	EXISTING 1 FOOT CONTOUR LINE
	EXISTING 5 FOOT CONTOUR LINE
	EXISTING EDGE OF GRAVEL
	EXISTING WATER LINE
	EXISTING STONE WALL
	EXISTING VINYL FENCE
	EXISTING WIRE FENCE
	EXISTING MAILBOX
	EXISTING TREE LINE
	EXISTING CONCRETE
	EXISTING TREE
	EXISTING UTILITY POLE
	EXISTING OVERHEAD WIRE
	EXISTING GUY WIRE
	EXISTING WELL
	EXISTING 100' WETLAND BUFFER
	EXISTING WETLAND LINE
	PROPOSED TREELINE/LIMITS OF CLEARING
	PROPOSED CHAIN LINK FENCE
	PROPOSED OVERHEAD WIRES
	PROPOSED 1 FOOT CONTOUR
	PROPOSED 5 FOOT CONTOUR
	PROPOSED EROSION CONTROL BARRIER
	PROPOSED UNDERGROUND ELECTRIC
	PROPOSED UTILITY POLE

ZONING REQUIREMENTS		
TOWN OF FAIRHAVEN ZONING BYLAWS; REVISED THROUGH MAY 6, 2017		
RURAL RESIDENCE DISTRICT (RR)		
AND WITHIN NASKETUCKET RIVER BASIN OVERLAY DISTRICT		
MINIMUM LOT AREA:	REQUIRED 30,000 S.F.	PROVIDED ±1,999,404 S.F. (3)
MINIMUM FRONTAGE AT STREET:	140 FEET	- (1)
CONTIGUOUS UPLAND:	24,000 S.F.	>24,000 S.F.
BUILDING SETBACKS:		
FRONT YARD:	30 FEET	144.8 FEET (3)
SIDE YARD:	20 FEET	51.0 FEET (3)
REAR YARD:	30 FEET	293.6 FEET (3)
MAXIMUM BUILDING HEIGHT:	35 FEET	<35 FEET
MAXIMUM LOT COVERAGE:	25%	<2% (2)
MAXIMUM BUILDING COVERAGE:	15%	<1%

- (1) IN COMPLIANCE 100 FOOT RELIEF GRANTED BY VARIANCE BY THE FAIRHAVEN ZONING BOARD OF APPEALS AND RECORDED AT THE BRISTOL SOUTH COUNTY REGISTRY OF DEEDS ON 8-9-19 IN BOOK 12886, PAGE 348.
- (2) BASED UPON EXISTING SITE FEATURES, PROPOSED RACKING SUPPORT FOUNDATION SYSTEM AND PROPOSED CONCRETE EQUIPMENT PADS.
- (3) SEE PROPOSED LARGE SCALE GROUND MOUNTED SOLAR PHOTOVOLTAIC INSTALLATIONS TABLE FOR ADDITIONAL SETBACK REQUIREMENTS.

LARGE SCALE GROUND MOUNTED SOLAR PHOTOVOLTAIC INSTALLATIONS		
MINIMUM LOT AREA:	REQUIRED 10 ACRES (1)	PROVIDED ±46 ACRES
MINIMUM YARDS:		
FRONT:	75 FEET	144.8 FEET
SIDE:	50 FEET	51.0 FEET
REAR:	50 FEET	293.6 FEET

(1) MINIMUM REQUIRED IN RR DISTRICT.

SEE SHEET 6 FOR CONSTRUCTION NOTES

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P.O. Box 1051, Sandwich, MA 02563 (508) 888 - 9282

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 Survey chk. by : _____
 Approved by : _____


SCALE
SCALE 1" = 80'
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NO.	BY	DATE	REVISION
2	SWG	9-24-19	PER CONCOM COMMENTS
1	JCE	9-11-19	UPDATED BUFFER ZONES PER CONCOM

APPLICANT:
FAIRHAVEN MA 4, LLC
 c/o CLEAN ENERGY COLLECTIVE, LLC.
 27 B MIDSTATE DR, SUITE 106
 AUBURN, MASSACHUSETTS 01501

OVERALL SITE DEVELOPMENT PLAN
 FOR
46 CHARITY STEVENS LANE SOLAR PROJECT
 FAIRHAVEN, MASSACHUSETTS
 AUGUST 23, 2019

FILE: 3119.01-SITE-R2
 Sheet 3 of 6
 JOB NUMBER 3119.01

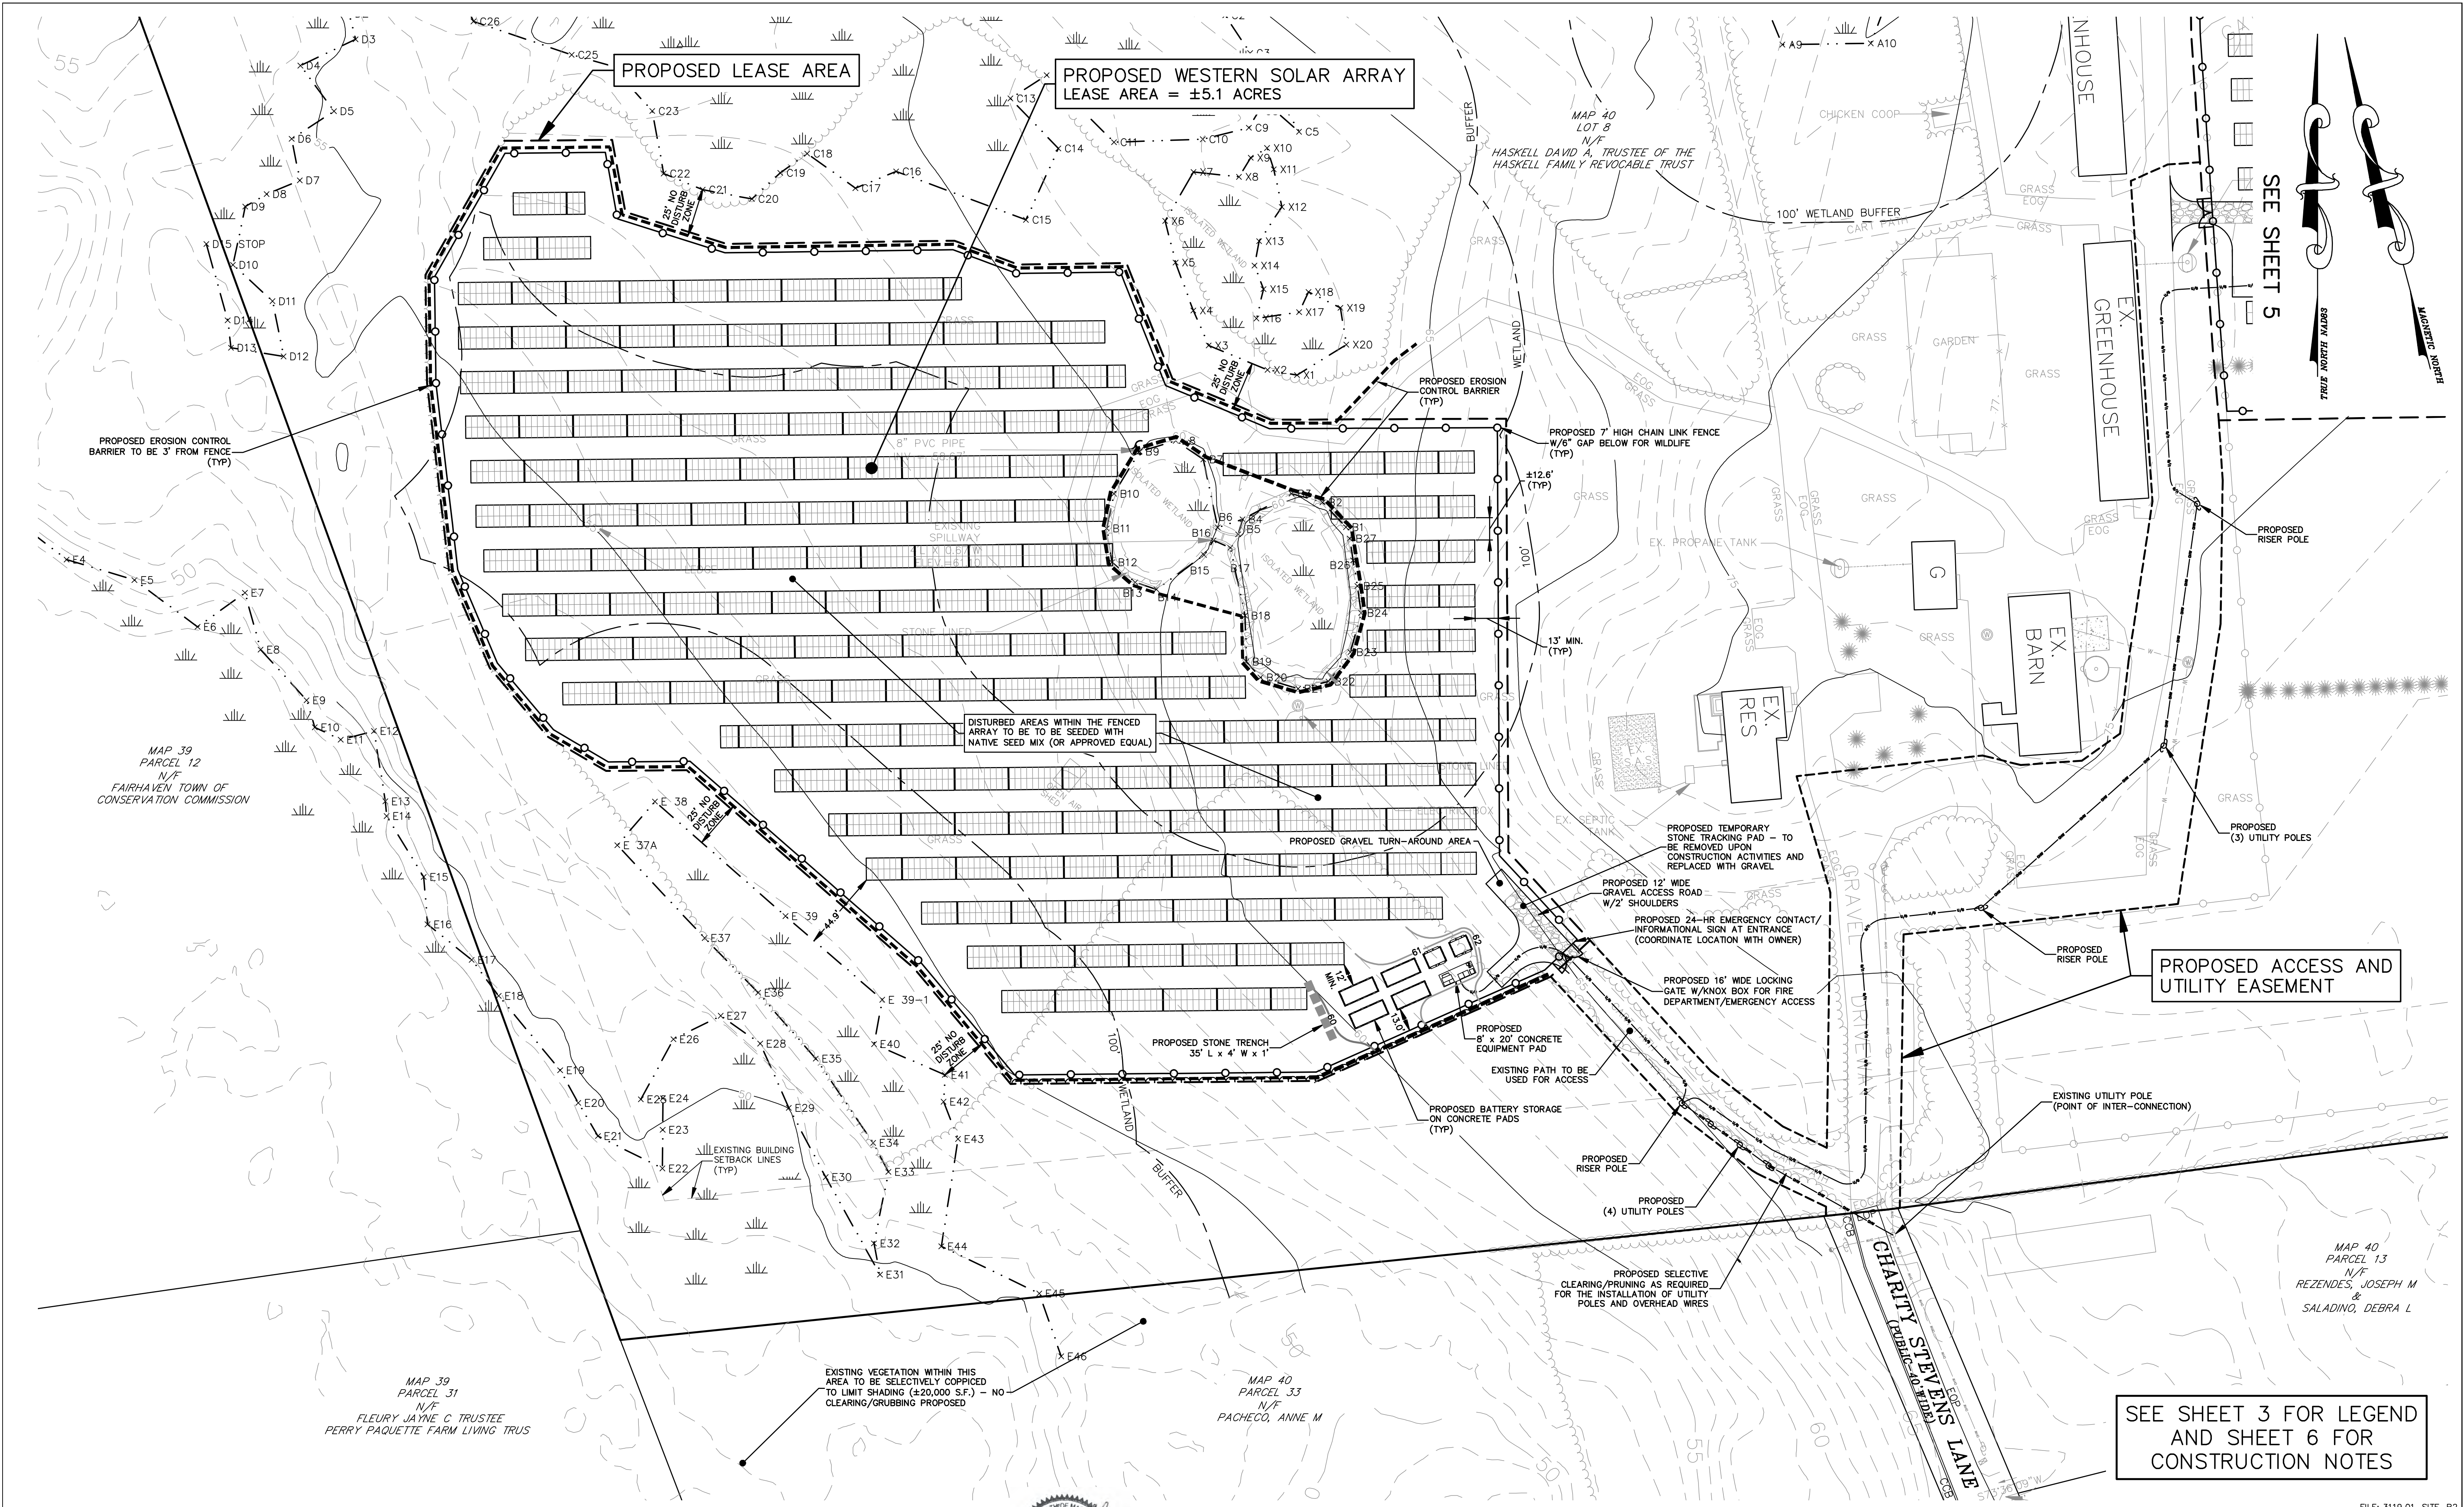


Atlantic DESIGN ENGINEERS, INC.
 P.O. Box 1051, Sandwich, MA 02563 (508) 888 - 9282

Designed by : _____
 Drawn by : _____
 Checked by : _____
 Survey chk. by : _____
 Approved by : _____

SCALE
 SCALE 1" = 40'
 0 10 20 40 80

NO.	BY	DATE	REVISION
2	SWG	9-24-19	PER CONCOM COMMENTS
1	JCE	9-11-19	UPDATED BUFFER ZONES PER CONCOM

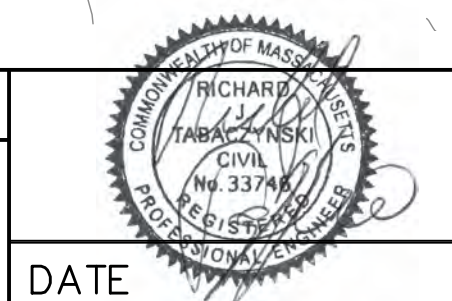


APPLICANT:
FAIRHAVEN MA 4, LLC
 c/o CLEAN ENERGY COLLECTIVE, LLC.
 27 B MIDSTATE DR, SUITE 106
 AUBURN, MASSACHUSETTS 01501

SITE DEVELOPMENT PLAN
 FOR
46 CHARITY STEVENS LANE SOLAR PROJECT
 FAIRHAVEN, MASSACHUSETTS
 AUGUST 23, 2019

FILE: 3119.01-SITE-R2
 Sheet 4 of 6
 JOB NUMBER 3119.01

SEE SHEET 3 FOR LEGEND
 AND SHEET 6 FOR
 CONSTRUCTION NOTES

SEE SHEET 5

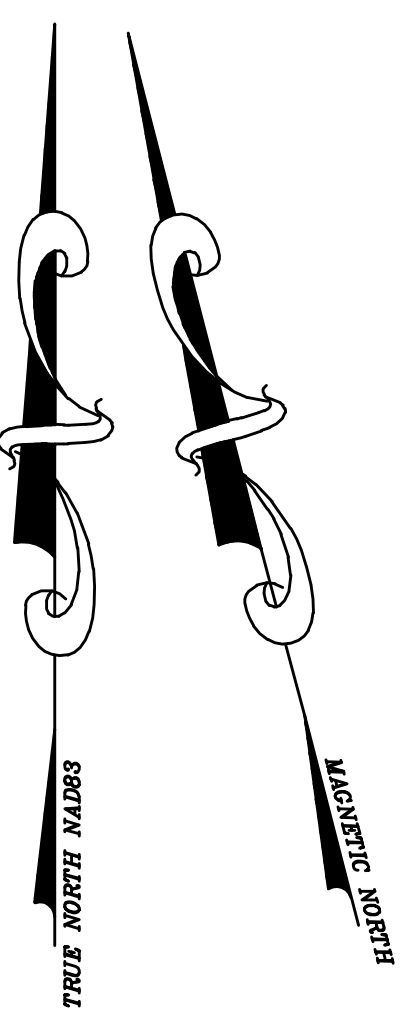

MAP 39
 PARCEL 31
 N/F
 FLEURY JAYNE C. TRUSTEE
 PERRY PAQUETTE FARM LIVING TRUS

MAP 39
 PARCEL 12
 N/F
 FAIRHAVEN TOWN OF
 CONSERVATION COMMISSION

MAP 40
 PARCEL 33
 N/F
 PACHECO, ANNE M

MAP 40
 PARCEL 13
 N/F
 REZENDES, JOSEPH M
 &
 SALADINO, DEBRA L

MAP 40
 LOT 8
 N/F
 HASKELL DAVID A. TRUSTEE OF THE
 HASKELL FAMILY REVOCABLE TRUST

PROPOSED WESTERN SOLAR ARRAY
LEASE AREA = ±5.2 ACRES

SOLAR ARRAY AREA UNDER AND IN
BETWEEN PANELS TO BE TO BE
SEEDED WITH NATIVE SEED MIX
(OR APPROVED EQUAL)

EXISTING BUILDING
SETBACK LINE
(TYP)

PROPOSED EROSION CONTROL
BARRIER TO BE 3' FROM FENCE
(TYP)

MAP 40
PARCEL 26F
N/F
STEPHEN HILLS COMMUNITY
SERVICE INC

PROPOSED CLEARING/GRUBBING
(±45,000 S.F.)

PROPOSED TEMPORARY ROW OF
EROSION CONTROL TO BE REMOVED
UPON COMPLETION OF CLEARING ACTIVITIES

PROPOSED LEASE AREA

EX.
GARAGE



EX.
GREENHOUSE

EX.
GREENHOUSE

SEE SHEET 4

PROPOSED ACCESS AND
UTILITY EASEMENT

SEE SHEET 3 FOR LEGEND
AND SHEET 6 FOR
CONSTRUCTION NOTES

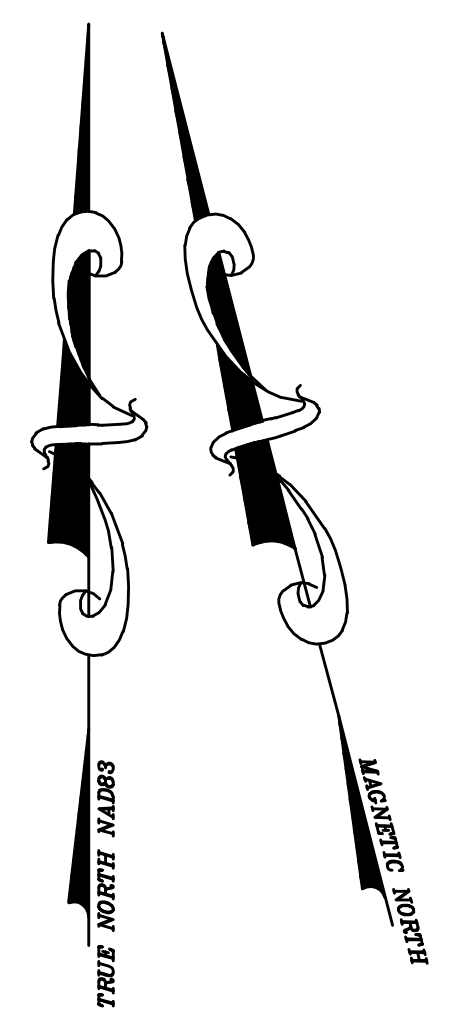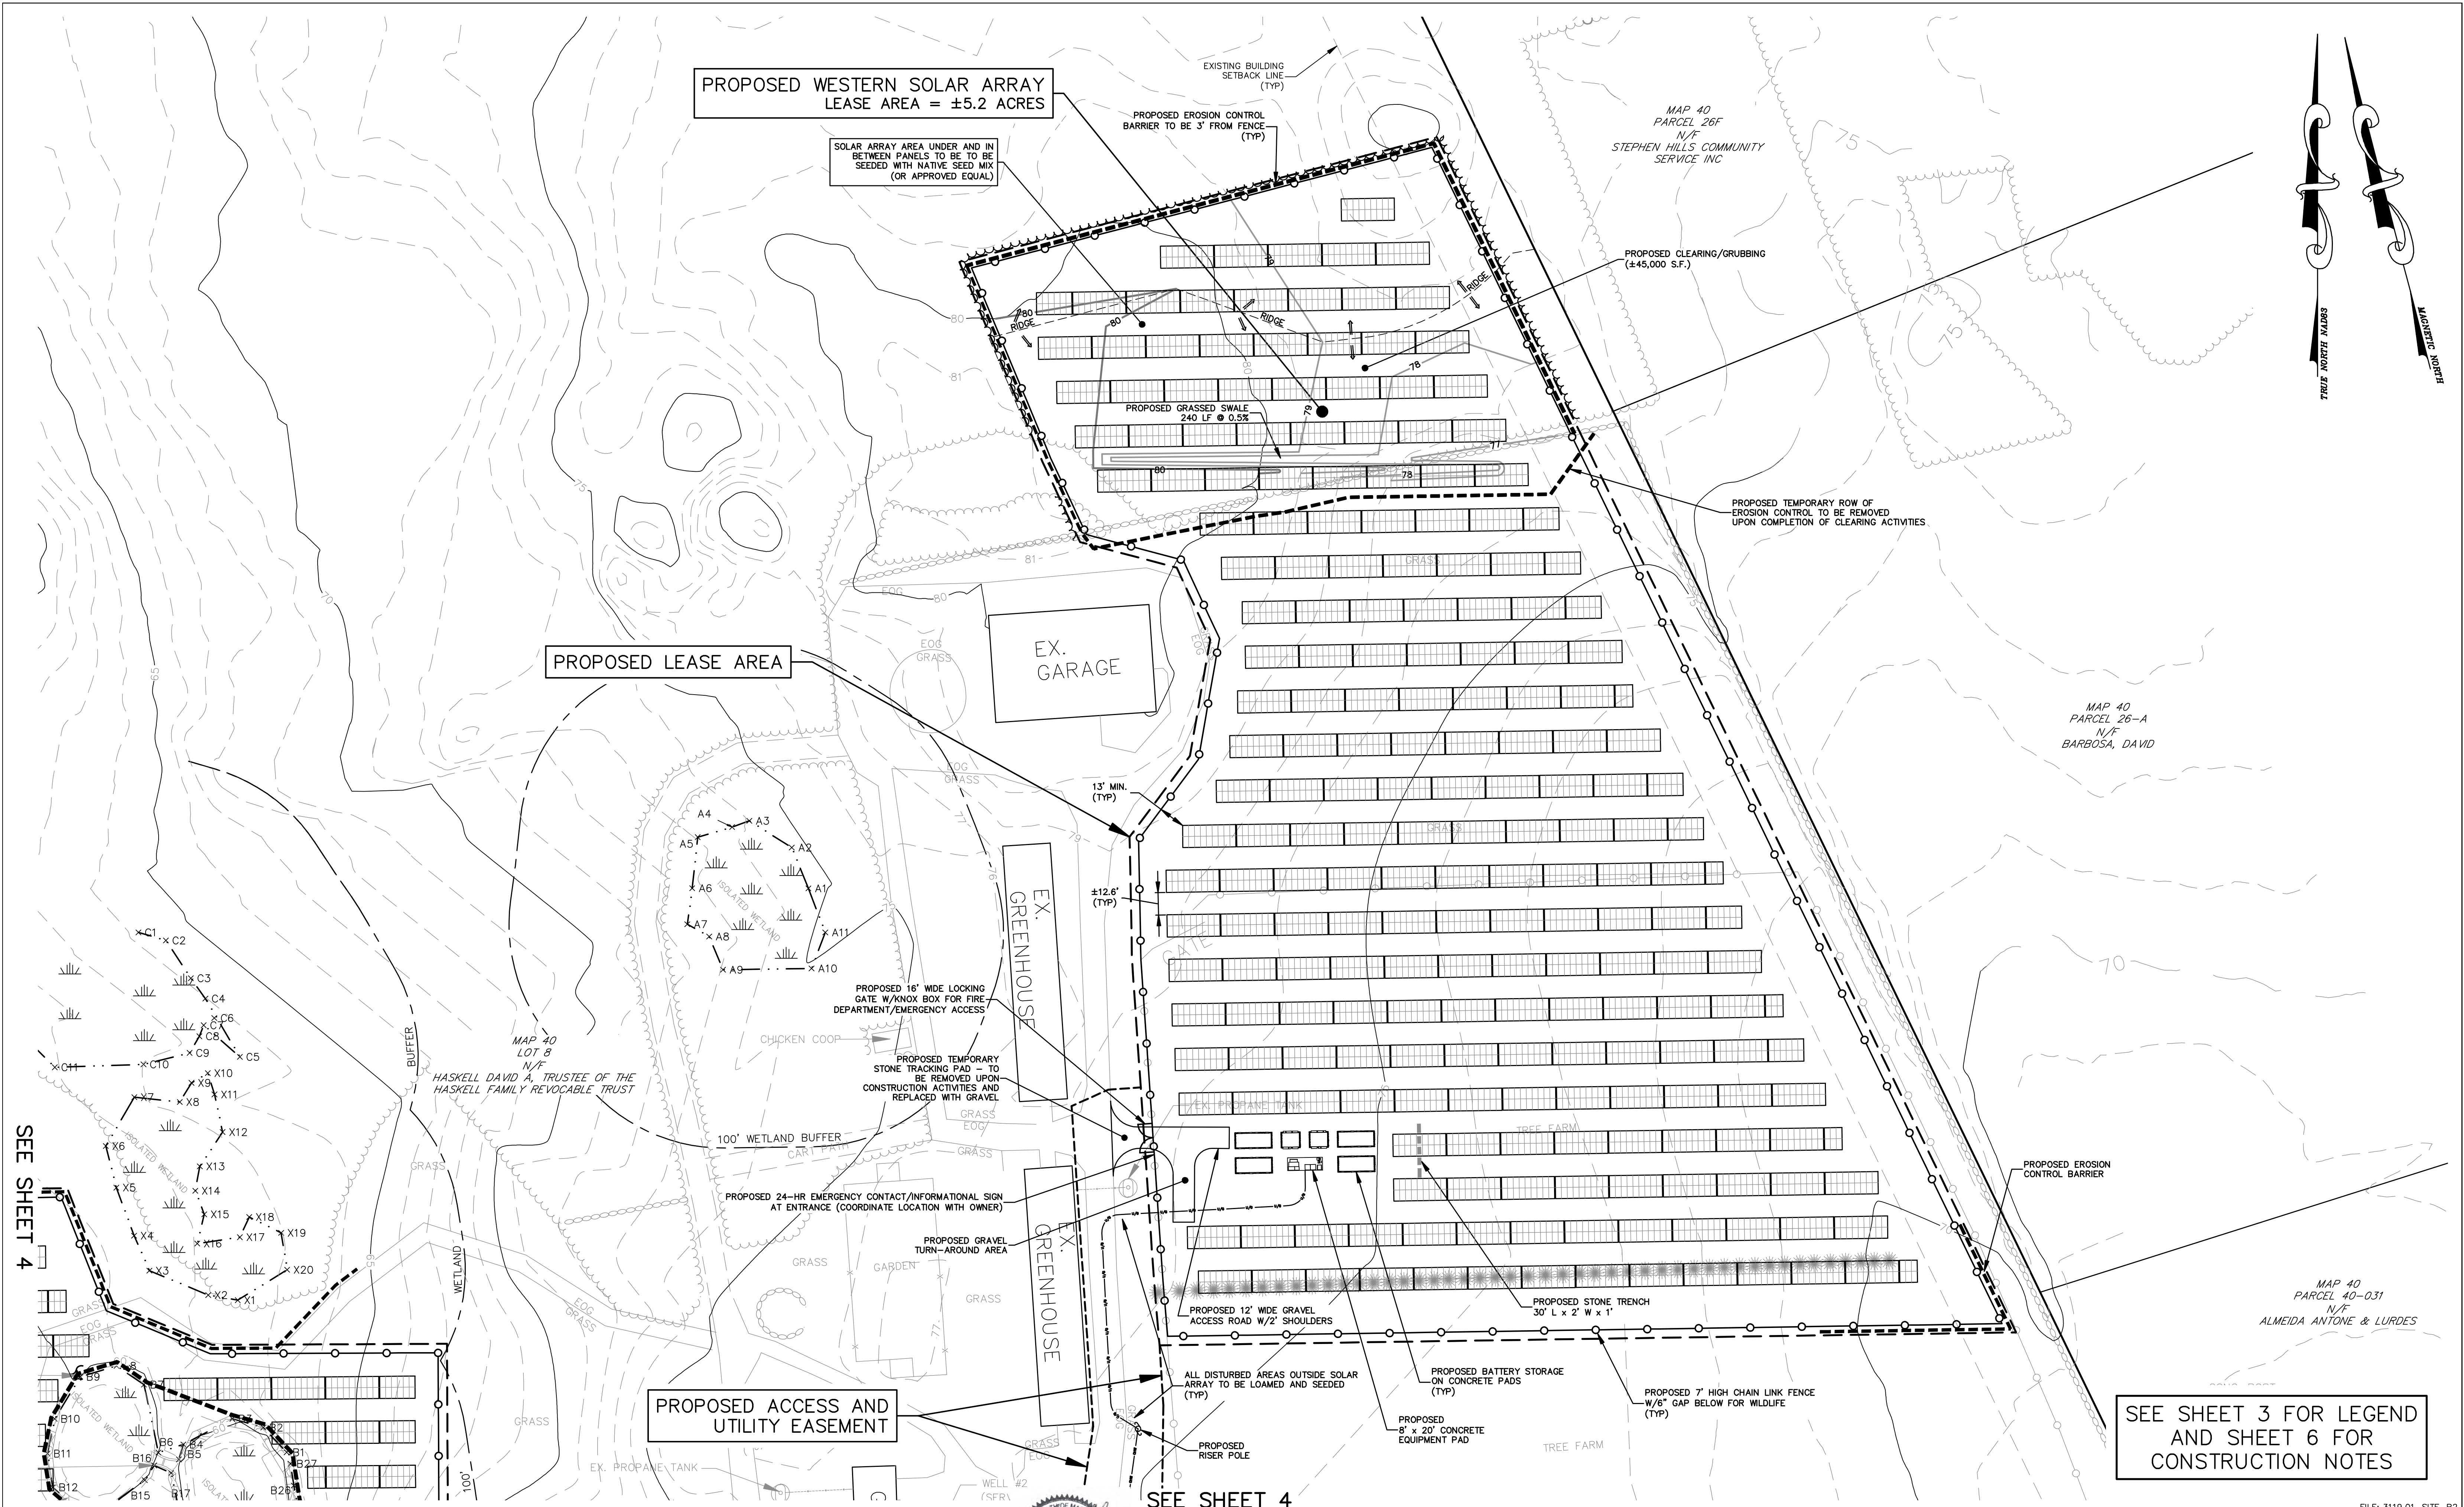

SEE SHEET 4

Atlantic DESIGN ENGINEERS, INC.
P.O. Box 1051, Sandwich, MA 02563 (508) 888 - 9282

Designed by : _____
 Drawn by : _____
 Checked by : _____
 Survey chk. by : _____
 Approved by : _____

SCALE
SCALE 1" = 40'
0 10 20 40 80

NO.	BY	DATE	REVISION
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1	JCE	9-11-19	UPDATED BUFFER ZONES PER CONCOM

APPLICANT:
FAIRHAVEN MA 4, LLC
 c/o CLEAN ENERGY COLLECTIVE, LLC.
 27 B MIDSTATE DR, SUITE 106
 AUBURN, MASSACHUSETTS 01501

SITE DEVELOPMENT PLAN
 FOR
46 CHARITY STEVENS LANE SOLAR PROJECT
 FAIRHAVEN, MASSACHUSETTS
 AUGUST 23, 2019

FILE: 3119.01-SITE-R2	Sheet	of
	5	6
	JOB NUMBER	
	3119.01	



Clean Energy COLLECTIVE.




46 Charity Stevens Lane
Fairhaven, MA 02719

24-Hour Emergency Contact #: 844-232-7253

CleanEnergyCo.com

NOTE - SIGNAGE TO CONFORM TO LOCAL SIGNAGE REQUIREMENTS. FINAL SIGN DESIGN TO BE SUBMITTED AS PART OF BUILDING PERMIT APPLICATION PACKAGE.

TYPICAL SITE INFORMATION / 24-HR EMERGENCY CONTACT SIGN (NOT TO SCALE)

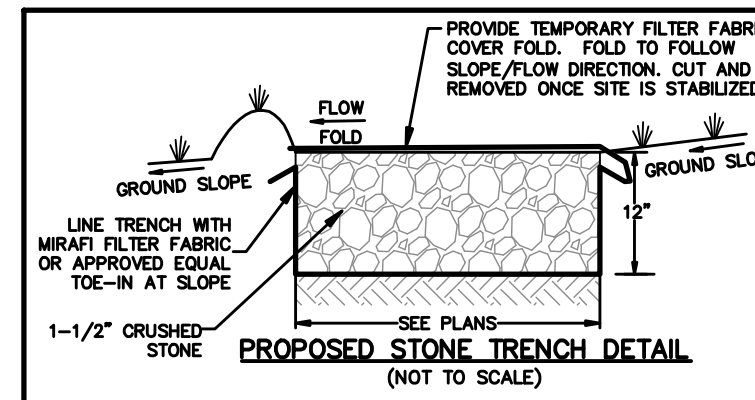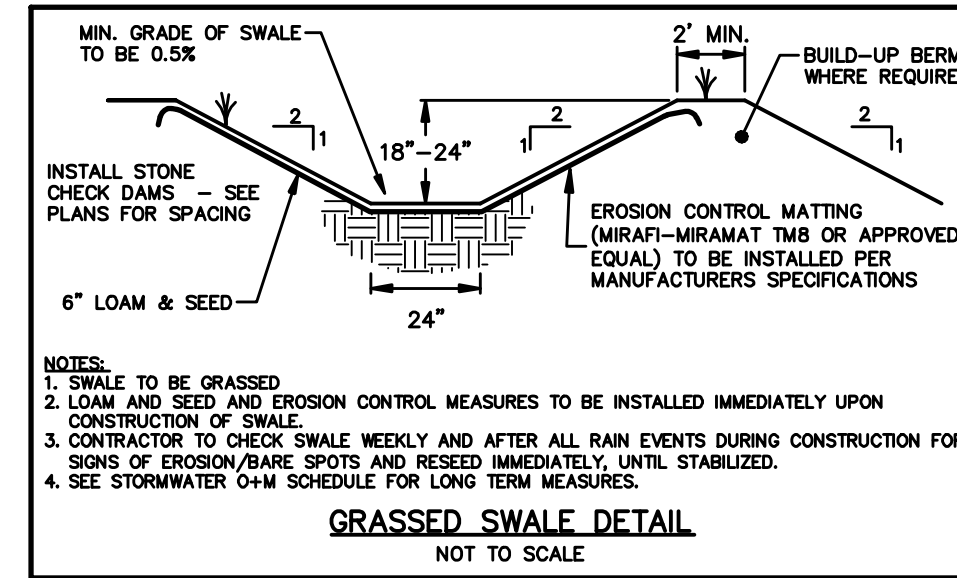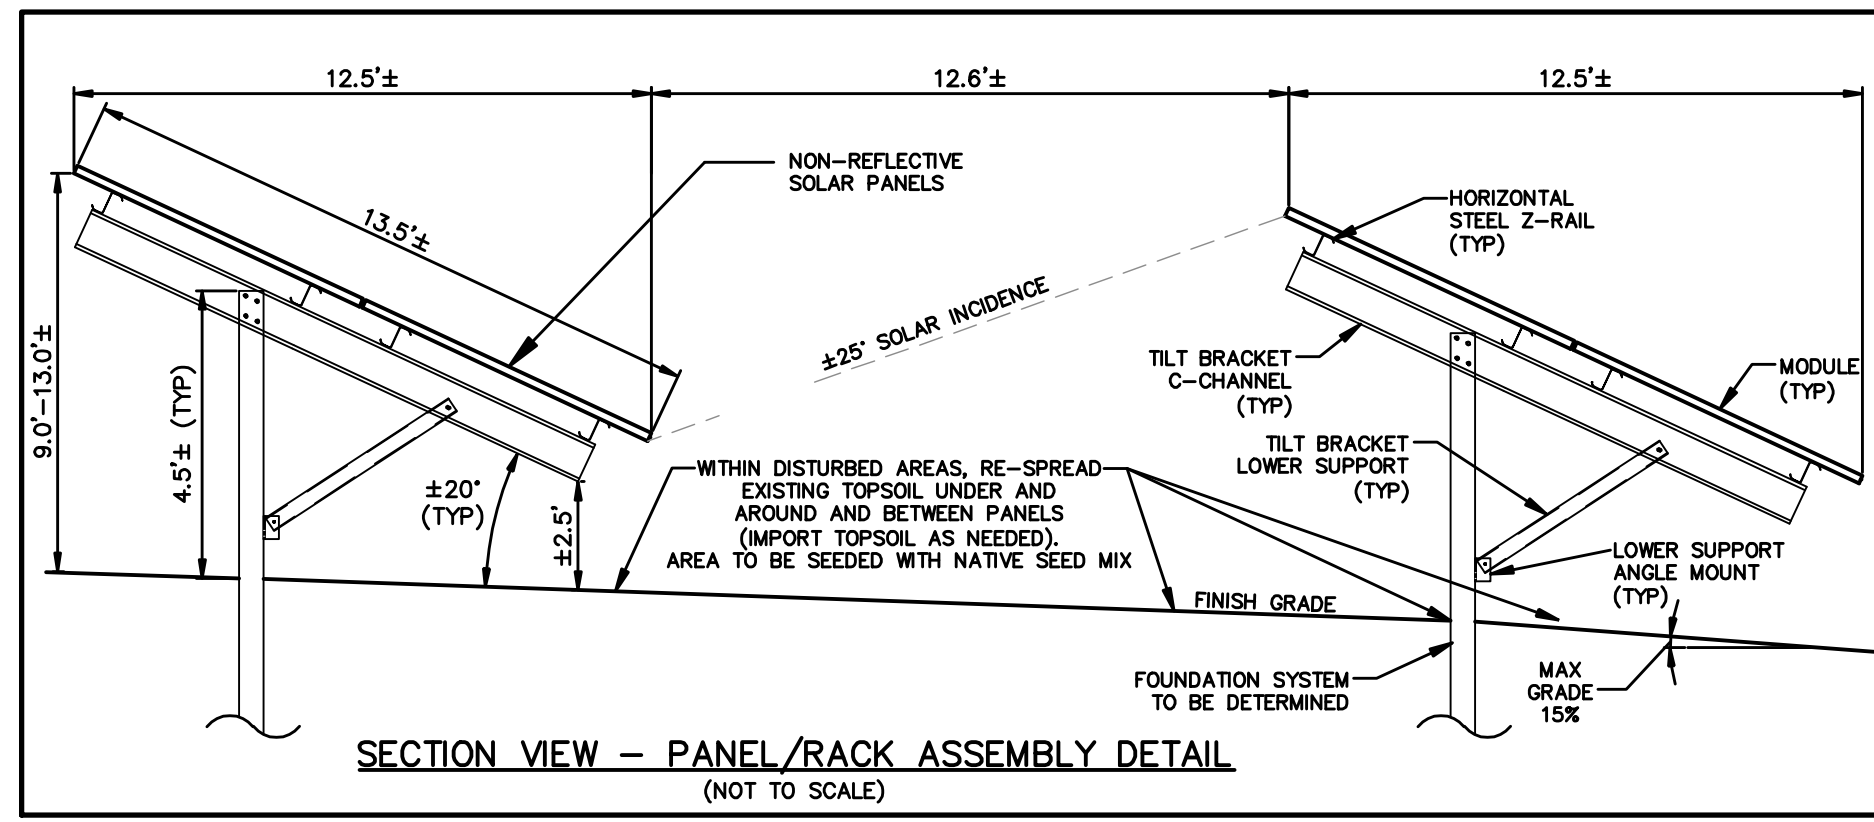

SEDIMENT AND EROSION CONTROL NOTES:





- 1. PRIOR TO COMMENCING SITE WORK OR EARTHWORK OPERATIONS, INSTALL SEDIMENT CONTROL BARRIERS AND MAINTAIN THROUGHOUT CONSTRUCTION.
2. ALL DISTURBED AREAS SHALL BE LOADED AND SEEDED IMMEDIATELY UPON COMPLETION OF CONSTRUCTION.
3. ALL MATERIALS AND STOCKPILES SHALL BE STORED ON LEVEL AREAS OUTSIDE OF ANY FLOOD ZONES, WETLANDS OR BUFFER ZONE AREAS...

CONSTRUCTION PERIOD STORMWATER OPERATION AND MAINTENANCE:

- SCHEDULE:
SEDIMENT CONTROL BARRIERS: SEDIMENT CONTROL BARRIERS (SILT SOCK, ETC.) SHOULD BE INSPECTED IMMEDIATELY AFTER EACH RUN-OFF PRODUCING RAINFALL EVENT AND AT LEAST DAILY DURING PROLONGED RAINFALL.
STONE TRACKING PADS: THE CONSTRUCTION ENTRANCE TRACKING PADS SHOULD BE MAINTAINED IN A CONDITION THAT WILL PREVENT TRACKING OR FLOW OF SEDIMENT ONTO THE PUBLIC RIGHT-OF-WAY...

CONSTRUCTION NOTES:

- 1. THE PROPERTY LINES FOR MAP 40 LOT 8.0 SHOWN HEREON, ARE A RESULT OF A BOUNDARY SURVEY COMPILED BY ATLANTIC DESIGN ENGINEERS IN JUNE 2019 AND PLANS AND DEEDS RECORDED IN BRISTOL COUNTY SOUTH REGISTRY OF DEEDS.
2. EXISTING CONDITIONS DEPICTED HEREON ARE BASED UPON A PARTIAL FIELD SURVEY BY ATLANTIC DESIGN ENGINEERS IN JUNE 2019...

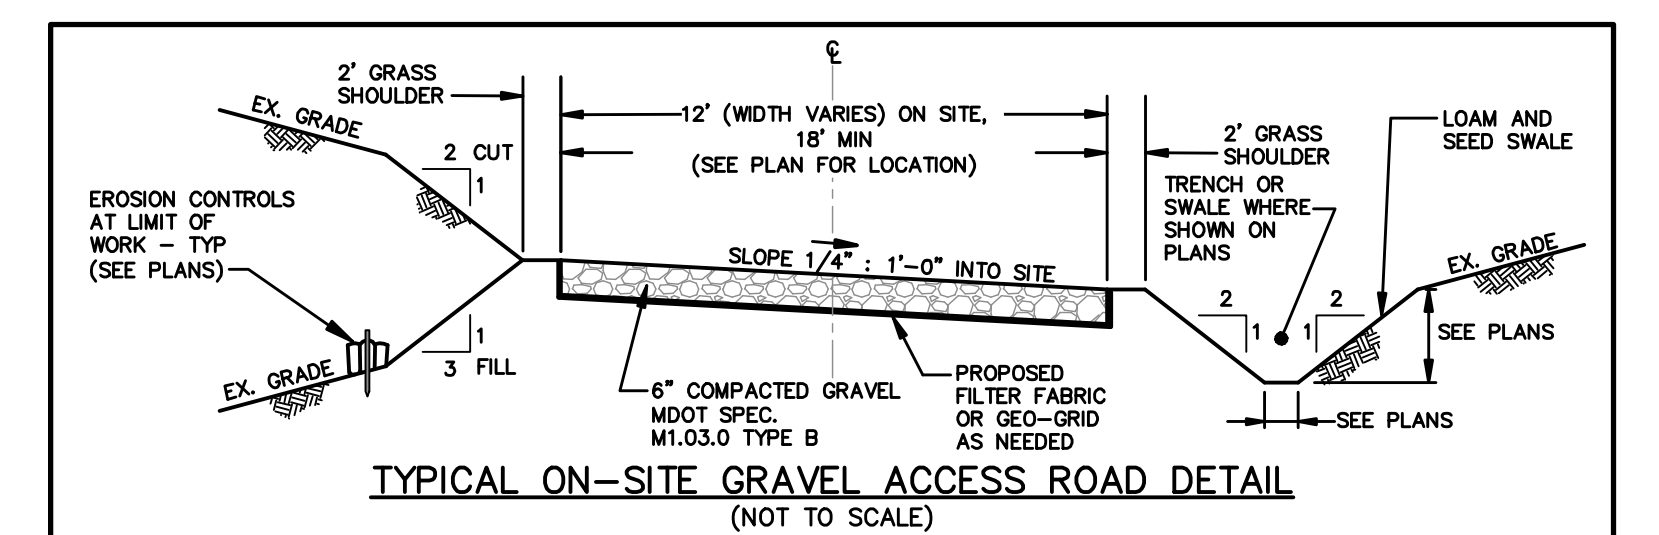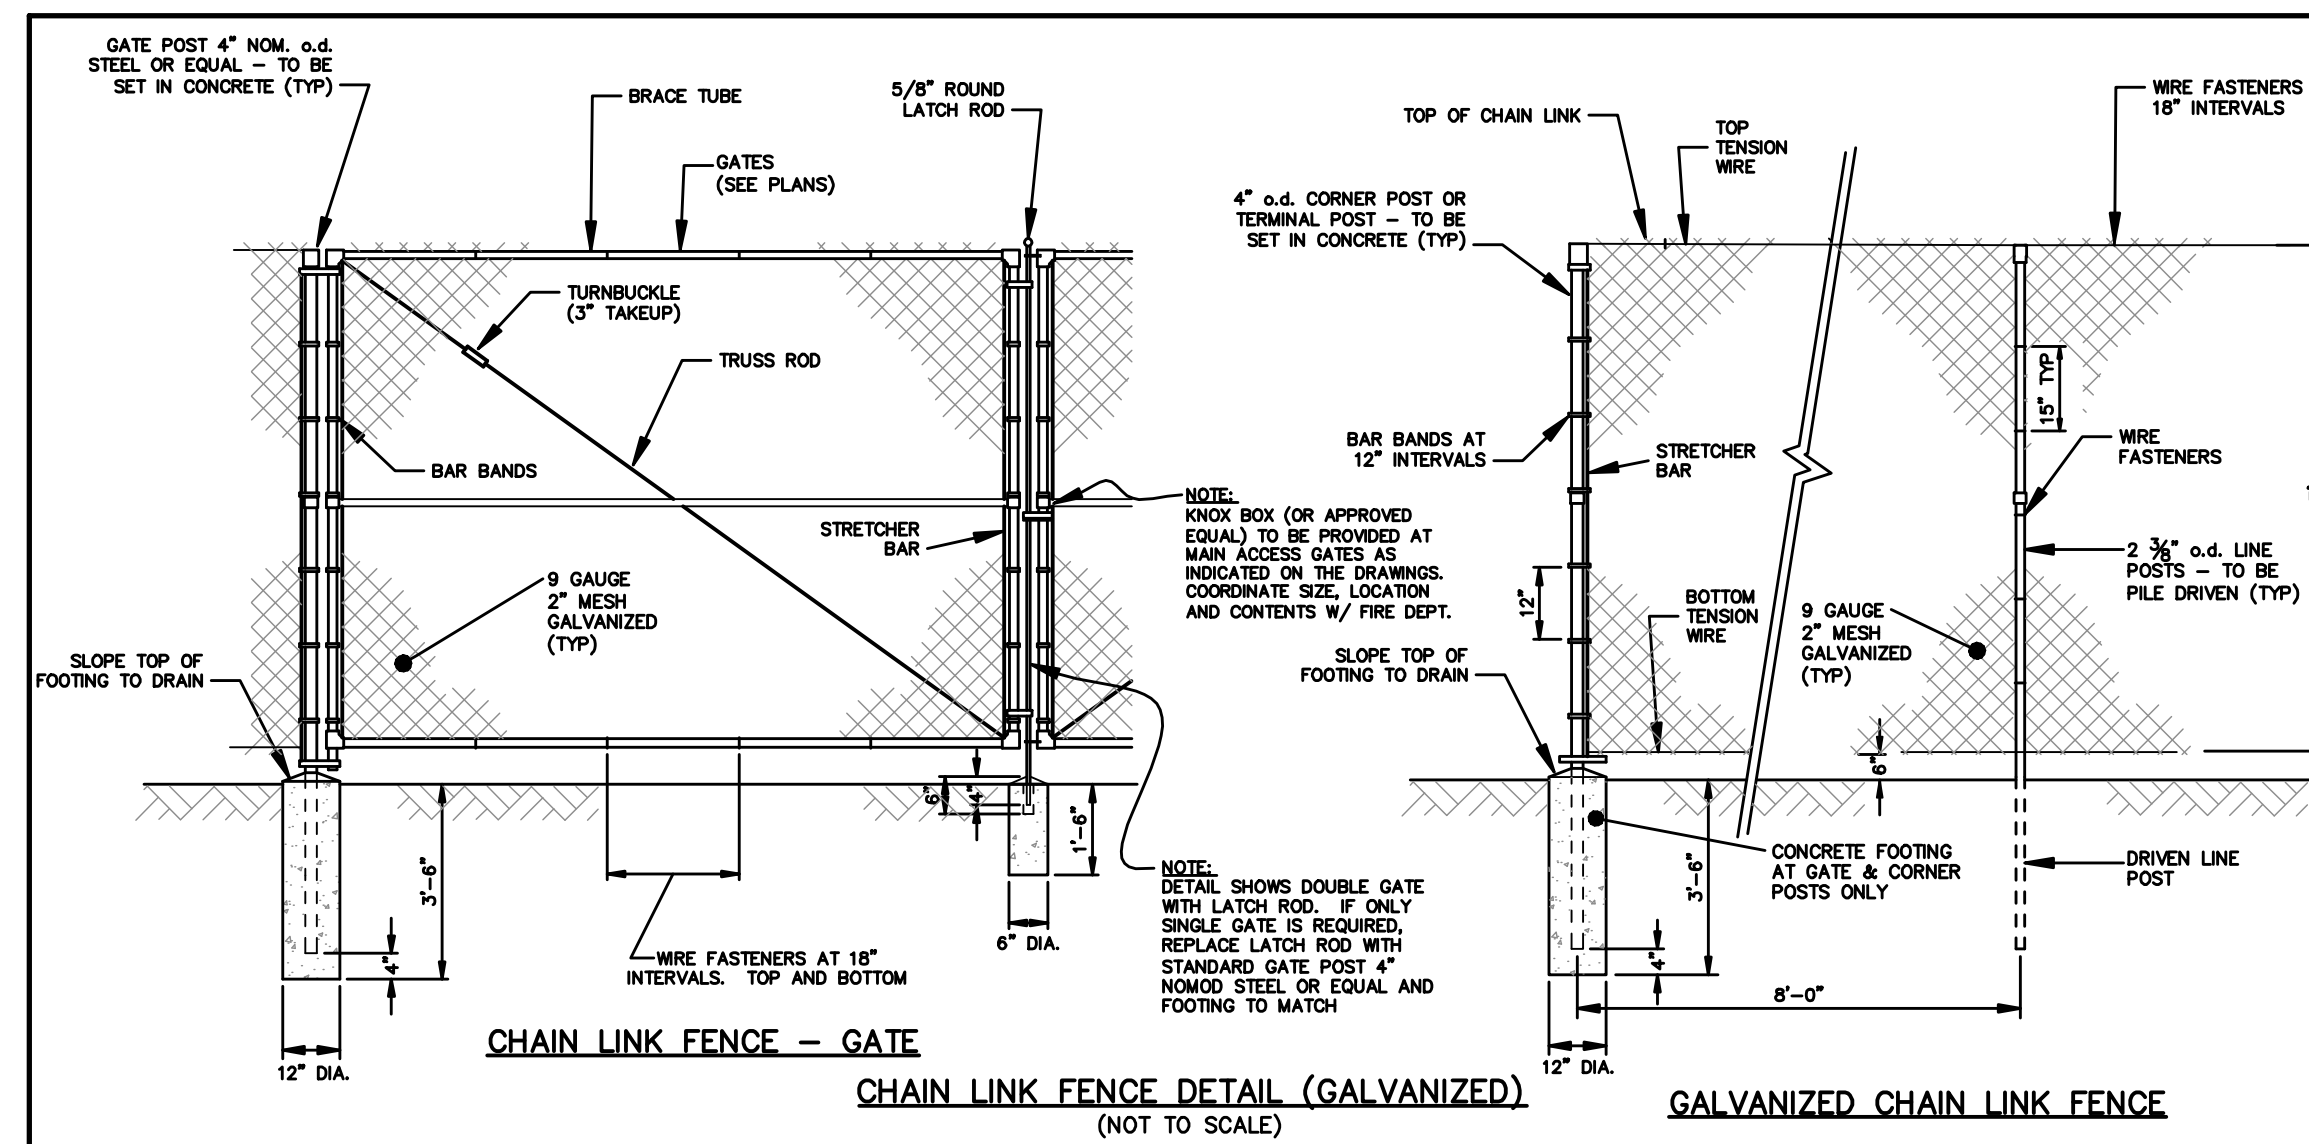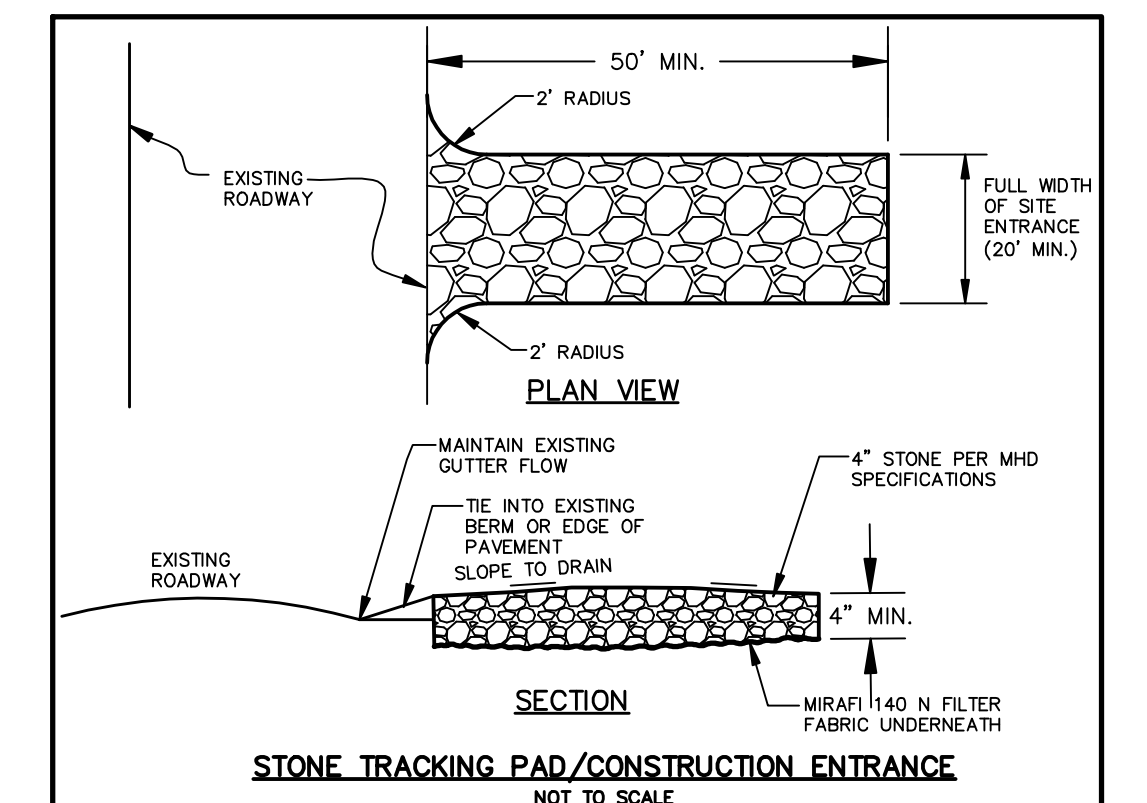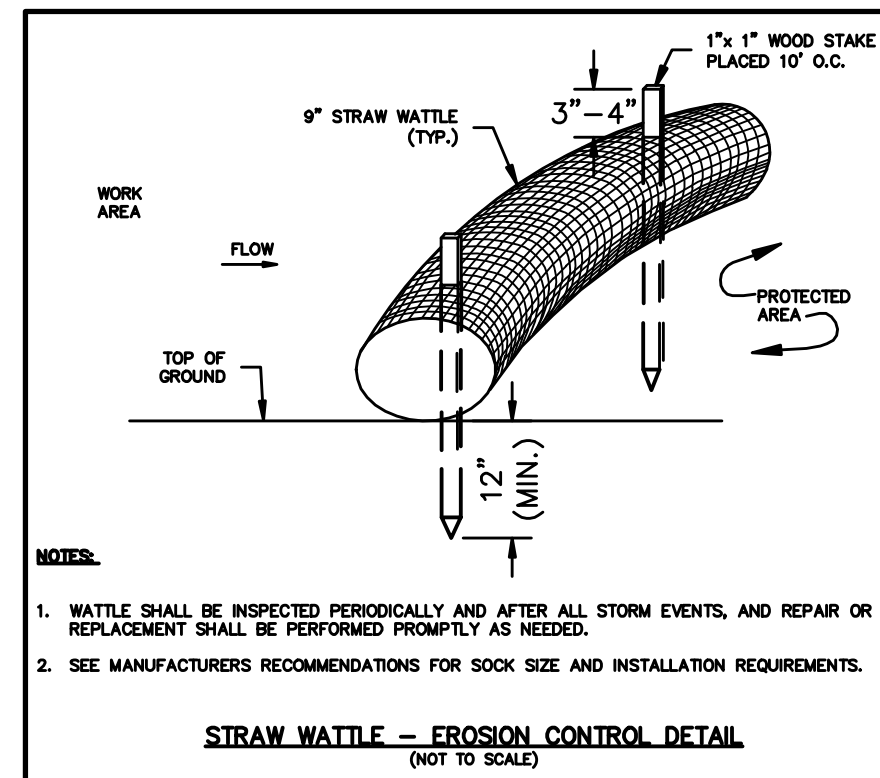

Required Recharge Volume-R1

Design Engineer:	Atlantic Design Engineers, INC	Job No.:	3119.01
Project Name:	46 CHARITY STEVENS LANE SOLAR PROJECT	Calc'd By:	PMJ
Location:	Fairhaven, MA	Date:	9/24/2019

The groundwater recharge volume is required for the proposed **impervious** surfaces.

$$R_v = (F) (A_{imp})$$

R_v = Required Recharge Volume
 A_{imp} = Impervious Area on site
 F = Target Depth Factor: 0.60 inch for A soils and 0.25" for C soils

Subcatchment Area: 1S

Total New Impervious Area for the Design Point=	1,100	sf			
Required Recharge Volume (Rv)=	1,100	* 0.60" * (1/12)=	55.00	cf	
Volume Provided in stormwater BMP=			56.00	cf	Infiltration Trench (4' x 1' D x 35' L) 40% Voids

Subcatchment Area: 2S

Total New Impervious Area for the Design Point=	1,100	sf			
Required Recharge Volume (Rv)=	1,100	* 0.25" * (1/12)=	22.91	cf	
Volume Provided in stormwater BMP=			24.00	cf	Infiltration Trench (2' x 1' D x 30' L) 40% Voids

Total Required Recharge Volume on Site=	55.00	cf
Total Recharge Volume Provided in stormwater BMPs on Site=	56.00	cf

46 Charity Stevens Lane Solar Project

At

46 Charity Stevens Lane, Fairhaven, MA 02719

Post-Construction

Long Term Stormwater Operation & Maintenance Plan

Revised 9/24/19

A. GENERAL NOTES

1. The contractor shall be responsible for the proper inspection and maintenance of all stormwater and erosion control facilities until the project construction is completed. The contractor shall clean all components of the stormwater management system at the completion of construction, immediately prior to turning over operation and maintenance responsibility to the owner. Erosion control should be removed after the vegetation meets the established standards.
2. Upon completion of construction, the operation and maintenance of all components of the stormwater management system will be the responsibility of the system owner:

**Fairhaven MA 4, LLC
c/o Clean Energy Collective, LLC
27B Midstate Drive, Suite 106
Auburn, MA 01501**

Signature

Date

3. The owner/contractor shall file an inspection report with the Town of Fairhaven Conservation Commission following each site inspection as recommended in the Operation & Maintenance (O&M) Schedule. The inspection report shall identify the date of inspection, name, and contact number of responsible party, specific structures inspected, specific maintenance and/or repairs required and general observations. Any deficiencies noted in the inspection report shall be corrected to the Town of Fairhaven Conservation Commission's satisfaction.
4. Disposal of accumulated sediment and hydrocarbons to be in accordance with the applicable local, state, and federal guidelines and regulations.

5. There shall be no illicit discharge of any waste or waste water into the stormwater management system. The maintenance of the facility shall be undertaken in such a manner as to prevent any discharge of waste or waste water into the stormwater management system. Any waste oil or other waste products generated during the maintenance shall be properly disposed of offsite.

Signature – Fairhaven MA4, LLC

Date

B. STORMWATER SYSTEM/BMPs

Erosion Control Barriers:

Erosion control barriers (haybales, silt fence, etc.) should be inspected immediately after each run-off producing rainfall event and at least daily during prolonged rainfall. Sediment deposits must be removed when the level of deposition reaches approximately one-half the height of the barrier. Sediment shall be disposed of in a suitable area and protected from erosion by either structural or vegetative means. Erosion control should be removed after the vegetation meets the established standards.

Stone Trench:

Inspect after every major storm event (2" or greater) during construction. Once site is stabilized and re-vegetated, cut away/remove temporary cover fold and inspect and for the first few months after construction to ensure proper stabilization and function, thereafter inspect at least twice per year during wet weather to ensure the system is working properly. Remove sediment as necessary during construction and at least every five years after construction. Once construction is completed check for accumulation of sediment, debris and leaf litter at least twice a year thereafter.

Grassed Swale:

During construction grassed lined swales shall be inspected immediately after each run-off producing rainfall event and at least daily during prolonged rainfall. After construction, inspect at a minimum of twice a year, or after major storm events (2" or greater). Repair eroded spots immediately after inspection. Additional inspections should be scheduled during the first few months to ensure that the vegetation in the channels is established adequately. Accumulated sediment shall be removed at least once a year or before it exceeds 0.5' in depth, whichever occurs first. Swales shall be mowed as needed. Clippings to be removed from swales, areas immediately up-gradient and properly disposed of.

Vegetated Areas:

The state of vegetation within the project area will be inspected during normal maintenance visits a minimum of twice per year. Vegetated areas within the arrays will be mowed to maintain a grass height of approximately 12 inches. Use of a weed whacker is recommended underneath the panels and around the posts of the racking system. Woody seedlings may also be removed by hand. The inspector shall monitor the ground cover growth rate and areas of erosion or bare soil will be repaired immediately after inspection. The state of vegetation outside of the fenced in solar development area will be monitored to confirm that excessive growth which will result in shading of the solar panels has not occurred. If shading is visible, the area will be trimmed/cut as necessary. The use of herbicides, pesticides, fertilizers or chemicals for maintenance of vegetation throughout the array and outside the fence is prohibited.

C. ESTIMATED ANNUAL BUDGET

The estimated annual budget for the activities required in this Long-Term Stormwater Operation and Maintenance Plan is \$1,000.00.

D. SAMPLE OPERATION AND MAINTENANCE LOG

(Next Page)

SAMPLE OPERATION AND MAINTENANCE LOG

**46 CHARITY STEVENS LANE SOLAR PROJECT
FAIRHAVEN, MASSACHUSETTS**

LONG TERM STORMWATER OPERATION & MAINTENANCE PLAN

Date: _____ Personnel Present: _____	

Inspectors Name: _____	
Inspectors Contact Information: _____	

Signature: _____	

O&M ITEM:	COMMENTS, CORRECTIVE ACTION NEEDED, AND NOTES:
Erosion Control Barriers	
Stone Trench	
Grassed Swales	
Vegetated Areas	
Other	
Other	
Other	